

NOTICE OF REQUIREMENT FOR ALTERATION TO A DESIGNATION

Waka Kotahi NZ Transport Agency
Weigh Right Programme – (SH1) Rakaia

27 MAY 2022



NOTICE OF REQUIREMENT FOR AN ALTERATION OF A DESIGNATION PURSUANT TO SECTION 181(3) OF THE RESOURCE MANAGEMENT ACT 1991

FORM 18

To: Selwyn District Council
PO Box 90
Rolleston 7643

From: Waka Kotahi NZ Transport Agency
PO Box 1479
Christchurch 8140

Note: Different address for service.

Pursuant to Section 181(3) of the Resource Management Act 1991 (RMA) Waka Kotahi NZ Transport Agency (Waka Kotahi) gives notice of its requirement to alter a designation.

Waka Kotahi is a network utility operator approved as a requiring authority under Section 167 of the RMA. The relevant Gazette Notices are:

- Resource Management (Approval of NZ Transport Agency as a Requiring Authority) Order 1992 (NZ Gazette, Notice Number 1994-go1500) – and refer Schedule 2, Clause 29 of the Land Transport Management Act 2003 which confirms that the order applies to NZ Transport Agency
- Resource Management (Approval of NZ Transport Agency as a Requiring Authority) Notice 2015 (NZ Gazette, Notice Number 2015-go6742) – which confirms the NZ Transport Agency as a requiring authority for the purpose of constructing or operating (or proposing to construct or operate) and maintaining cycleways and shared paths.

The designations to be altered:

The designations to be altered are Designation TR7 in the Operative Selwyn District Plan (Operative SDP), and corresponding Designation NZTA-7 Rakaia Commercial Vehicle Safety Centre (hereon ‘NZTA-7’) within the Proposed Selwyn District Plan (Proposed SDP).

The nature of the alteration:

Waka Kotahi propose to undertake a minor alteration to the existing Designation TR7 in the Operative SDP. The proposed alteration seeks to remove the following condition from the designation:

“General Accordance with details provided in the NOR and plans attached in D190066 Appendix C updated 17/02/2020; the Addendum to the NOR 17/02/2020; and the response to the request for further information 27/03/2020.”

Additionally, Waka Kotahi proposed to undertake a minor alteration to the existing Designation NZTA-7 in the Proposed SDP. The proposed alteration seeks to remove the following condition from the designation:

“General Accordance

1. *The designation shall be implemented in general accordance with the details provided with the Notice of Requirement:*
 - a. *The Plans attached in Appendix C of the Notice of Requirement dated 17/02/2020;*
 - b. *The Addendum to the Notice of Requirement dated 17/02/2020;*
 - c. *The response to the request to the further information dated 27/03/2020; and*
 - d. *The response to the request for further information dated 17/04/2020.”*

The site to which the requirement applies:

The location of the site for which the proposed alteration to a designation relates to is shown on the plans attached as Appendix A of this Notice. This requirement applies to an area of land approximately 28,620m² or 2.86 hectares located at the junction of State Highway 1 and North Rakaia Road, Bankside. The requirement applies to the following land:

| Address | Legal Description | Parcel Size | Landowner |
|------------------------------------|---------------------|-------------------------------|--|
| Junction SH1 and North Rakaia Road | Rural Section 33582 | 23,000m ² / 2.3 ha | Waka Kotahi (New Zealand Transport Agency) |
| North Rakaia Road | Parcel ID 3576329 | N/A | Selwyn District Council |

The nature of the proposed public work:

Waka Kotahi are proposing to undertake a minor alteration to existing Designation TR7 in the Operative SDP, and corresponding Designation NZTA-7 within the Proposed SDP.

The alteration to the designation conditions in both the Operative SDP and Proposed SDP will facilitate the proposed works associated within the construction, operation, and maintenance of a Commercial Vehicle Safety Centre (CVSC) at the site. The proposed CVSC is smaller in scale and intensity than that previously approved and shown in the plans lodged with the previous NOR and Outline Plan application referenced in the existing conditions of the designation.

The proposed works are described in Section 7 of the accompanying Assessment of Effects of the Environment (AEE) Report and Section 8 of the proposal description for the Outline Plan of Works.

In summary, the proposed works include:

- Construction of a CVSC to capture southbound commercial vehicles only.
- Construction of a Tier 1.5 Safety Building
- A CVSC with a significantly reduced size and scale compared with that approved in the Plans of the previous NOR application.

The nature of the proposed conditions that would apply are:

The alteration to designation seeks to remove a condition on Designation TR7 within the Operative SDP and Condition 1 within the Proposed SDP. The other conditions are proposed to remain the same for both designations. Section 4 of the accompanying Assessment of Environmental Effects (AEE) outlines the nature of the conditions which would apply to the site.

The effects of the proposal on the environment, and mitigation of adverse effects:

The effects that removal of the general condition on Designation TR7 in the Operative SDP and Condition 1 of Designation NZTA-7 in the Proposed SDP will have on the environment, and the ways in which any adverse effects will be mitigated are provided in Section 6 of the AEE.

Alternative sites, routes, and methods:

Alternative sites, routes, and methods have not been considered as part of this Notice for an alteration of the existing designation given the minor alterations are proposed to an existing designation.

The public work and alteration are reasonably necessary for achieving the objectives of the requiring authority because:

The objective of Waka Kotahi under Section 94 of the Land Transport Management Act 2003 (LTMA) is to undertake its functions in a way that contributes to an effective, efficient and safe land transport system in the public interest.

The objectives of Waka Kotahi for the proposed CVSC are to:

- Effective enforcement for overweight and unsafe heavy vehicles on the road.
- Reduced wear and maintenance requirements for the road network.
- Fair market conditions for compliant heavy vehicle operators.
- Increased safety of other road network users.

The proposed alteration to the designation is necessary for achieving the objectives of Waka Kotahi because it will:

- Make the transport system safe.
- Keeps the land transport system well maintained to ensure a safer and more reliable network, helping to keep communities connected and supporting economic growth.

The proposed alteration of the designations is reasonably necessary as a planning tool, as it identifies and protects land required for the proposed work and will enable Waka Kotahi to construct, operate, and maintain a CVSC which differs from the original approved plans.

The principal reason for requiring a designation alteration to facilitate the work to which this requirement relates is:

- It will allow for the construction of a CVSC on the site which will provide increased safety for other road network users.

The following resource consents are needed for the proposed activity and have been applied for and granted:

Canterbury Regional Council

- CRC202420 – Discharge Stormwater to Land
- CRC202421 – Discharge Greywater and Wastewater to Land
- CRC202422 – Earthworks over an Aquifer

Selwyn District Council

- RCD19005 – Notice of Requirement to Designate a site at the junction of State Highway 1 and North Rakaia Road, and Outline Plan for the construction of a CVSC

- RC195641 – Construct and Operate a VMS outside of the State Highway 1 Designation TR1
- RC195640 – Outline Plan Waiver to undertake minor works within the State Highway 1 Designation TR1
- RC205208 – Outline Plan for the installation of infrastructure associated with a CVSC

The following resource consents are being obtained for the proposed activity:

Canterbury Regional Council

- S127 Variation to the conditions of CRC202420 and CRC202421

Selwyn District

- Resource consent for the construction and operation of a VMS outside of the State Highway 1 Designation.

The following consultation has been undertaken:

- Selwyn District Council - Transportation Asset Manager

Supporting Information:

Waka Kotahi attaches the following information in support of this Notice.

- An assessment of Environmental Effects on the Environment

Signed by:



Richard Shaw

**Team Lead South – Poutiaki Taiao | Environmental Planning
Transport Services**

Pursuant to authority delegated by Waka Kotahi NZ Transport Agency

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1 INTRODUCTION

1.1 Overview

Waka Kotahi is a Crown entity with its functions, powers and responsibilities set out in the Land Transport Management Act 2003 (LTMA) and the Government Roading Powers Act 1989. Waka Kotahi is also a Requiring Authority under Section 167(3) of the Resource Management Act 1991 (the RMA).

The Waka Kotahi statutory objective as set under the LTMA is to undertake its functions in a way that contributes to an effective, efficient, and safe land transport system in the public interest.

An integrated approach to transport planning, funding, and delivery is taken by Waka Kotahi. This includes exhibiting a sense of cultural, social, and environment responsibility when undertaking its functions.

Waka Kotahi is proposing to alter existing designations to facilitate the construction, operation, and maintenance of a commercial vehicle safety centre (CVSC) within the boundary of Designation TR7 as shown in the Operative Selwyn District Plan (Operative SDP) and Designation NZTA-7 Rakaia Commercial Vehicle Safety Centre (hereon 'NZTA-7) as shown in the Proposed Selwyn District Plan (Proposed SDP).

1.2 Project Background

The Weigh Right Programme (the Programme) combines roadside technology and intelligent software developed to screen heavy vehicles and to direct potentially overweight vehicles into a CVSC for further inspection. The Programme supports Waka Kotahi – the NZ transport Agency 'Road to Zero' strategy which aims to create a road system free of death and serious injury. Waka Kotahi also seek to enable a productive land transport system which supports a level playing field for the heavy vehicle industry. The Weigh Right programme is one way that Waka Kotahi is delivering this.

Vehicle screening involves weigh-in-motion or in-road scales, automatic number plate recognition cameras and electronic signs all working together to identify potentially overweight vehicles. Weigh-in-motion sensors are installed within the road on the approach to CVSCs. The weigh-in-motion sensors and automatic number plate recognition (ANPR) cameras send information to a connected information technology system (ITS) to determine whether a vehicle is potentially overweight by either gross vehicle mass or by axle weight distribution. Information is then displayed on the variable messaging sign(s) (VMS). Vehicles identified as potentially overweight are directed to pull into the CVSC while compliant vehicles continue uninterrupted.

Expected benefits of the Weigh Right Programme are:

- Effective enforcement for overweight and unsafe heavy vehicles on the road.
- Reduced wear and maintenance requirements for the road network
- Fair market conditions for compliant heavy vehicle operators
- Increased safety of other road network users

1.3 Project History

Waka Kotahi previously proposed to construct and operate a CVSC at the junction of State Highway 1 and North Rakaia Road which would capture potentially overweight heavy vehicles travelling in both a

north bound and south bound direction. As part of this project, the following approvals were obtained in 2019/2020.

Canterbury Regional Council

- CRC202420 – Discharge Stormwater to Land
- CRC202421 – Discharge Greywater and wastewater to Land
- CRC202422 – Earthworks over an Aquifer

Selwyn District Council

- RC D19005 – Notice of Requirement to Designate the site at the junction of State Highway 1 and North Rakaia Road, and Outline Plan for the construction and operation of a CVSC
- RC195641 – Construct and Operate a VMS outside of the State Highway 1 Designation
- RC195640 – Outline Plan Waiver to undertake minor works within the State Highway 1 Designation
- RC205208 – Outline Plan for the installation of infrastructure associated with a CVSC

Project Change

Since obtaining the approvals listed above, Traffic Planning Consultants Ltd (TPC) were engaged by Waka Kotahi to carry out a road safety audit to identify safety concerns that may affect the safety and performance of the proposed commercial vehicle safety centre. The audit found that commercial vehicles crossing State Highway 1 posed an unacceptable safety risk. As a result, separate north and south bound CVSC sites are proposed which do not require commercial vehicles to cross over lanes of oncoming traffic.

Waka Kotahi now propose to reduce the size and scale of the previously approved development at the junction of State Highway 1 and North Rakaia Road. The development will now be used as a commercial vehicle safety centre for southbound vehicles only. A separate project will be undertaken in the future to provide a CVSC to capture northbound vehicles at the junction of State Highway 1 and Weavers Road. Waka Kotahi will prepare a separate Notice of Requirement, Outline Plan, and relevant resource consents for this project.

Therefore, for this CVSC southbound project, variations are required to the existing Canterbury Regional Council consents obtained as well as a Notice of Requirement (NOR) to alter the existing designation conditions within both the Operative and Proposed SDP's and an Outline Plan.

1.4 Purpose of Report

This is a combined Notice of Requirement and Outline Plan application for the following:

- A minor alteration to a designation (Designation TR7) in the Operative SDP, and to designation (Designation NZTA-7) in the Proposed SDP pursuant to Section 181(3) of the Resource Management Act 1991 (RMA).
- An Outline Plan associated with works to construct, operate, and maintain a CVSC within Designation TR1 and Designation TR7 in the Operative Selwyn District plan under Section 176A of the Resource Management Act 1991 (RMA).

2 OTHER ACTIVITIES PERMITTED OR REQUIRING CONSENT OR REGULATION

2.1 Overview

The following RMA planning provisions have been considered in determining if additional resource consents are required:

- Resource Management (National Environmental Standard for Assessing and Managing Contaminants in Soil to Protect Human Health) Regulations 2011 (NESCS)
- Canterbury Land and Water Regional Plan (Plan Change 7 Inclusive)
- The Operative Selwyn District Plan

2.2 NESCS (2011)

The National Environmental Standard for Assessing and Managing Contaminants in Soil to Protect Human Health (NESCS) 2011 is a national consistent set of planning controls and soil contaminant values. It ensures that land affected by contaminants in soil is appropriately identified and assessed before it is developed – and if necessary, the land is remediated, or the contaminants contained to make the land safe for human use. Territorial authorities are responsible for implementing the NESCS. It only applies if there is a risk to human health and does not require consideration of effects on the environment. The NESCS applies only to a ‘piece of land’ on which an activity that is listed on the Minister for the Environment’s (MfE) Hazardous Activities and Industries List (HAIL) is occurring currently or has been carried out historically.

The land contained within designation TR7 in the Operative SDP and within designation NZTA-7 in the Proposed SDP is not identified on Canterbury Regional Council’s Listed Land Use Register (LLUR) as being a HAIL site. Given the long-term use of the designation as a roading corridor and primary production farmland, as shown on historic aerial imagery on Canterbury Maps, it is unlikely that any HAIL activity has occurred onsite. Therefore, the NESCS does not apply.

2.3 Canterbury Land and Water Regional Plan

Waka Kotahi obtained three resource consents from Canterbury Regional Council in 2020 for the project. This related to the discharge of stormwater, discharge of grey water and wastewater, and earthworks over an aquifer. These consents were obtained specifically for this project and additional detail is provided below:

- CRC202420 – Discharge Stormwater to Land
- CRC202421 – Discharge Greywater and Wastewater to Land
- CRC202422 – Earthworks over an Aquifer

Following the safety audit as discussed in Section 1.3 of this report, Waka Kotahi are now proposing to reduce the size and scale of this CVSC. As a result, a Section 127 (Change of Conditions) application will be lodged with Canterbury Regional Council.

The Section 127 application will be a joint application for both CRC202420 and CRC202421 to change the general accordance conditions. This Section 127 application seeks to alter the conditions on the consent allowing stormwater to originate from site different than that referenced within the conditions of

consent, and greywater and stormwater to originate from a site different than that reference within the conditions of consent.

The Section 127 application will be lodged separate and concurrently with this NOR and Outline Plan application.

2.4 Operative Selwyn District Plan

Waka Kotahi have obtained several outline plans, outline plan waivers, and resource consents under the Operative SDP for the project prior to the safety audit being undertaken. Details of these approvals is provided below:

- RC D19005 – Notice of Requirement to Designate the site at the junction of State Highway 1 and North Rakaia Road, and Outline Plan for the construction and operation of a CVSC
- RC195640 – Outline Plan Waiver to undertake minor works within the State Highway 1 Designation
- RC195641 – Construct and Operate a VMS outside of the State Highway 1 Designation
- RC205208 – Outline Plan for the installation of infrastructure associated with a CVSC

Following the safety audit, Waka Kotahi are now proposing to reduce the size and scale of the CVSC, and this project will provide a southbound CSCV facility. As a result, a VMS sign will be located outside of the State Highway 1 designation (Designation TR1) which does not comply with the standards of the Operative Selwyn District Plan. A separate resource consent application seeks to permit the construction and operation of the VMS.

In addition to the above resource consent application for a VMS outside of the State Highway 1 designation, this application is a joint NOR seeking to remove Condition 1 of Designation TR7 within the Operative SDP and Condition 1 of Designation NZTA-7 within the Proposed SDP, and an Outline Plan to allow the construction of a CVSC and associated operational features within Designation TR1 and TR7.

3 DESCRIPTION OF THE SITE AND SURROUNDING AREA

3.1 Site Location

Designations TR1 and TR7 and Designation NZTA-7 are located at the junction of State Highway 1 and North Rakaia Road, Bankside. The location of these designations are shown in Figure 1 and Figure 2 below.

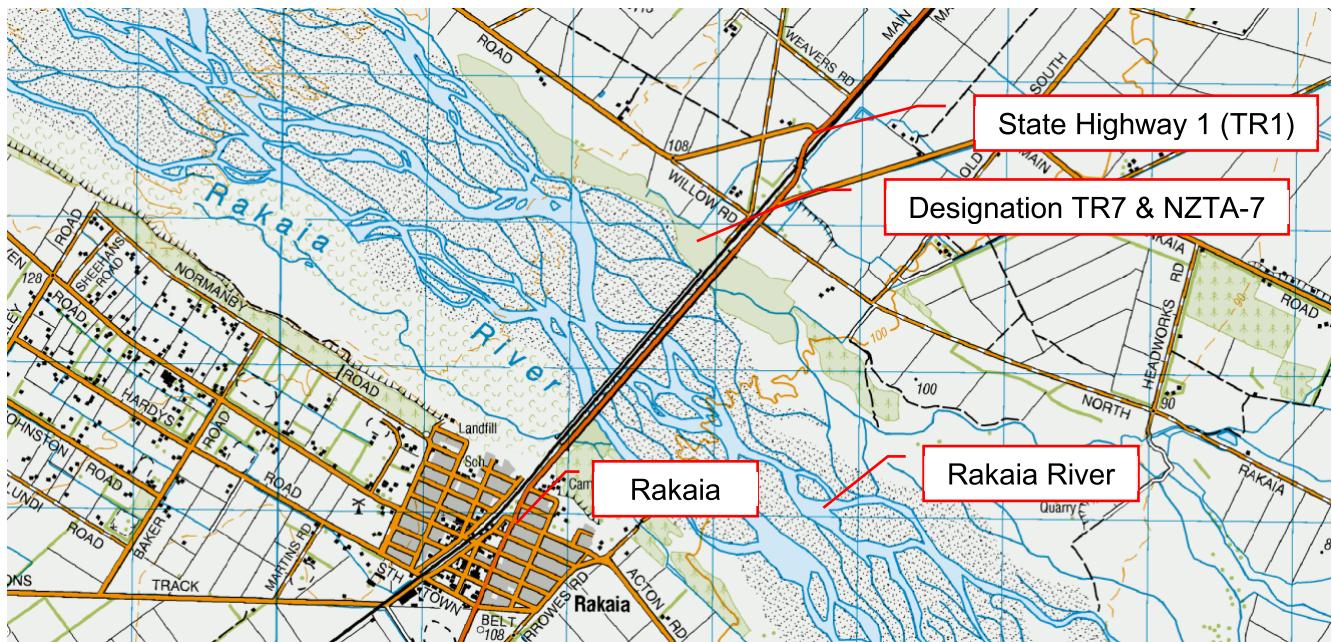


Figure 1: Location of Designation TR7 and Designation NZTA-7. (Source: NZ TopoMap)

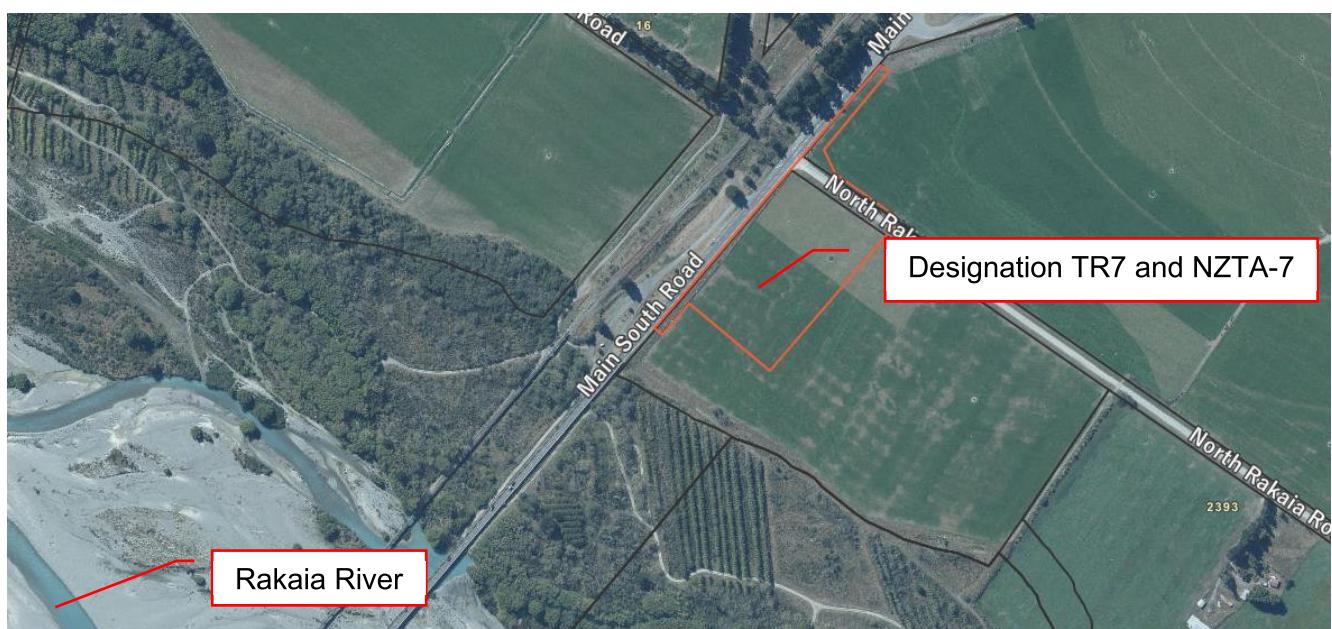


Figure 2: Aerial photo of Designation TR7 and Designation NZTA-7. (Source: Canterbury Maps)

3.2 Surrounding Environment

The surrounding environment is characterised by high intensity primary production farming to the north, east, and west. The Rakaia Township is located approximately 2.5km south of the site and is connected via bridge over the Rakaia River.

The topography of the site is flat and there are no surface water bodies in proximity to the site apart from the Rakaia River (0.4km approx.). No reticulated water, sewage, or stormwater services are provided onsite. State Highway 1 is adjacent to the site and is designated (TR1) within the Operative Selwyn District Plan.

3.3 Selwyn District Plan Zoning and Overlays

Operative Selwyn District Plan

Designation TR7 is located on the corner of Main South Road and North Rakaia Road. The underlying zoning to the designation is the Outer Plains Zone. The designated site is also within the '*Lower Plains Flood Area*'. No other planning overlays are present on or near the Designation TR7. Designation TR7 in the Operative SDP is shown in Figure 3 below.

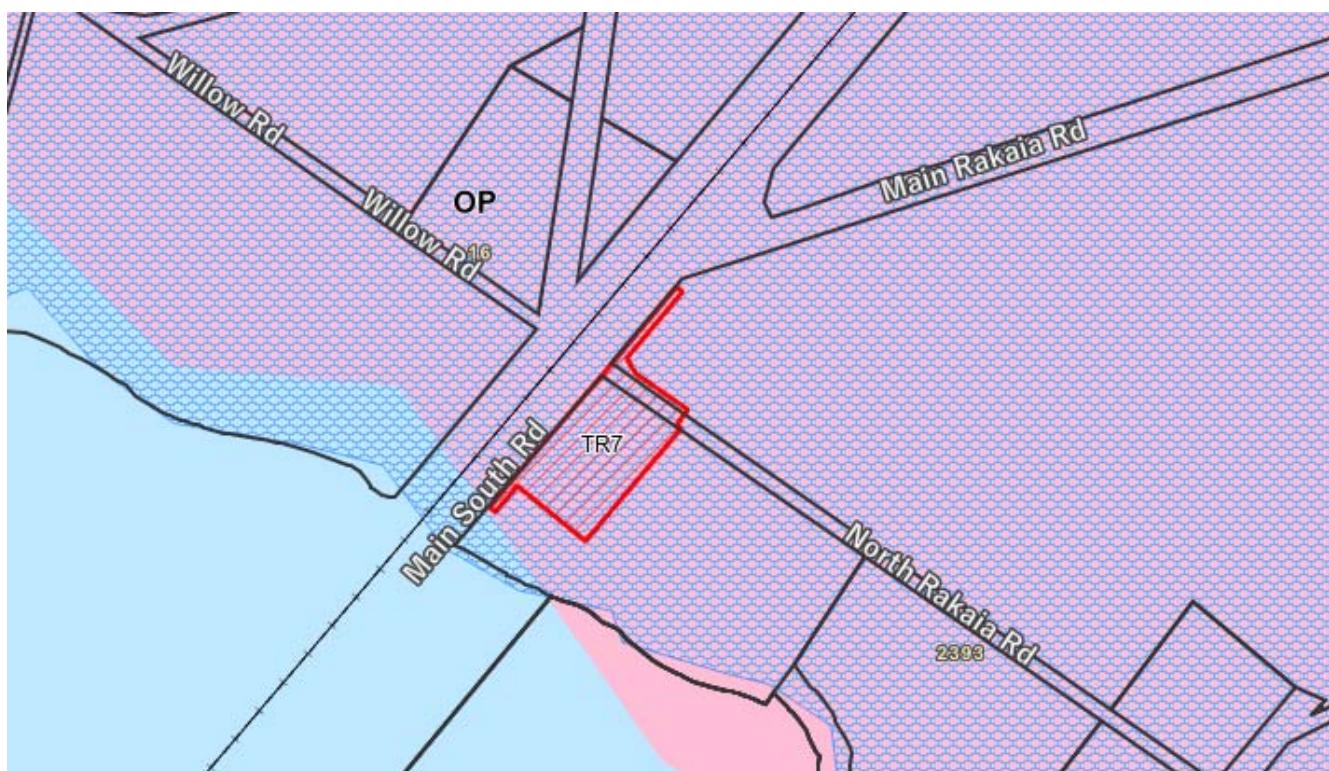


Figure 3: Designation TR7 as shown in the Operative SDP. (Source: Canterbury Maps).

Designation TR7 contains several conditions. These are outlined below:

'Conditions including (but not limited to) the following:

- General Accordance with details provided in the NOR and plans attached in D190066 Appendix C updated 17/02/2020; the Addendum to the NOR 17/02/2020; and the response to the request for further information 27/03/2020;

- 10yr Lapse;
- Prior to construction works being undertaken, engineering plans and specifications relating to the upgrade of the local road to be reviewed and approved by Council's Asset Manager, Transportation;
- Prior to commencement of operations, the operational management plan shall be provided to Council's Asset Manager, Transportation'.

Proposed Selwyn District Plan

The Proposed SDP was publicly notified on 5 October 2020. SDC have been holding hearings on the Proposed SDP since August 2021 and the hearing regarding Designations were held in May 2022.

Designation NZTA-7 is located within the planning maps as shown in Figure 4 below. The underlying zoning is the General Rural Zone, and the site is also located within the Plains Flood Management Overlay. No other planning overlays are present within the boundary of Designation NZTA-7.



Figure 4: Designation NZTA-7 as shown in the Proposed SDP. (Source: SDC).

Designation NZTA-7 contains several conditions, and these are outlined below:

Conditions:

'General Accordance'

1. *The designation shall be implanted in general accordance with the details provided within the Notice of Requirement:*
 - The Plans attached in Appendix C to the Notice of Requirement updated 17/02/2020;*
 - The Addendum to the Notice of Requirement dated 17/02/2020;*
 - The response to the request for further information dated 27/03/2020; and*
 - The response to the request for further information dated 17/04/2020.*

Outline Plan

-
-
- 2. Works undertaken in accordance with the NOR will not require an Outline Plan.

Lapse Date

- 3. The designation shall lapse on the expiry of 10 years from the date on which it is included in the District Plan if it has not been given effect to before the end of that period.

Advice Note:

For the avoidance of doubt, none of these conditions prevent or apply to works required for the ongoing operation or maintenance of the Project following construction, such as routine maintenance or changes to signage over time. Depending upon the nature of such works, Outline Plans or Outline Plan waivers may be required for any such works'.

4 PROPOSED ALTERATION TO DESIGNATION

4.1 Designation Condition Removal

Waka Kotahi seeks to remove the first general condition of Designation TR7 within the Operative SDP. The condition states:

"General Accordance with details provided in the NOR and plans attached in D190066 Appendix C updated 17/02/2020; the Addendum to the NOR 17/02/2020; and the response to the request for further information 27/03/2020".

This Notice of Requirement seeks to remove this condition in its entirety.

Waka Kotahi seeks to remove Condition 1 of Designation NZTA-7 within the Proposed SDP. Condition 1 states:

"General Accordance

- 1. The designation shall be implemented in general accordance with the details provided with the Notice of Requirement:

- a. The Plans attached in Appendix C of the Notice of Requirement dated 17/02/2020;
- b. The Addendum to the Notice of Requirement dated 17/02/2020;
- c. The response to the request to the further information dated 27/03/2020; and
- d. The response to the request for further information dated 17/04/2020."

4.2 Need for Designation Condition Removal

Waka Kotahi seek to remove the general condition of Designation TR7 to enable the construction, operation, and maintenance of a CVSC which is not in general accordance with the plans referenced above. As outlined in Section 1.3, the safety audit required the project to be altered from the approved plans. The project will now provide a southbound CVSC, which differs from the previously approved plans which provided a combined northbound and southbound CVSC. A combined northbound and southbound CVSC facility was not considered to be feasible. Hence, the requirement to remove the condition limiting the development to be in accordance with previously approved plans. This condition lacks flexibility and is impractical when changes to the approved plans need to be undertaken.

In conjunction with the removal of the general condition of Designation TR7 in the Operative SDP, the removal of Condition 1 of Designation NZTA-7 in the Proposed SDP is also proposed. This will enable onsite development on Designation NZTA-7 once the Proposed SDP becomes operative.

4.3 Designation Purpose

The purpose of Designation TR7 is to '*undertake maintenance, operation, use, and improvement to the state highway network*'. No change to the purpose of the designation is proposed. The existing designation purpose supports the development of a CVSC as discussed further within this report.

The removal of the first general condition of Designation TR7, will enable the construction, operation, and maintenance of a CVSC which is not in general accordance with the referenced plans to remain consistent with the purpose of the designation.

Likewise, the purpose of Designation NZTA-7 in the Proposed SDP is '*to undertake construction, maintenance, operation, use and improvement of the state highway network and associated infrastructure*'. As outlined above, the proposal is consistent with the purpose of the Designation NZTA-7.

5 CONSIDERATION OF ALTERNATIVES

Section 171(1)(b) of the RMA requires that a consideration of alternative sites, routes, or methods of undertaking the work is relevant in certain specific respects, including whether adequate consideration has been given to the alternative sites, routes or methods of undertaking the work (where a Requiring Authority does not have an interest in the land sufficient for undertaking the work, or it is likely that the work will have a significant adverse effect on the environment).

It is not considered that the proposal will result in significant environmental effects. Furthermore, it is considered that the requiring authority has sufficient interest in the land to undertake the works. As such, a consideration of alternative sites and/or methods is not considered to be required.

6 ASSESSMENT OF EFFECTS ON THE ENVIRONMENT

To satisfy Section 181(3)(a)(i) of the RMA, it is necessary to demonstrate that the:

"alteration involves no more than a minor change to the effects on the environment associated with the use of proposed use of the land or any water concerned"

The assessment of actual and potential effects on the environment from the proposed designation alteration is outlined below and summarised in the categories below:

- Positive Effects
- Effects on Amenity and Character
- Cultural and Archaeological Effects

6.1 Positive Effects

The construction, operation, and maintenance of the CVSC will contribute to the safe and efficient operation of the State Highway network through means of creating a productive land transport system that supports a level playing field in the heavy vehicle industry. In assessing the positive effects of

removing the general condition from Designation TR7 and Condition 1 from NZTA-7, the following are considered relevant.

The removal of the general condition in Designation TR7 and condition 1 of NZTA-7 will allow onsite development to occur which is not in general accordance with plans lodged with a previous NOR and Outline Plan application. The previous plans are no longer practical as a result of a safety audit, and an unacceptable safety risk which would have been created.

The removal of the general condition firstly allows the development to occur, and secondly, contributes to the effective enforcement of overweight and unsafe vehicles, reduced wear and maintenance on the road network, fair market conditions for compliant heavy vehicle operators, and increasing the safety of other road network users.

The removal of the general condition on Designation TR7 and condition 1 on NZTA-7 allows Waka Kotahi to meet their statutory objectives as outlined in the Land Transport Management Act 2003.

6.2 Effects on Amenity and Character

6.2.1 Visual

The removal of the general condition from TR7 and condition 1 from NZTA-7 will enable the development of a CVSC which is smaller in scale and intensity than that permitted by the existing conditions on the designation. A smaller CVSC is expected to have lesser adverse effects on existing amenity values and character of the rural area. On the basis that the proposed site is smaller in scale and intensity, adverse effects on visual amenity will be lesser than those already considered within the previous NOR application, and for the purpose of this application, insignificant.

No sensitive receivers are located within proximity to the proposed CVSC. The nearest residential dwelling is located approximately 280m north-west of the CVSC and is separated by the Main South Line (Railway) and State Highway 1. The next closest residential dwelling is located 650m south-east of the CVSC. Large vegetative planting provides good visual screening.

All sensitive visual receivers have good separation and features which provide visual screening. As above, the removal of the general condition from Designation TR7 and condition 1 from NZTA-7 to allow a site smaller in scale and intensity will create effects no greater than that already considered acceptable within the previous NOR. Therefore, any adverse effects on amenity and character are considered to be less than minor.

6.2.2 Noise

Noise is expected to arise from construction activities and from the ongoing operation of the proposed CVSC. Construction noise is expected to be generated during the construction of buildings, through the operation of machinery such as excavators, compactors, loaders and the likes. Operational noise will result from the movement of commercial vehicles throughout the site when the CVSC becomes operational.

All onsite construction activities associated with the development of the CVSC is expected to occur in accordance with NZS6803:1999 *Acoustics – Construction Noise* to ensure acceptable construction noise effects. This will mean avoiding noisy construction activities at night, limiting construction to between the hours of 7:30am and 6pm during weekdays and Saturdays and no construction activity occurring on Sunday's and public holidays. This will also mean adopting the best practical option to

minimise construction noise where possible. Overall, any noise effects from construction related activities will be less than minor and of a temporary nature.

The CVSC will likely be operational for less than 7 days per month. The operation of the CVSC will result in the movement of heavy commercial vehicles into, around, and off the site. These vehicle movements are expected to result in minimal periodic operational noise. The overall effects of noise as a result of the operation of the CVSC will be lessened due to the absence of sensitive noise receivers in close proximity to the site. The closest dwelling is located approximately 270m north west of the proposed site. Given this large separation distance and the limited duration in which the CVSC will be in operation, any adverse effects noise effects as a result of the operation of the CVSC facility will be less than minor.

In addition to the separation distance provided between the site and the closest dwelling is State Highway 1 and the Main South Line (railway). It is likely that the existing ambient noise generated by the operation of State Highway 1 and Main South Line would likely exceed that of vehicles manoeuvring onsite with the operation of the CVSC. For these reasons, operational noise is not expected to create any adverse effects on the closest residential dwelling beyond that already present.

Overall, any noise effects from the operation of the CVSC will be less than minor.

6.3 Cultural and Archaeological Effects

6.3.1 Cultural Effects

The nearest culturally significant feature is the Rakaia River which is located approximately 300 – 400m south-west of Designation TR7 and NZTA-7. The Rakaia River is a Runanga Sensitive Area and is recognised for mahinga Kai (food gathering) and ara tawhito (tradition travel routes).

No effects above and beyond those already addressed within the previous NOR are anticipated from the removal of the general condition on Designation TR7 and condition 1 from NTZA-7.

6.3.2 Archaeological Effects

There are no archaeologically significant sites in the vicinity of the application site. Additionally, a review of the New Zealand Archaeological Society's ArchSite carried out as part of the previous NOR application did not identify any archaeological sites in the vicinity. Therefore, any adverse effects on archaeological values are negligible.

6.3.3 Summary

In managing risk, Waka Kotahi contractors will follow an Accidental Discovery Protocol. During works if any archaeological sites or remains are discovered, the works at that place of discovery will cease immediately. Heritage New Zealand, Mahaanui Kurataiao on behalf of Te Taumutu Runanga and Te Ngāi Tūāhuriri Rūnanga, and Selwyn District Council shall be contacted, and works shall only recommence in the affected areas when any necessary statutory authorisations or consents are obtained.

Adverse effects arising from the removal of the general condition from Designation TR7 and condition 1 from NZTA-7 are no greater than those already considered in the previous NOR application. Therefore, the effects on cultural values, and archaeological sites are expected to be less than minor.

6.4 Conclusion

No adverse effects above and beyond those already consented and considered acceptable and anticipated to arise from the removal of Condition 1 of Designation TR7 and NZTA-7. The proposed CVSC is smaller in scale and intensity and is therefore indicated to have lesser effects on the receiving environment than the previously approved site.

Adverse effects on the environment from the proposed alteration to a designation(s) is less than minor and satisfies Section 181(3)(a)(i) of the RMA.

7 CONSULTATION

7.1 Iwi

Waka Kotahi is currently undertaking consultation with Te Taumutu Rūnanga and Te Ngāi Tūāhuriri Rūnanga. Waka Kotahi will undertake this consultation at a hui scheduled for early June 2022.

Further details on the outcome of this consultation can be provided in June 2022 following the conclusion of the hui.

7.2 Selwyn District Council

In accordance with an existing condition of the designation (TR7 and NZTA7) and listed below, Waka Kotahi are required to obtain approval from Selwyn District Council's Asset Manager – Transportation, for the upgrade works to North Rakaia Road.

8. *'That prior to the undertaking of construction works, the engineering plans and specifications relating to the upgrades to the local road to be reviewed and approved by Council's Asset Manager, Transportation'.*

Waka Kotahi are in the process of obtaining engineering approval from Selwyn District Council for the upgrade works to North Rakaia Road. This approval is required as Selwyn District Council are the landowner of North Rakaia Road.

In addition to the above-mentioned approval, Waka Kotahi are required to provide Council's Asset Manager – Transportation with an operational management plan. This condition of the designation is shown below:

9. *'That prior to the commencement of operations, the operational management plan shall be provided to Council's Asset Manager, Transportation'.*

Note: A recommendation on this application for a Notice of Requirement and Outline Plan can be provided without engineering approval from Council's Asset Manager – Transportation. Engineering approval from Council's Asset Manager – Transportation is only required prior to the construction works being undertaken for the upgrade of North Rakaia Road to fulfil condition 8 of the designation.

7.3 Summary

Waka Kotahi are currently consulting with Iwi and Selwyn District Council's Asset Management – Transportation. The outcome of this can be provided, following the completion of the consultation.

No other parties are considered to be directly affected by the proposed alteration to designation.

8 STATUTORY ASSESSMENT

8.1 The Resource Management Act 1991

The RMA governs the use and development of New Zealand's natural and physical resources through:

- Part 2 (Purposes and Principles) which establishes the purposes and principles applying to resource management
- Section 171, which prescribes matters to be taken into account in confirming designations.

The following sections of the RMA are considered the most relevant to the project.

8.2 Section 5: Purpose of the RMA

The overriding purpose of the RMA is “to promote the sustainable management of natural and physical resources” (Section 5). The broader principles (Sections 6 to 8) are to inform the achieving of that purpose.

When considering an application, the consent authority, must subject to Part 2, have regard to those matters listed under Section 104 of the RMA.

With regards to the application of the subject to Part 2' under Section 104, case law findings have directed that decision makers / Commissioners may now only have recourse to Part 2 of the RMA if it is determined that one of three exceptions apply:

- If any part or the whole of the relevant plan(s) are invalid.
- If the relevant plan(s) did not provide complete coverage of the Part 2 matters.
- If there is uncertainty of the meaning of provisions as they affect Part 2.

In essence what this means is that decisions makers only need to ‘go back to’ Part 2 of the Act if the relevant planning documents have not fully addressed the Part 2 matters. If a Regional or District Plan has not fully addressed the Part 2 matters, then decision makers can ‘go up the tree’ to the RPS and then any relevant NPS in relation to any Part 2 matters.

Plans, which have to “give effect” to the higher order statutory planning documents (RPS and NPSs), should have appropriately addressed Part 2 of the RMA.

It is considered that none of the three exceptions listed above apply and that the Part 2 matters have adequately been addressed through the SDP. Based on the assessment of the proposal being consistent with the SDP as per below, the proposal is considered to be consistent with Part 2 of the RMA.

8.3 RMA Part 8: Alteration to Designation

Waka Kotahi is a Requiring Authority under section 166 of the RMA. Section 181(1) of the RMA provides that a Requiring Authority may give notice at any time to a territorial authority of its requirement to alter a designation or a designation requirement.

Under section 181(3), a territorial authority may at any time alter a designation in a district plan or a requirement for a designation in a proposed district plan, if:

- (a) *The alteration-*
 - (i) *involves no more than a minor change to the effects on the environment associated with the use or proposed use of land or any water concerned; or*
 - (ii) *involves only minor changes or adjustments to the boundaries of the designation or requirement; and*
- (b) *written notice of the proposed alteration has been given to every owner or occupier of the land directly affects and those owners or occupiers agree with the alteration; and*
- (c) *both the territorial authority and the requiring authority agree with the alteration-and sections 168 to 179 and 198AA to 198AD shall not apply to any such alteration.*

If these criteria are satisfied, the alteration to designation may occur without further formality (ie on a non-notified basis).

The “effects” criteria provided for under s181(3)(a)(i) is one of two options available to the Requiring Authority. The other relates to a determination of the extent of change or adjustment to the “boundaries” of the designation under s181(3)(a)(ii). It is important to note it is not necessary to satisfy both the “effects” and the “boundaries” tests.

An assessment of the criteria under s181(3) is outlined below:

8.3.1 Minor Change to Effects (s181(3)(a)(i))

In order to satisfy s.181(3)(a)(i), it is necessary to demonstrate the proposal will involve a no more than minor change to the effects on the environment associated with the use of the land.

Section 6 of this report outlines that any effects of the proposed alteration to designation with the removal of conditions will be less than minor. There will be no change in the level of effects currently associated with the existing designations.

It is considered the proposal meets the ‘change in effects’ test of s.181(3)(a)(i).

8.3.2 Minor Change to Boundaries (s181(3)(a)(ii))

In order to satisfy s.181(3)(a)(ii), it is necessary to demonstrate the proposal involves no more than a minor change or adjustment to the boundaries of the designation or requirement. No changes are proposed to be undertaken to the boundaries of the existing designations TR7 in the Operative SDP and NZTA-7 in the Proposed District Plan.

8.3.3 Notice of Proposed Alteration to Owners and Occupiers (s181(3)(b))

Waka Kotahi own and occupy all the land for the proposed development. Therefore, there are no directly affected owners or occupiers affected by the proposed alteration to designation.

8.3.4 Territorial Authority and Requiring Authority to Agree (s181(3)(c))

As the Requiring Authority, Waka Kotahi agrees to this alteration, thereby partially satisfying s.181(3)(c) of the RMA. Selwyn District Council has discretion on this matter.

It is considered the alteration to designation satisfies the criteria set out in Section 181(3) of the RMA and can proceed on the basis as a minor alteration to designation and be processed non-notified.

Waka Kotahi therefore seeks that SDC agrees with the alteration to Designation TR7 in the Operative SDP and Designation NZTA-7 in the Proposed SDP through the s.181 notice process.

8.4 Canterbury Regional Policy Statement

The Canterbury Regional Policy Statement 2013 (RPS) (revised February 2017) provides an overview of the resource management issues of the region. It sets out how natural and physical resources are to be managed in an integrated way to promote sustainable management.

The provisions contained in Sections 5 - 8 of the RMA provide the framework for the objectives and policies of the RPS. The RPS in turn provides the framework for the issues, objectives, policies and methods of the underlying Regional Plans. The Regional Plans have to be consistent with the RPS.

The following objectives and policies contained within Chapter 5 of the Canterbury Regional Policy Statement are considered relevant to the proposal and have been assessed below.

- Objective 5.2.3: Transport Network (Wider Region)
- Policy 5.3.1: Regional Growth (Wider Region)
- Policy 5.3.2: Development Conditions (Wider Region)
- Policy 5.3.3: Management of Development (Wider Region)
- Policy 5.3.7: Strategic Land Transport Network and Arterial Roads (Entire Region)
- Policy 5.3.8: Land Use and Transport Integration (Wider Region)

The proposal is consistent and not contrary to the above objectives and policies contained within the Canterbury Regional Policy Statement. The proposal is specifically consistent with Objective 5.2.3 and Policies 5.3.7 and 5.3.8 as they relate to transportation networks and transportation land uses.

In addition to Chapter 5, Chapter 11 is considered relevant to the proposal. Chapter 11 relates to natural hazards, with the relevant objectives being assessed below.

- Objective 11.2.2: Adverse Effects from Hazard Mitigation are avoided or mitigated
- Objective 11.2.3: Climate Change and Natural Hazards
- Policy 11.3.7: Physical Mitigation Works
- Policy 11.3.8: Climate Change

The proposal has taken into account the flood hazard at the site which has potential to cause adverse effects on built structures at the CVSC. The Tier 1.5 Compliance Building has been raised in accordance with a flood hazard report provided by Canterbury Regional Council. This report is attached as Appendix F of this application. The application is therefore considered consistent with the objectives and policies as they relate to natural hazards.

In addition, the proposal has considered the actual and potential adverse effects of climate change. The stormwater design onsite allows for increases in rainfall as a result of climate change.

Overall, the proposal is consistent with the objectives and policies of the Canterbury Regional Policy Statement.

8.5 Selwyn District Plan

The Operative and Proposed Selwyn District Plans contain objectives and policies which relate to the proposed activity. The following objectives and policies have been recognised as relevant to the proposal.

Operative Selwyn District Plan

Objective B2.1.2: An integrated approach to land use and transport planning to manage and minimise adverse effects of transport networks on adjoining land uses, and to avoid “reverse sensitivity” effects on the operation of transport networks.

Policy B2.1.3: Recognise and protect the primary function of roads classified as State Highways or Arterial Roads in Appendix 9, to ensure the safe and efficient flow of through traffic en route to its destination.

Objective B3.1.2: Measures to mitigate natural hazards do not cause or exacerbate adverse effects on the environment.

Policy B3.1.3: Ensure dwellings or other principal buildings located in the flood area shown on the Planning Maps have minimum floor heights 300mm (freeboard) above the projected flood level for a 2% AEP (Annual Exceedance Probability) flood event so as to minimise the risk of inundation.

The proposal provides appropriate methods of mitigating natural hazard risk and adverse effects on the environment. Additionally, the CVSC contributes to the safe operation of the roading network. The proposal is consistent with the relevant objectives and policies of the Operative Selwyn District Plan.

Proposed Selwyn District Plan

TRAN-01: People and places are connected through safe, efficient, and convenient land transport corridors and land transport infrastructure which is well integrated with land use activities and subdivision development.

TRAN-03: Land transport corridors and land transport infrastructure support the needs of people and freight, while ensuring adverse effects on the surrounding environment from their establishment and operation are managed.

TRAN-P1: The safety and efficiency of the district's land transport network and systems are enabled through integrated land use and subdivision development [...]

TRAN-P7: Recognise and protect the function of the district's land transport network and systems by managing land use activities and subdivision development to ensure the safe and efficient movement of people and goods [...]

NH-O1: New subdivision, use, and development, other than new important infrastructure and land transport infrastructure [...]

NH-O2: Important infrastructure and land transport infrastructure is only located within areas of significant natural hazard risk where there is no reasonable alternative and the important infrastructure or land transport infrastructure is designed so as not to exacerbate natural hazard risk to people and property.

NH-O3: Methods to mitigate natural hazards do not create or exacerbate adverse effects on other people, property, infrastructure, or the environment.

NH-P2: Avoid the development or use of land, buildings or structures in high hazard areas for any important infrastructure or land transport infrastructure, unless the activity [...]

NH-P10: In areas within the Plains Flood Management Overlay that are not a high hazard area, provide for any new subdivision, use, and development (other than important infrastructure and land transport infrastructure) only where every new residential unit or principal building has an appropriate floor level above the 200-year Average Return Interval (ARI) design flood level.

The proposal is consistent with the above objectives and policies of the Proposed Selwyn District Plan. The proposal contributes to the safe and efficient movement of people and freight within the district while ensuring that adverse effects are appropriately managed. The proposal also has appropriate measures of mitigating the actual and potential effects of flood hazard.

Overall, the proposal is consistent and not contrary to the objectives and policies of the Proposed Selwyn District Plan.

9 PROPOSAL DESCRIPTION FOR OUTLINE PLAN

9.1 Overview

Waka Kotahi seek to construct, operate, and maintain a CVSC on Designation TR7 which has a reduced size and scale to that previously approved. Further details on the CVSC are provided below.

9.2 Commercial Vehicle Safety Centre

Works within Designation TR1 and TR7 for the construction and operation of a commercial vehicle safety centre (CVSC) are proposed as part of the Waka Kotahi national Weigh Right Programme. Appendix A contains plans which provide a general overview of the entire Rakaia CVSC.

The proposed CVSC north of the Rakaia River within the Selwyn District will capture a significant portion of heavy vehicles travelling south out of Christchurch along State Highway 1. The CVSC will contribute to the operation of an effective, efficient, and safe land transport system.

9.3 Site of Works

The works are proposed to occur within the boundaries of Designation TR1 and TR7 as listed within the Operative Selwyn District Plan. Different aspects of the proposal are scattered over a 1.5km length of State Highway 1 (TR1), with the CVSC concentrated in the North Rakaia Road site (TR7). A separate resource consent application for a variable message sign (VMS) located outside of Designation TR1 will be lodged with Council concurrent to this application. The general location of each aspect of the proposal are shown in Figure 5 below.

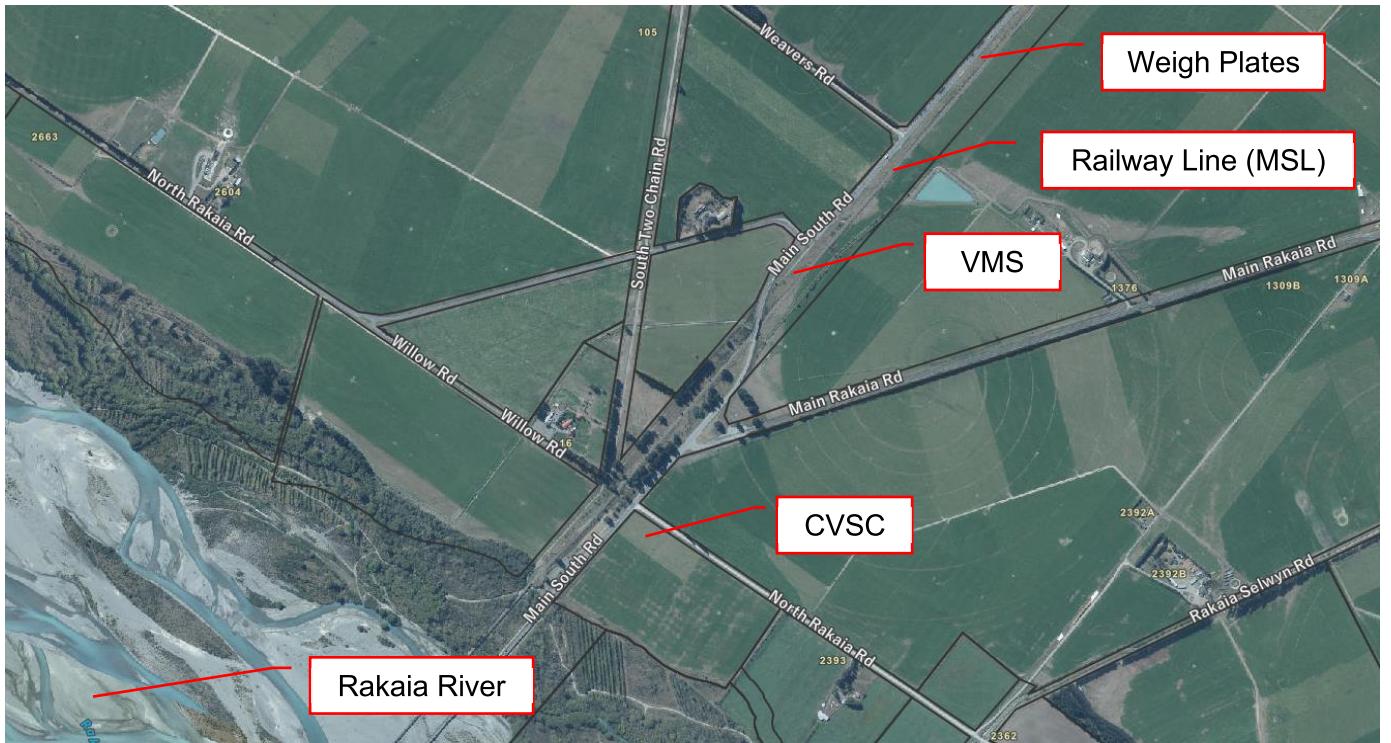


Figure 5: Location of works. (Source: Canterbury Maps)

9.4 Operative Selwyn District Plan

Works will be carried out in Designation TR1 and TR7. Both designations are listed within the Operative Selwyn District Plan and discussed further below.

9.4.1.1 Designation TR1

Designation TR1 as listed in the Operative Selwyn District Plan is shown in Figure 6 below.

| Des No. | Map Ref | Site Name | Designation Purpose | Location | Zone | Legal Description and Gazette (where known) | Comments/ Conditions |
|---------|---------|---------------------------------|---------------------|---|---------|---|----------------------|
| TR1 | Various | State Highways 1, 73, 75 and 77 | State Highway | <p>SH1: From the intersection of SH1 with the centerline of the Rakaia River. Note: there is a short section of SH1 south of Marshs Road that is within Christchurch City.</p> <p><i>Note: For that part of TR1 affected by the CSM2 and MSRFL proposal, separate conditions apply. The areas where these apply have been noted in the District Plan as either TR5 or TR6 (see below).</i></p> <p>SH73: From the Dawsons Road / SH 73 intersection to the summit of Arthurs Pass.</p> | Various | Various | Various |

Figure 6: Designation TR1 as shown in the Operative Selwyn District Plan. (Source: Selwyn District Plan)

As shown in Figure 6 above, TR1 is designated for State Highway purposes. The designation has full effect and overrides any rules in the Selwyn District Plan. There are no conditions on the designation that apply to this section of State Highway 1 (TR1).

Designation TR1 covers a significant portion of State Highway 1 within the Selwyn District. For the purpose of this application, the applicable section of Designation TR1 is shown in Figure 7 below.

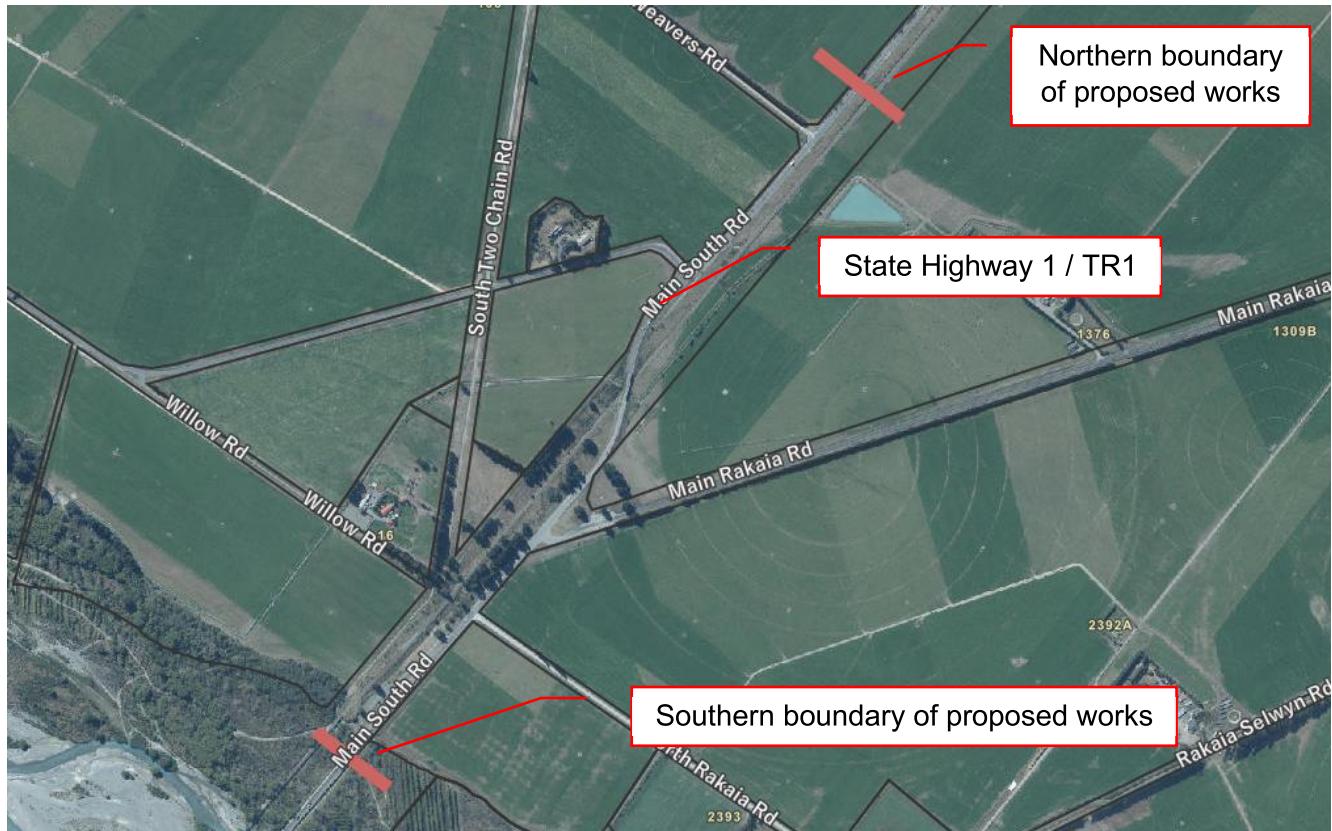


Figure 7: Applicable section of Designation TR1 which applies to this application. (Source: Canterbury Maps).

The purpose of the designation is for ‘State Highway’ and the proposal to construct and operate a CVSC is therefore in accordance with the designated State Highway purpose of the site.

9.4.1.2 Designation TR7

Designation TR7 is listed within the Operative Selwyn District Plan and is shown in Figure 8 below.

| | | | | | | | |
|-----|---------|-------------------|---|-------------------|--------------|---|--|
| TR7 | Various | North Rakaia Road | Undertake maintenance, operation, use, and improvement to the state highway network | North Rakaia Road | Outer Plains | Rural Section 33582 (23,000m ²); Rural Section 33583 (1660m ²); Rural Section 34454 (240m ²); Parcel ID 3576329 | Conditions including (but not limited to) the following: General Accordance with details provided in the NOR and plans attached in D190066 Appendix C updated 17/02/2020; the Addendum to the NOR 17/02/2020; and the response to the request for further information 27/03/2020; 10yr Lapse; Prior to construction works being undertaken, engineering plans and specifications relating to the upgrade of the local road to be reviewed and approved by Council’s Asset Manager, Transportation; Prior to commencement of operations, the operational management plan shall be provided to Council’s Asset Manager, Transportation. |
|-----|---------|-------------------|---|-------------------|--------------|---|--|

Figure 8: Designation TR7 as shown in the Operative Selwyn District Plan. (Source: Selwyn District Plan)

As shown above, the site is designated for the purpose of ‘*undertaking maintenance, operation, use and improvement to the State Highway network*’.

The site where the CVSC is to be located is at the junction of State Highway 1 and North Rakaia Road. The site is legally described as RS 33582 contained within Record of Title CB20B/482. This land parcel has an area of 11.15 hectares. The site is currently vacant and used for primary production purposes by Rakaia Dairy Limited and has recently been purchased by Waka Kotahi. A copy of the purchase agreement has been included as Appendix H.

As shown in Section 3.3 of this application, Designation TR7 is located within the Outer Plains Zone and is subject to the Lower Plains Flood Area overlay. No other overlays or management zones apply to the site as shown in the Selwyn District Council Planning Maps.

10 OUTLINE PLAN S176A ASSESSMENT

Section 176A of the Resource Management Act 1991 (RMA) requires an Outline Plan of works to be constructed on designated land to be submitted to a territorial authority. This provides opportunity for the territorial authority to request changes before construction commences.

Section 176A(3) of the RMA states:

“*An outline plan must show –*

- (a) *The height, shape, and bulk of the public works, project, or work; and*
- (b) *The location on the site of the public works, project, or work; and*
- (c) *The likely finished contour of the site; and*
- (d) *The vehicular access, circulation, and the provision for parking; and*
- (e) *The landscaping proposed; and*
- (f) *Any other matters to avoid, remedy, or mitigate any adverse effects on the environment.”*

A territorial authority does not have the discretion to approve or decline a development under an Outline Plan. Under Section 176A(4) of the RMA, the sole discretion of a territorial authority is to request changes to an Outline Plan within 20 working days of its receipt.

Assessment under Section 176A(3) of the RMA is discussed under the relevant headings below.

10.1 Height, Shape, and Bulk of Work

10.1.1 Designation TR1 – State Highway 1

Works within designation TR1 are shown on Plans attached as Appendix A. Works include the following:

- Automatic Number Plate Reading (ANPR) Camera
- Weigh-In-Motion (WIN) Plates
- ITS Cabinets
- Metal Side Guard
- Road Resurfacing

Plan showing the location and scale of the above listed features are contained within Appendix A.

10.1.2 Designation TR7 – North Rakaia Road

The general layout of the proposed CVSC to be located within Designation TR7 is shown in Figure 9 below and attached within Appendix A of this application.

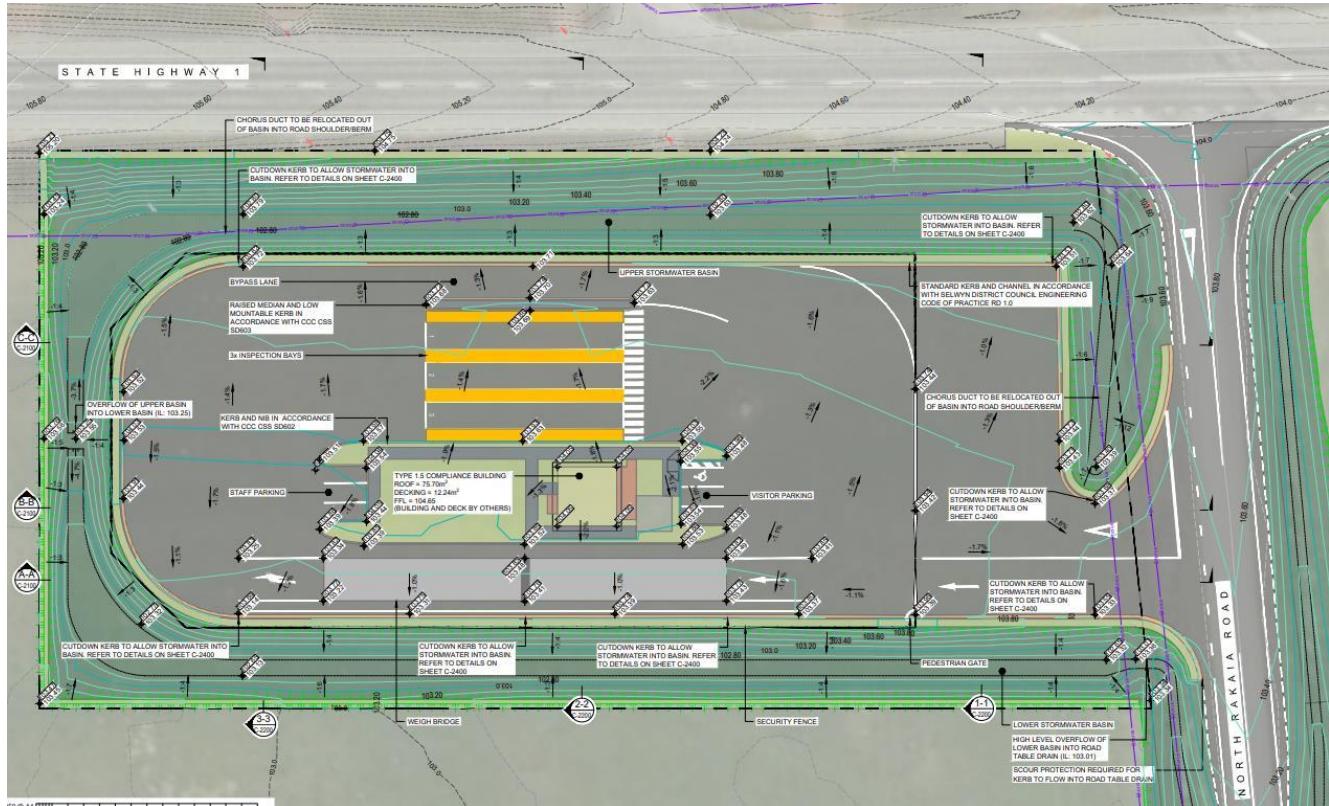


Figure 9: Proposed general layout of the CVSC to be located in Designation TR7. (Source: WSP)

The proposed CVSC when complete will comprise of:

- A weigh bridge
- Tier 1.5 compliance building
- Bypass lane
- Inspection bays
- Staff and visitor parking
- Lighting
- Onsite greywater and wastewater disposal
- Onsite stormwater disposal
- Site fencing

10.1.2.1 Weigh Bridge

The onsite weigh bridge comprises of two 5m wide by 25m long weigh plates. These plates are located on the east of the CVSC site and will require all heavy vehicles entering the site to pass over the plates. The weigh bridge will be integrated into the site at ground level.

10.1.2.2 Tier 1.5 Compliance Building

The tier 1.5 compliance building is a 7.5m wide by 7.5m long (75m^2 in area) building located adjacent to the weigh bridge on the CVSC site. The building will be situated on wooden piles 600mm above ground level, giving the building a total approximate height of 4.5m.

The building contains an observation area, two information and communication technology (ICT) rooms, interview room, kitchenette, and toilet facilities. The internal layout of the building is shown in Figure 10 below.

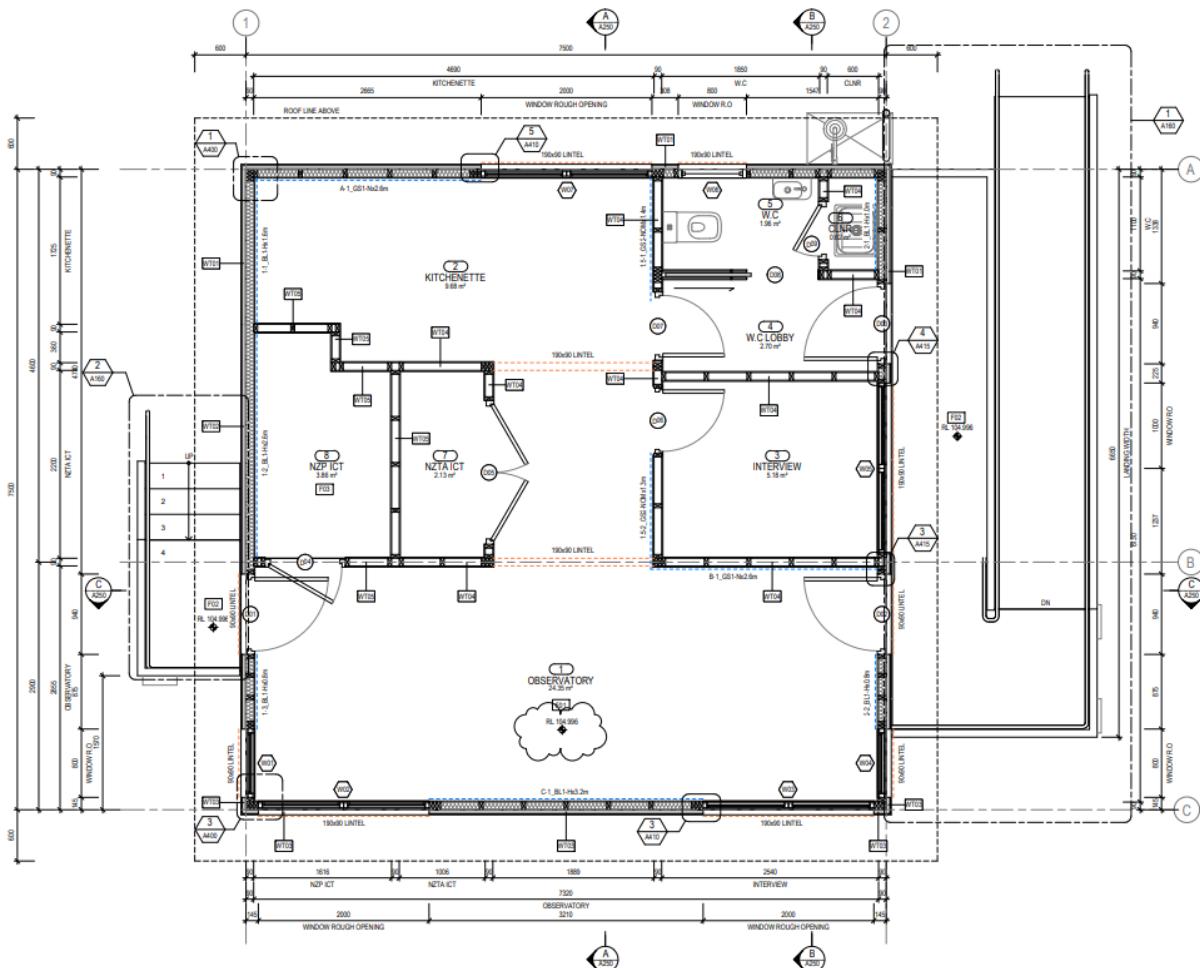


Figure 10: Internal layout of Tier 1.5 Compliance Building. (Source: GHD Woodhead)

Access to the building is obtained either by a wooden ramp on the buildings north-east elevation, or wooden steps on the south-west elevation. The exterior of the building is characterised by dark weatherboard. A complete set of building plans for the Tier 1.5 Compliance Building have been attached as Appendix B of this application.

10.1.2.3 Bypass Lane

A bypass lane is provided for heavy vehicles which are either weight compliant or do not require inspection. This bypass lane is located on the north-west portion of the site and runs adjacent to State Highway 1. The bypass lane is approximately 4m in width and is separated from the inspection bays by a raised median and low mountable kerb.

10.1.2.4 Inspection Bays

Three inspection bays will be provided on the CVSC site. Heavy vehicles will be directed to these if they are either overweight or require further inspection. Each bay is approximately 3m in width and 25m in length. The inspection bays are adjacent to the bypass lane and are separated by a raised median and low mountable kerb.

10.1.2.5 Staff and Visitor Parking

Six car parks will be provided onsite. These are located at the front and rear of the Tier 1.5 Compliance Building.

10.1.2.6 Lighting

Onsite lighting has been designed to facilitate the safe and efficient movement of vehicles entering, exiting, and manoeuvring on the CVSC. Onsite lighting will be mounted on poles and will be pointed towards the ground (0-degree angle). Lighting which is angled directly at the ground will ensure that light spill onto surrounding properties and the state highway network is minimised. A lighting plan is attached to this application as Appendix G.

10.1.2.7 Onsite Services

No reticulated water or wastewater services are available onsite.

In lieu of this, the Tier 1.5 Compliance Building will obtain drinking water from a roof water collection tank located on a concrete pad to the north-east.

Wastewater generated from the Tier 1.5 Compliance Building will be disposed of onsite via a secondary aerated treatment system discharge to a sand trench land application system.

Stormwater generated onsite will be disposed of into onsite stormwater basins. These stormwater basins form the perimeter of the CVSC and are shown on Plan C-2010 within Appendix C of this application.

The discharge of wastewater to land, and discharge of stormwater to land are permitted under previously obtained resource consent from Canterbury Regional Council.

10.1.2.8 Site Fencing

Security fencing will be installed around the perimeter of the CVSC site. This will be located between the edge of the hardstand area and stormwater basins. An electric gate will close the site off from North Rakaia Road when the CVSC is not operating.

10.2 Likely Finished Contour of Site

The entire site will be stripped of topsoil before works commence onsite. This is expected to result in approximately 3,000m³ of topsoil to be stripped to a depth of 300mm below the existing ground level. It is assumed that 1,600m³ of topsoil will be retained onsite for reuse. This will result in approximately 1,400m³ of topsoil to be cut to waste.

Following the construction of the CVSC, the hardstand area will have a 1.1% to 2.2% slope to direct stormwater to the stormwater swales and basins which form the perimeter of the site. The proposed finish contour of the site is shown in Figure 11 below and shown in plan C-2010 attached as Appendix D of this application.

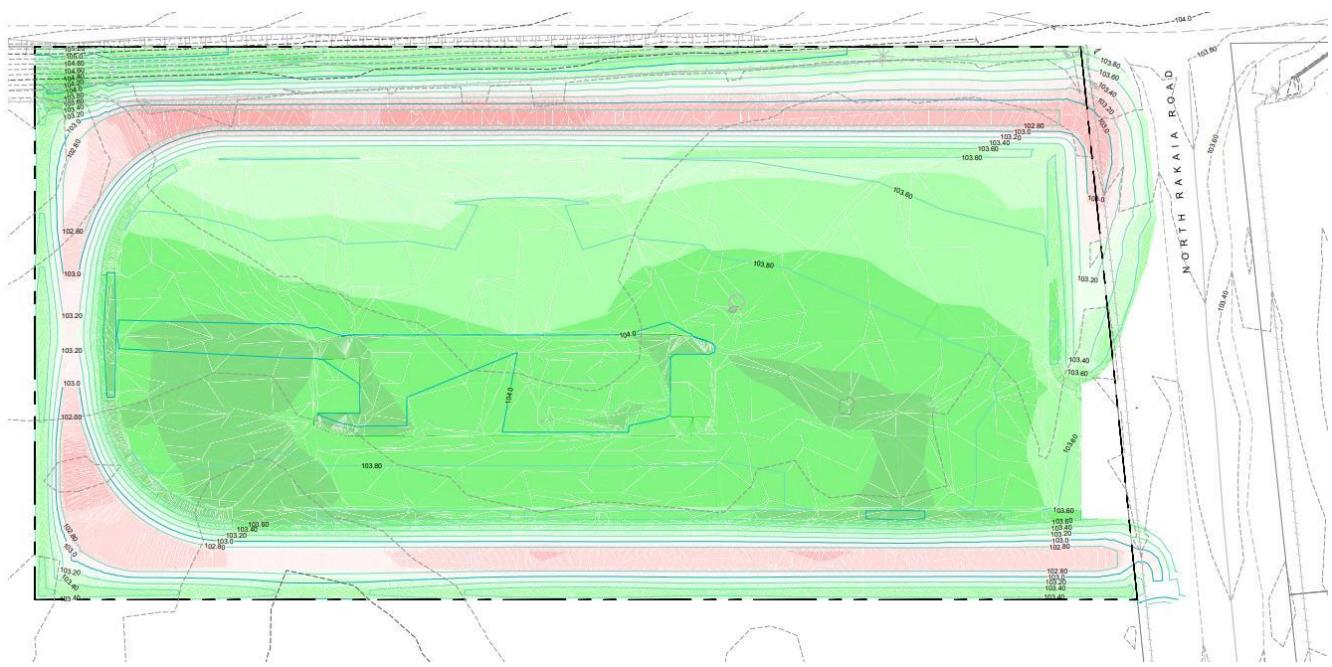


Figure 11: Finished site contour following the construction of the CVSC on Designation TR7. (Source: WSP).

10.3 Vehicular Access, Circulation, and Provision for Parking

Vehicle access upgrade works are proposed to occur in Designation TR7 (North Rakaia Road) to support the construction, operation, and maintenance of the CVSC. These works will only occur in Designation TR7.

No upgrade works associated with vehicular access, circulation, or provisions for parking will occur in Designation TR1 (State Highway 1).

10.3.1 Vehicular Access

As part of the development of the CVSC, North Rakaia Road will be upgraded. Upgrade works involve widening and sealing North Rakaia Road approximately 90m off State Highway 1. Permanent asphalt will be overlayed the existing gravel road surface.

Proposed upgrade works to North Rakaia Road are shown on the Plans attached in Appendix E of the application.

10.3.2 Circulation

The CVSC has been designed to direct entering vehicles over a weigh bridge and then either into an inspection lane or a bypass lane. Following, vehicles are able to exit the site and continue travelling south bound.

The CVSC can facilitate the circulation of a standard 17.9m truck + semi-trailer, and a 25m truck + single steer tri-drive + trailer capable of carrying a 10m wide load. The plans demonstrate how the above vehicles enter, circulate, and exit the CVSC. These plans are attached as Appendix E to this application.

10.3.3 Parking

Parking for all vehicles expected to utilise the CVSC will be provided within the CVSC site. A total of five car parks and one mobility car park will be provided onsite. These car parks will be used by Road Safety Officers and visitors to the site. Adequate space is provided onsite such that cars can enter and exit the site in a forward direction.

Provisions for parking are shown in Plans attached in Appendix E of the application.

10.4 Landscaping Proposed

10.4.1 Designation TR1 – State Highway 1

Minor landscaping is proposed within Designation TR1. This is limited to the re-instatement of grassed areas upon the completion of earthworks for signs and foundations. No further landscaping is proposed to occur within Designation TR1.

10.4.2 Designation TR7 – North Rakaia Road

Landscaping with Designation TR7 is limited to re-grassing stormwater basins following the completion of earthworks. No shrubs or trees are proposed to be planted onsite and they have potential to compromise sightlines resulting in increased crash risk and reduced safety onsite.

10.5 Any Other Matters

10.5.1 Management and Mitigation Measures

An approved erosion and sediment control will be prepared in accordance with Canterbury Regional Council's Erosion and Sediment Control Toolbox. This plan will be implemented during the construction of the CVSC. This plan is required as a condition of consent CRC202422 for earthworks activities.

A dust management plan will be prepared prior to the commencement of works on the CVSC. This plan will be implemented for the duration of works.

An erosion and sediment control plan, and dust management plan will mitigate potential adverse effects arising during the construction of the CVSC. If both plans are implemented and followed, construction activities are expected to have effects less than minor.

10.5.2 Permanent Traffic Impacts

The CVSC site is not expected to generate any additional traffic as site operators, police vehicles, and trucks directed to the CVSC are already traveling along State Highway 1.

10.5.3 Flood Zones and Fixed Floor Levels

The CVSC site is located within the Lower Plains Flood Area as shown on the Selwyn District Planning Maps. As part of the previous consenting process, a Flood Hazard Risk assessment was obtained from Canterbury Regional Council. This Flood Hazard Risk Assessment has been included as Appendix F of this application, and is summarised as follows:

- New buildings with floor levels of at least 104.3 m.a.s.l (Lyttleton 1937 Datum) are likely to provide some freeboard above the Rakaia River overflows. This equates to 600mm above the existing ground level.

The proposed Tier 1.5 Compliance Building will be placed on 600mm wooden piles and the building will have a fixed floor level of 104.99 m.a.s.l (Lyttleton 1937 Datum) as shown in the plans included in Appendix B of this application.

10.5.4 Compliance with Designation Conditions

| Designation TR7 (OSDP) | |
|---|--|
| <i>General Accordance with details provided in the NOR and plans attached in D190066 Appendix C updated 17/02/2020; the Addendum to the NOR 17/02/2020; and the response to the request for further information 27/03/2020;</i> | Not Applicable: Proposal seeks to remove this condition. |
| <i>10yr Lapse;</i> | Compliant: Proposal will give effect to Designation TR7. |
| <i>Prior to construction works being undertaken, engineering plans and specifications relating to the upgrade of the local road to be reviewed and approved by Council's Asset Manager, Transportation;</i> | Will Comply: Council's Asset Manager – Transportation has been consulted and is pending approval. |
| <i>Prior to commencement of operations, the operational management plan shall be provided to Council's Asset Manager, Transportation.</i> | Will Comply: Council's Asset Manager – Transportation will be provided with a copy of the operational management plan for the site. . |

The proposal has also been assessed against the conditions of Designation NZTA-7 of the Proposed Selwyn District Plan. This assessment is as follows:

| Designation NZTA-7 (PSDP) | |
|--|---|
| <ol style="list-style-type: none"> 1. <i>The designation shall be implemented in general accordance with the details provided with the Notice of Requirement:</i> <ol style="list-style-type: none"> a. <i>the Plans attached in Appendix C to the Notice of Requirement updated 17/02/2020;</i> b. <i>the Addendum to the Notice of Requirement dated 17/02/2020;</i> c. <i>the response to the request for further information dated 27/03/2020; and</i> d. <i>the response to the request for further information dated 17/04/2020.</i> | Not Applicable: Proposal seeks to remove condition |
| <i>2. Works undertaken in accordance with the NOR will not require an Outline Plan.</i> | Not Applicable: Works will be undertaken in accordance with proposed Outline Plan. |

| | |
|---|--|
| <p>3. <i>The designation shall lapse on the expiry of 10 years from the date on which it is included in the District Plan if it has not been given effect to before the end of that period.</i></p> | <p>Will Comply: Proposal will give effect to Designation NZTA-7</p> |
|---|--|

11 CONCLUSION

Pursuant to Section 181(1) of the RMA, Waka Kotahi gives notice of its requirement to alter existing Designation TR7 in the Operative Selwyn District Plan and Designation NZTA-7 in the Proposed District Plan. The proposed alteration to Designation satisfies the criteria outlined in s181(3) of the RMA. The proposed alteration is considered to be minor and can be processed on a non-notified basis.

The proposed alteration to designation will have positive effects in allowing the development to occur and will contribute to the effective enforcement of overweight and unsafe vehicles, reduced wear and maintenance on the road network, establish fair market conditions for compliant heavy vehicle operators, and increase the safety of other road network users.

The assessment of actual and potential effects concludes that any adverse effects of the proposed alteration to designation will be less than minor.

The proposal is in accordance with the designated purpose of the site. The works will enable Waka Kotahi to continue to ensure the state highway network remains resilient and fit for purpose.

Waka Kotahi as the Requiring Authority and by virtue of giving Notice, agrees to the alteration of the designation.

The bulk and location of the proposed works has been confirmed in the Outline Plan that forms part of this application. It is therefore concluded that pursuant to Section 176A of the RMA, the Selwyn District Council can confirm the Outline Plan for the works within TR1, TR7 without any modification.

APPENDIX A

WAKA KOTAHI NZ

**TRANSPORT AGENCY
RAKAIA SOUTHBOUND
WEIGH RIGHT PROGRAMME**

**CIVIL
TENDER**


Project No: 5C4353-WSP-09-DR-
Date: 2022.04.22

NOTES



- NOTE:**

 1. OFFLOAD AREA IS DESIGN FOR A TRUCK TO REVERSE INTO ONLY.
 2. PAVEMENT MARKING TO COMPLY WITH CURRENT NZTA STANDARDS AND RELEVANT SECTION OF MOTS, INCLUDING PROVISION OF RPMAS

LEGEND:

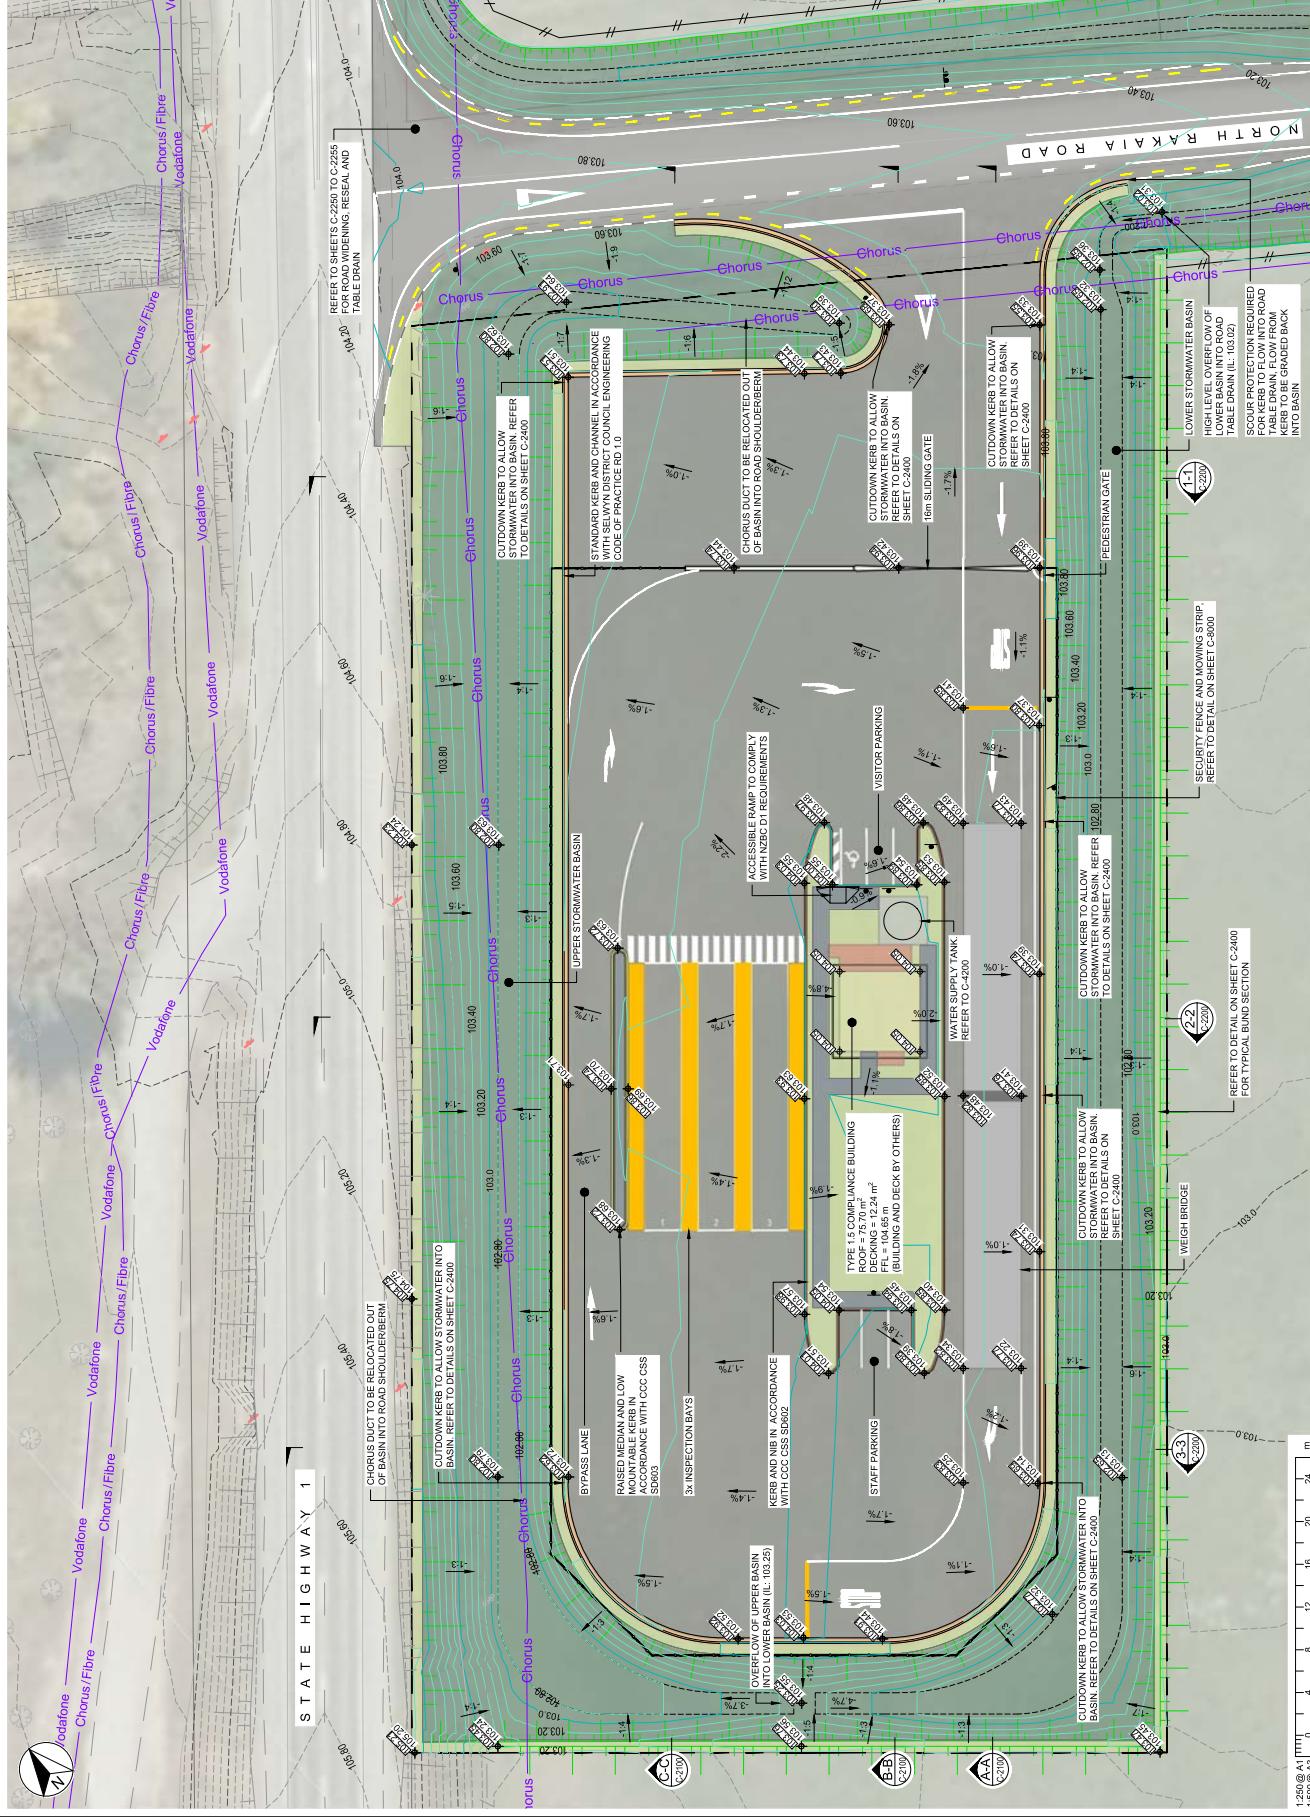

| | | | |
|--|-----------------|---------------|-------------------|
| REVISION | | AMENDMENT | |
| A | FOR INFORMATION | B | FOR REVIEW |
| C | FOR PRICING | D | ISSUED FOR TENDER |
| | | | |
| APPROVED | | DATE | |
| LS | 2021/12/21 | BS | 2022/01/27 |
| BS | 2022/04/27 | B.S. | |
| | | | |
| APPROVED | | DATE | |
| DESIGNED | C. NELLES | APPROVED | B. STERLING |
| DRAWINGS/VERIFIED | L. SMARCKA | APPROVED DATE | 2021/12/17 |
| C. NELLES | | | |
| | | | |
| PROJECT CT | | ORIGINAL SIZE | |
| WAKA KOTAHİ NZ TRANSPORT AGENCY | | A1 | |
| RAKAI SOUTHBOUND | | | |
| WEIGHT RIGHT PROGRAMME | | | |
| COMMERCIAL VEHICLE SAFETY CENTRE | | | |
| GENERAL LAYOUT | | | |
| WSP PROJECT NO. (SUB-PROJECT) | | SHEET NO. | |
| 5C4353-WSP-09-DR- | | C-2010 | |
| | | REVISION | |
| | | D | |
| TENDER | | | |
| CIVIL | | | |
|  WAKA KOTAHİ NZ TRANSPORT AGENCY | | | |
|  WSP Wellington Office PO Box 2403 Wellington 6144 New Zealand +64 4 471 7000 | | | |

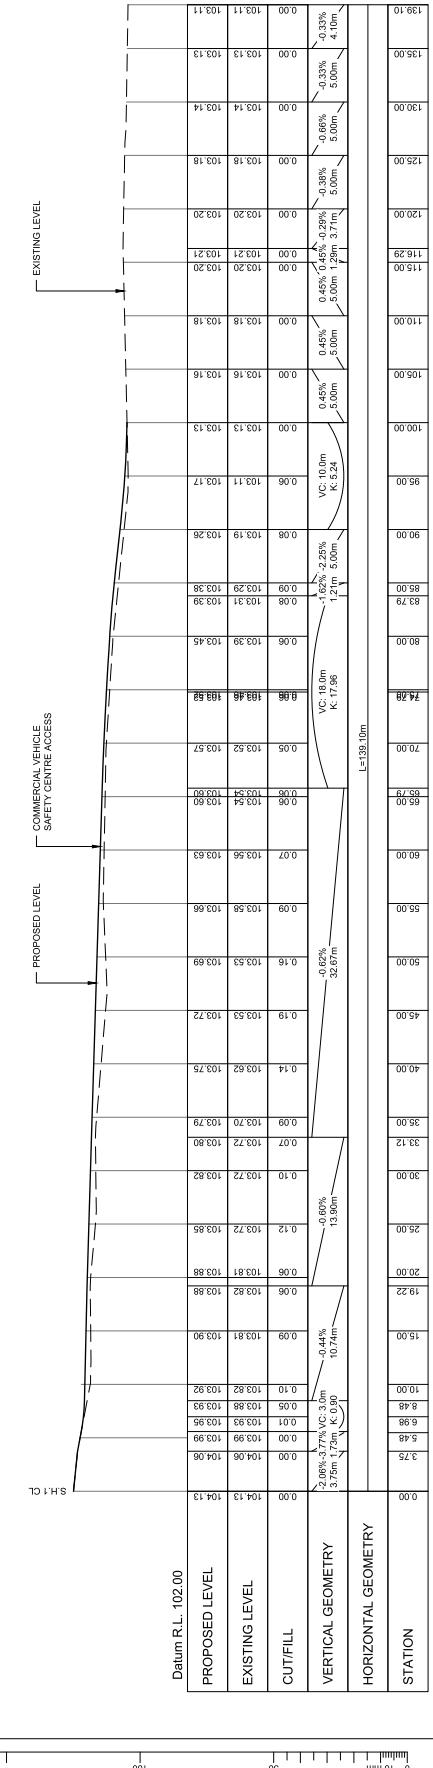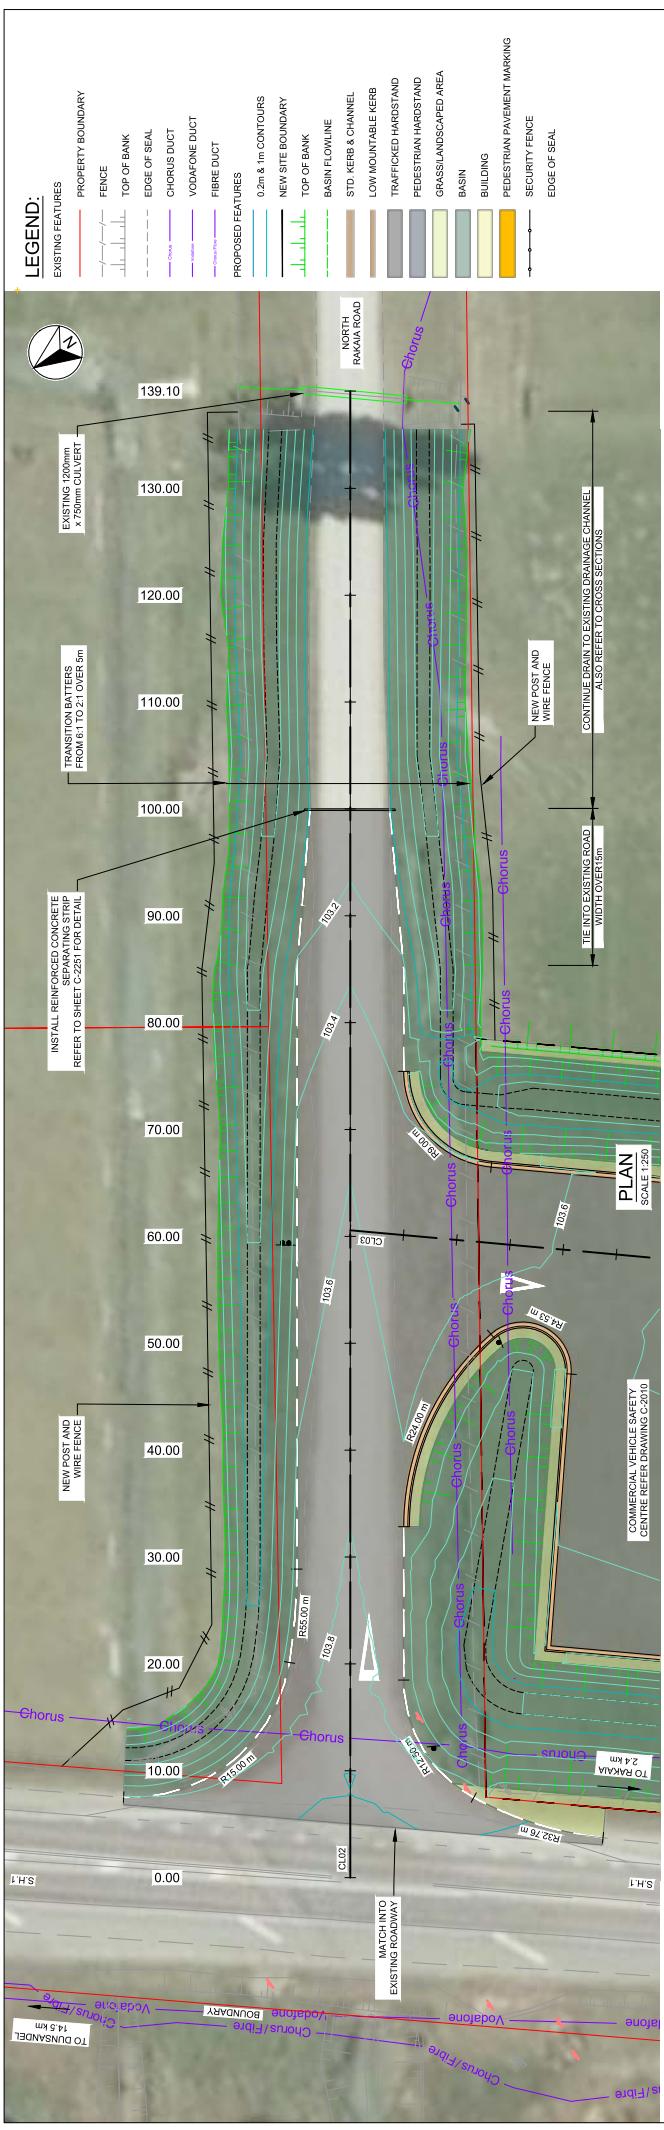


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SCALE HORZ 1:250 VERT 1:50





WAKA KOTAHİ
NZ TRANSPORT
AGENCY

TENDER CIVIL

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|----------------------------------|------------------------------------|---|
|----------------------------------|------------------------------------|---|

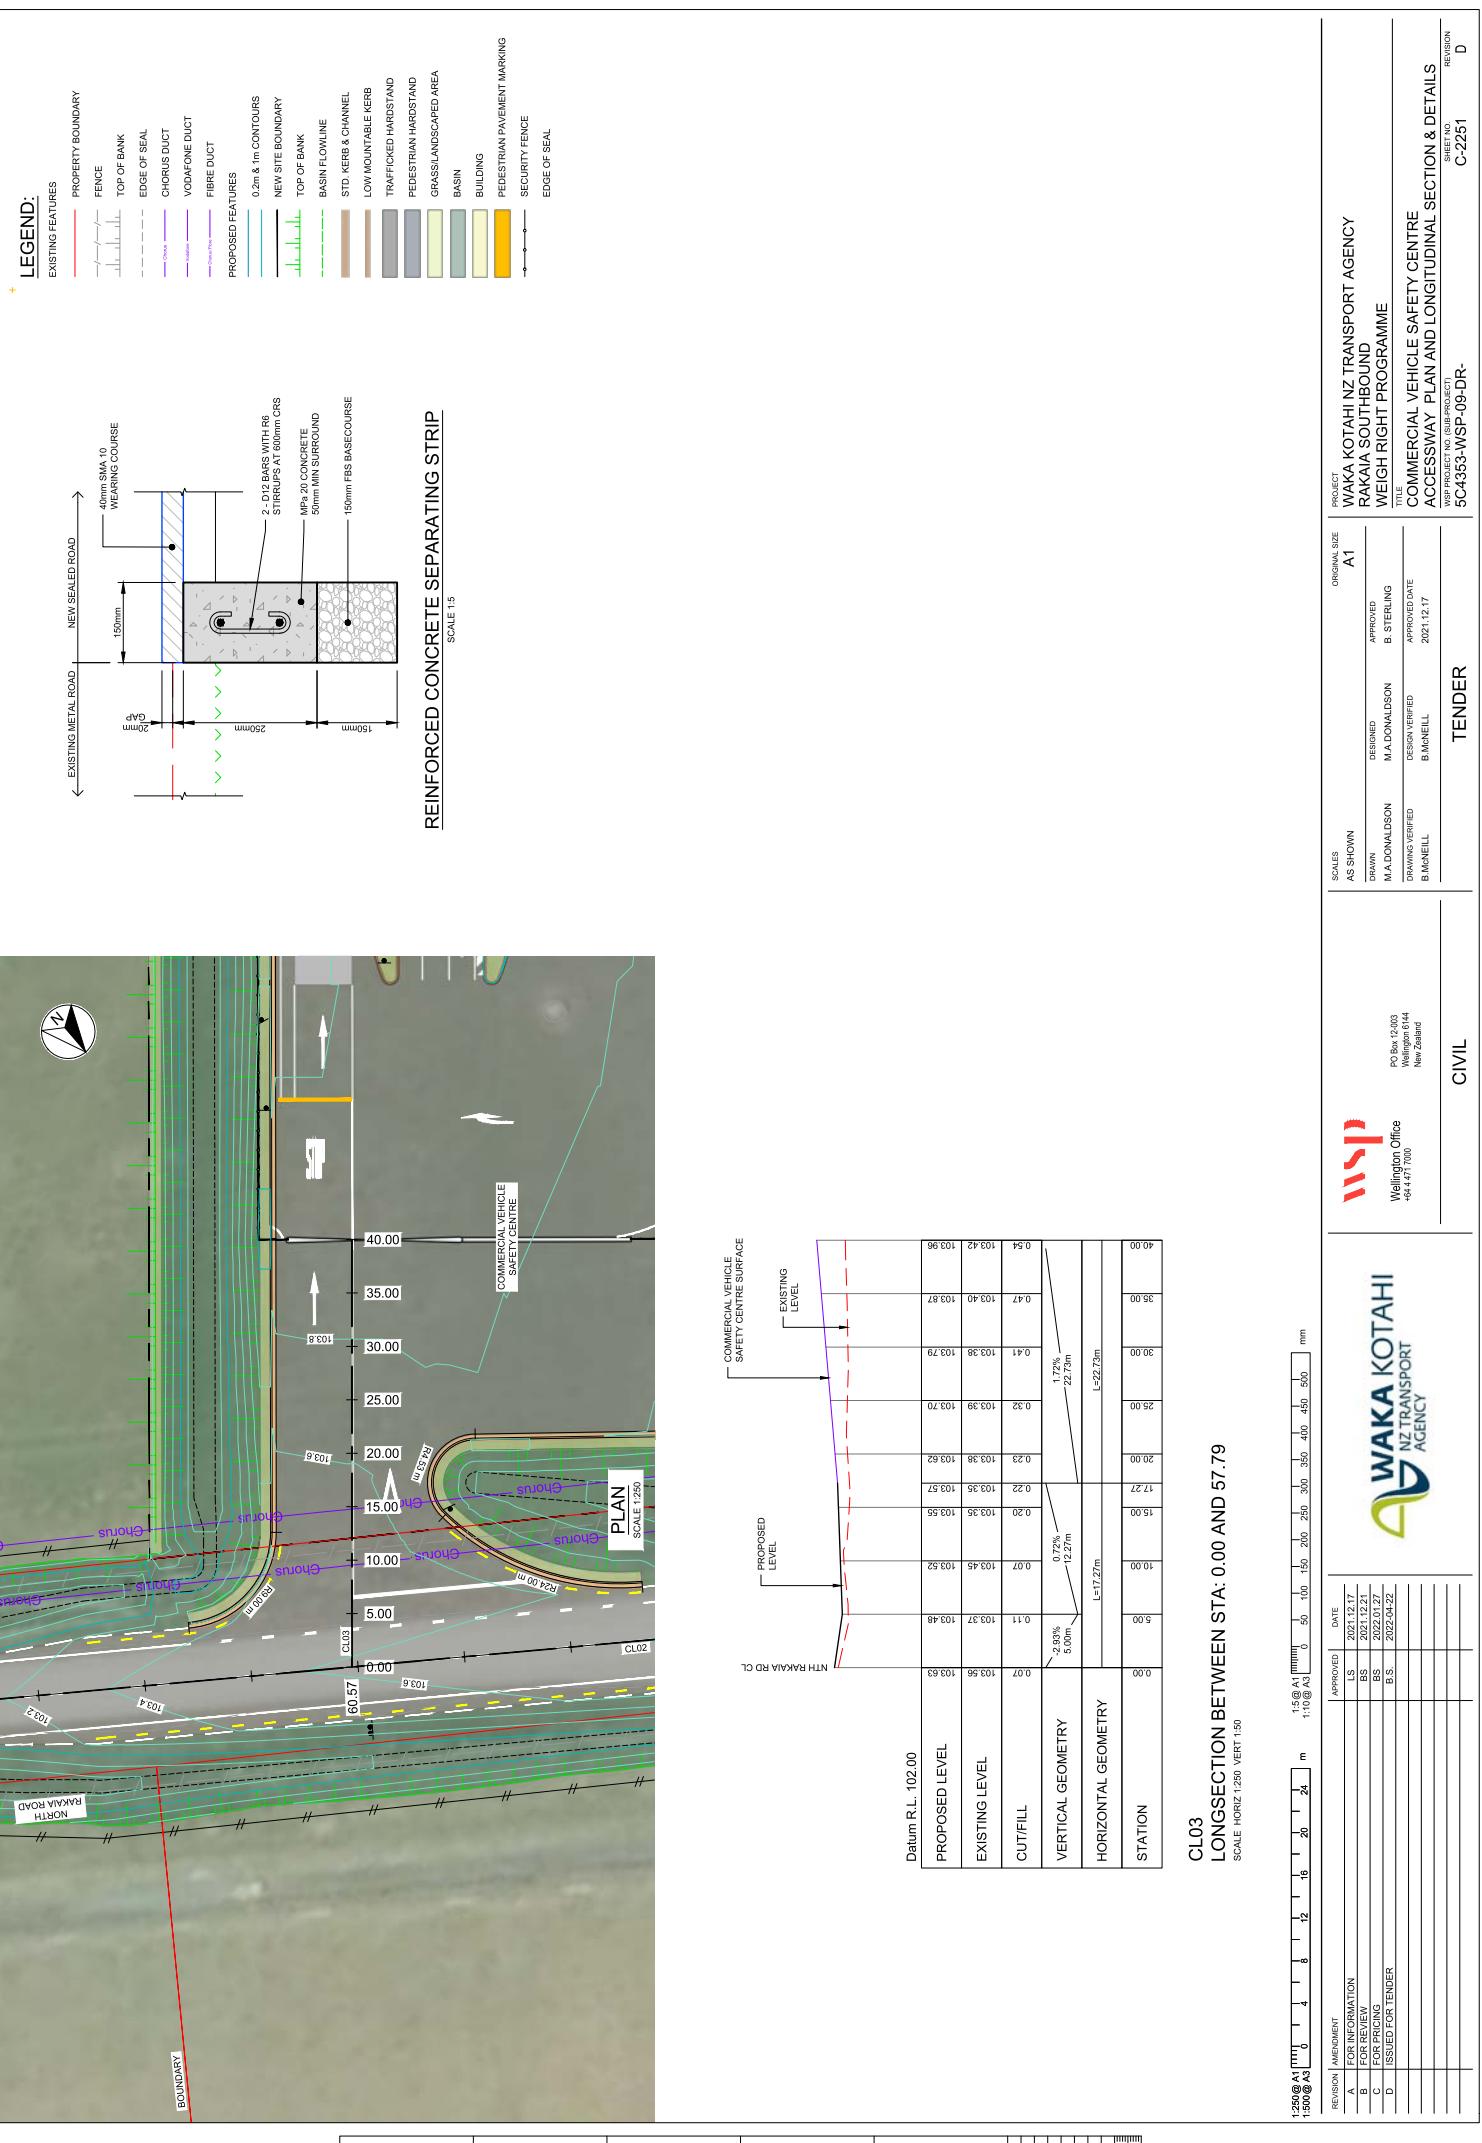

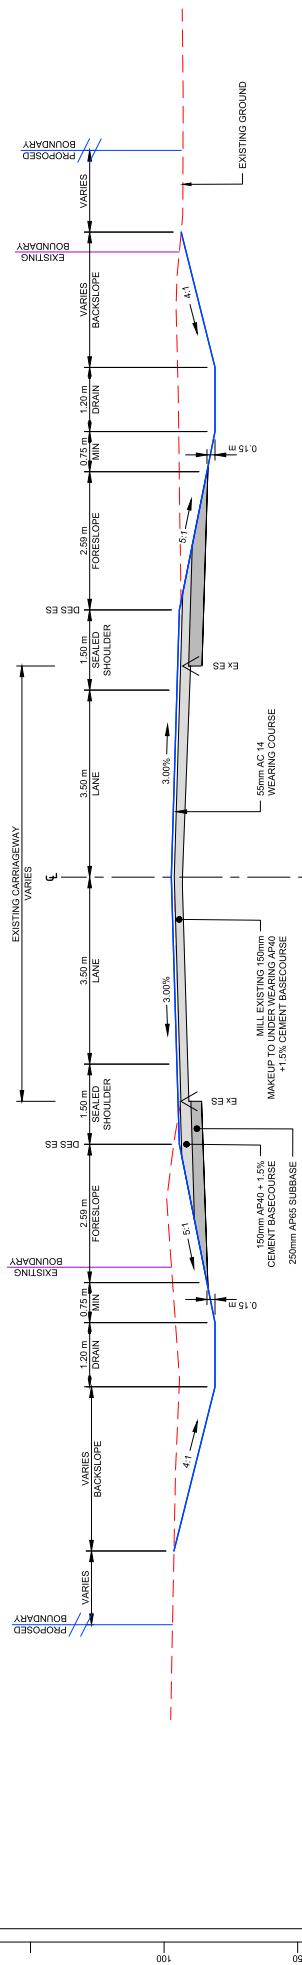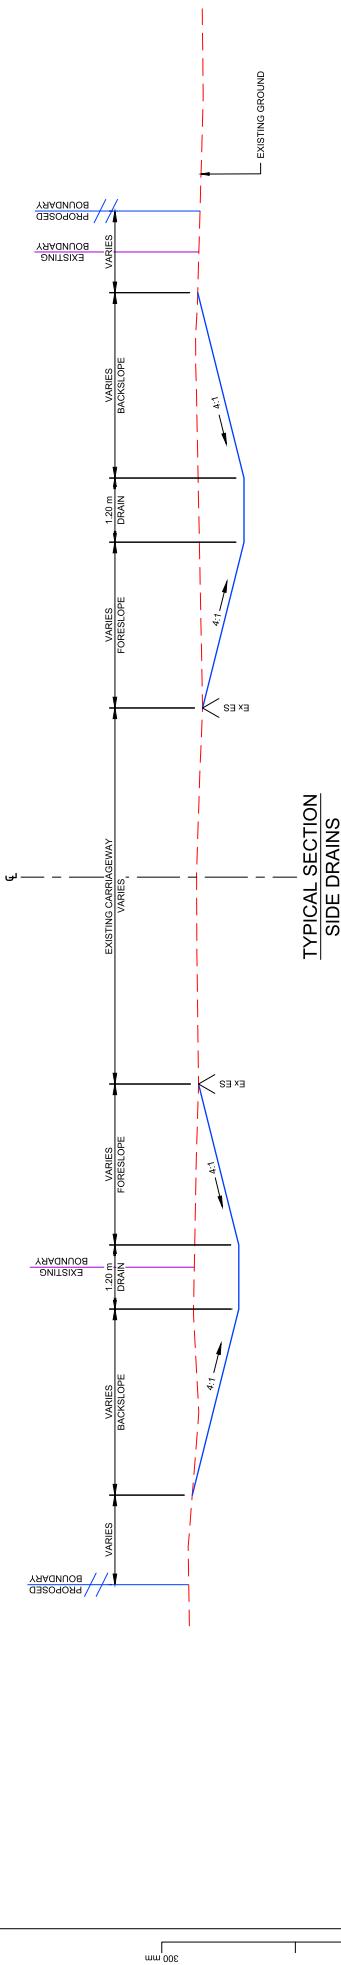

TYPICAL SECTIONS

SC441-150



WAKA KOTAHİ
NZ TRANSPORT
AGENCY

WAKA SOUTHERN
WEIGH RIGHT PROGRAMME

COMMERCIAL VEHICLE SAFETY CENTRE
NORTH RAKAIA ROAD TYPICAL SECTIONS

WSP PROJECT NO. SUEP/RACK/5C4353-WSP-09-DR-

SHEET NO.
C-2552

REVISION NUMBER
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150 @ A1
0 10 mm
300 mm

ORIGINAL SIZE
A1

PROJECT
RAKAI SOUTHERN
WEIGH RIGHT PROGRAMME

TITLE
COMMERCIAL VEHICLE SAFETY CENTRE
NORTH RAKAIA ROAD TYPICAL SECTIONS

WSP PROJECT NO. SUEP/RACK/5C4353-WSP-09-DR-

SHEET NO.
C-2552

REVISION NUMBER
1:000 @ A3
150 @ A1
0 10 mm
300 mm

ORIGINAL SIZE
A1

PROJECT
RAKAI SOUTHERN
WEIGH RIGHT PROGRAMME

TITLE
COMMERCIAL VEHICLE SAFETY CENTRE
NORTH RAKAIA ROAD TYPICAL SECTIONS

WSP PROJECT NO. SUEP/RACK/5C4353-WSP-09-DR-

SHEET NO.
C-2552

REVISION NUMBER
1:000 @ A3
150 @ A1
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300 mm

ORIGINAL SIZE
A1

PROJECT
RAKAI SOUTHERN
WEIGH RIGHT PROGRAMME

TITLE
COMMERCIAL VEHICLE SAFETY CENTRE
NORTH RAKAIA ROAD TYPICAL SECTIONS

WSP PROJECT NO. SUEP/RACK/5C4353-WSP-09-DR-

SHEET NO.
C-2552

REVISION NUMBER
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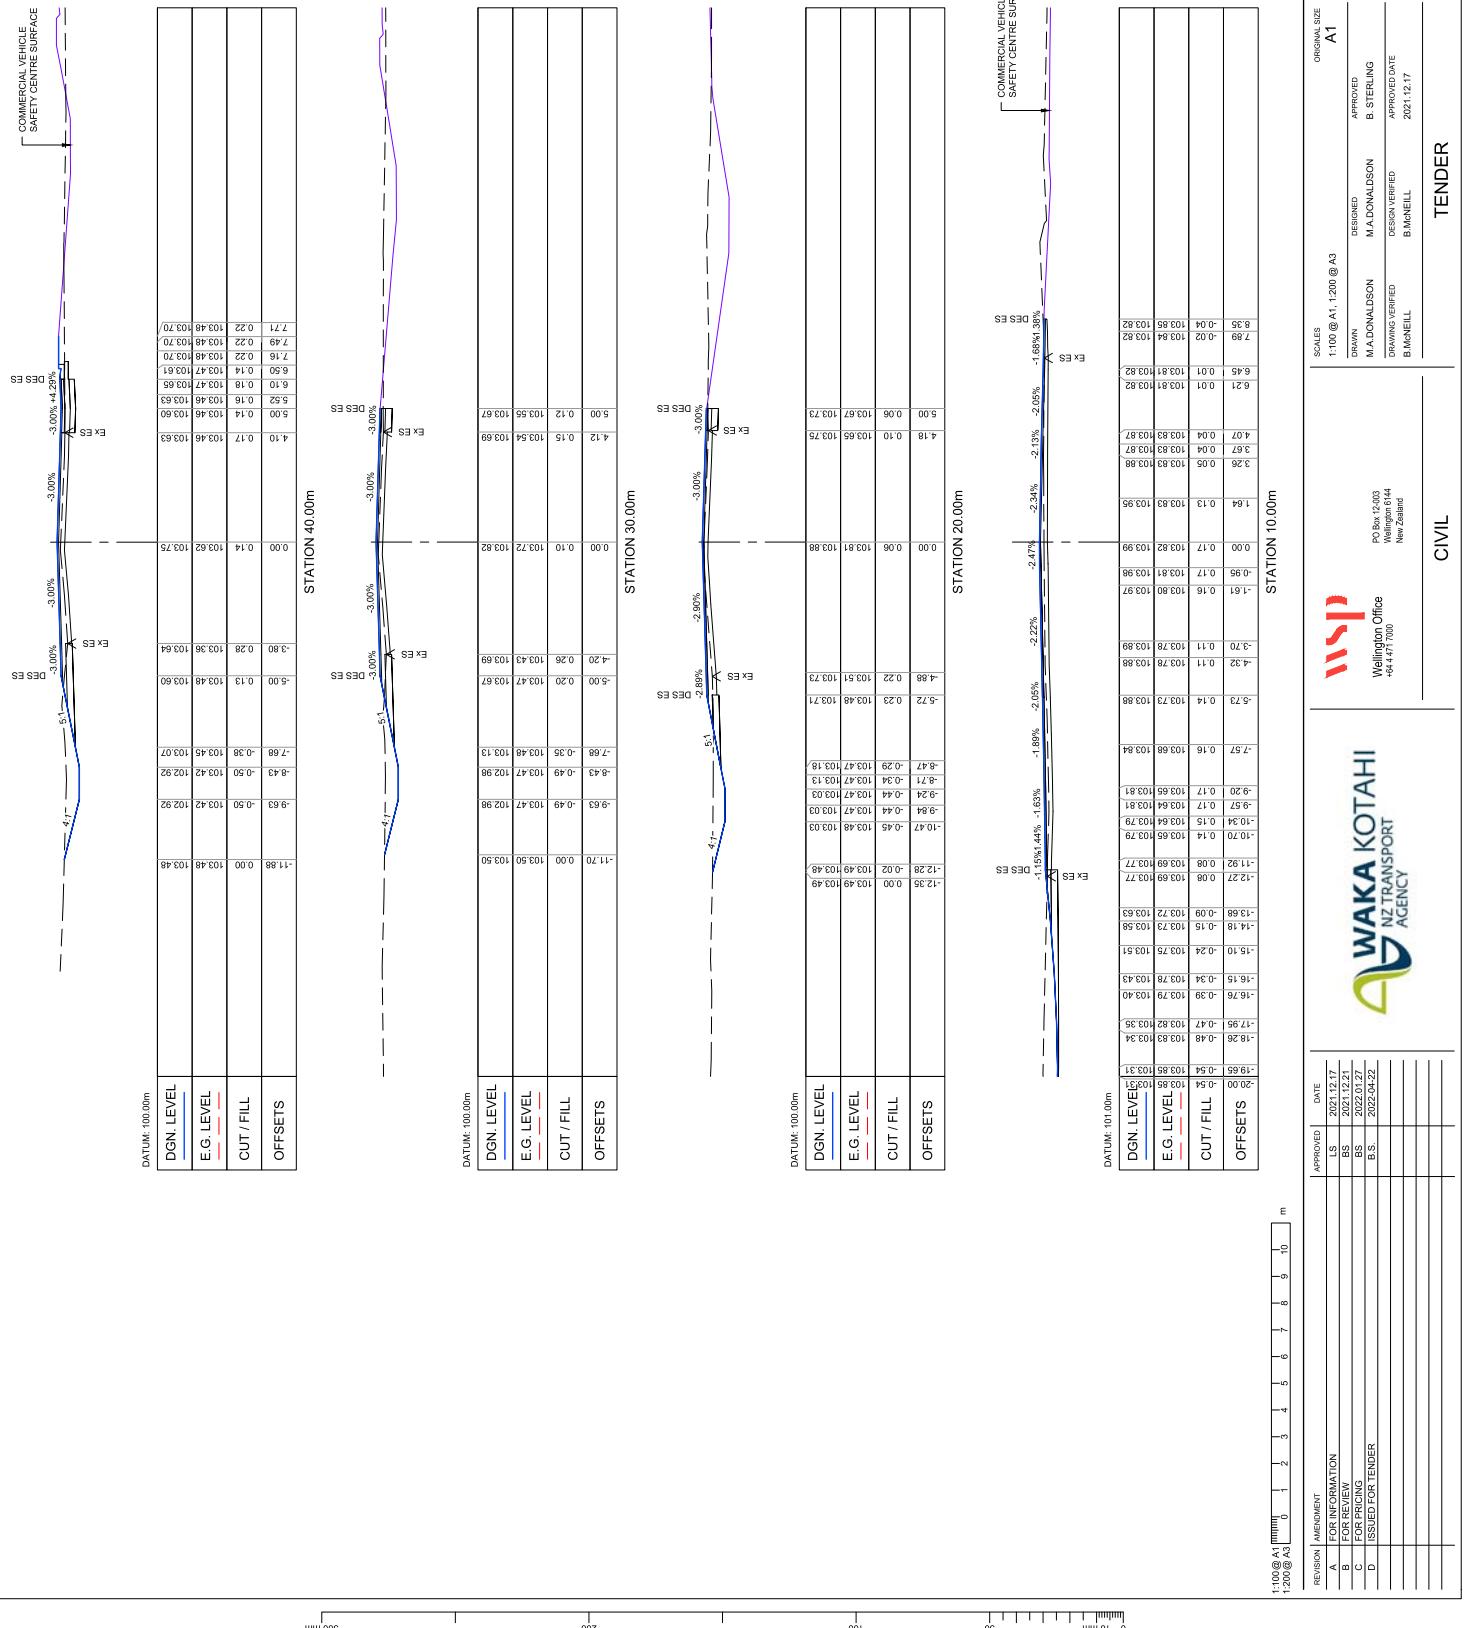
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A1


PROJECT
RAKAI SOUTHERN
WEIGH RIGHT PROGRAMME

TITLE
COMMERCIAL VEHICLE SAFETY CENTRE
NORTH RAKAIA ROAD TYPICAL SECTIONS

WSP PROJECT NO. SUEP/RACK/5C4353-WSP-09-DR-

SHEET NO.
C-2552



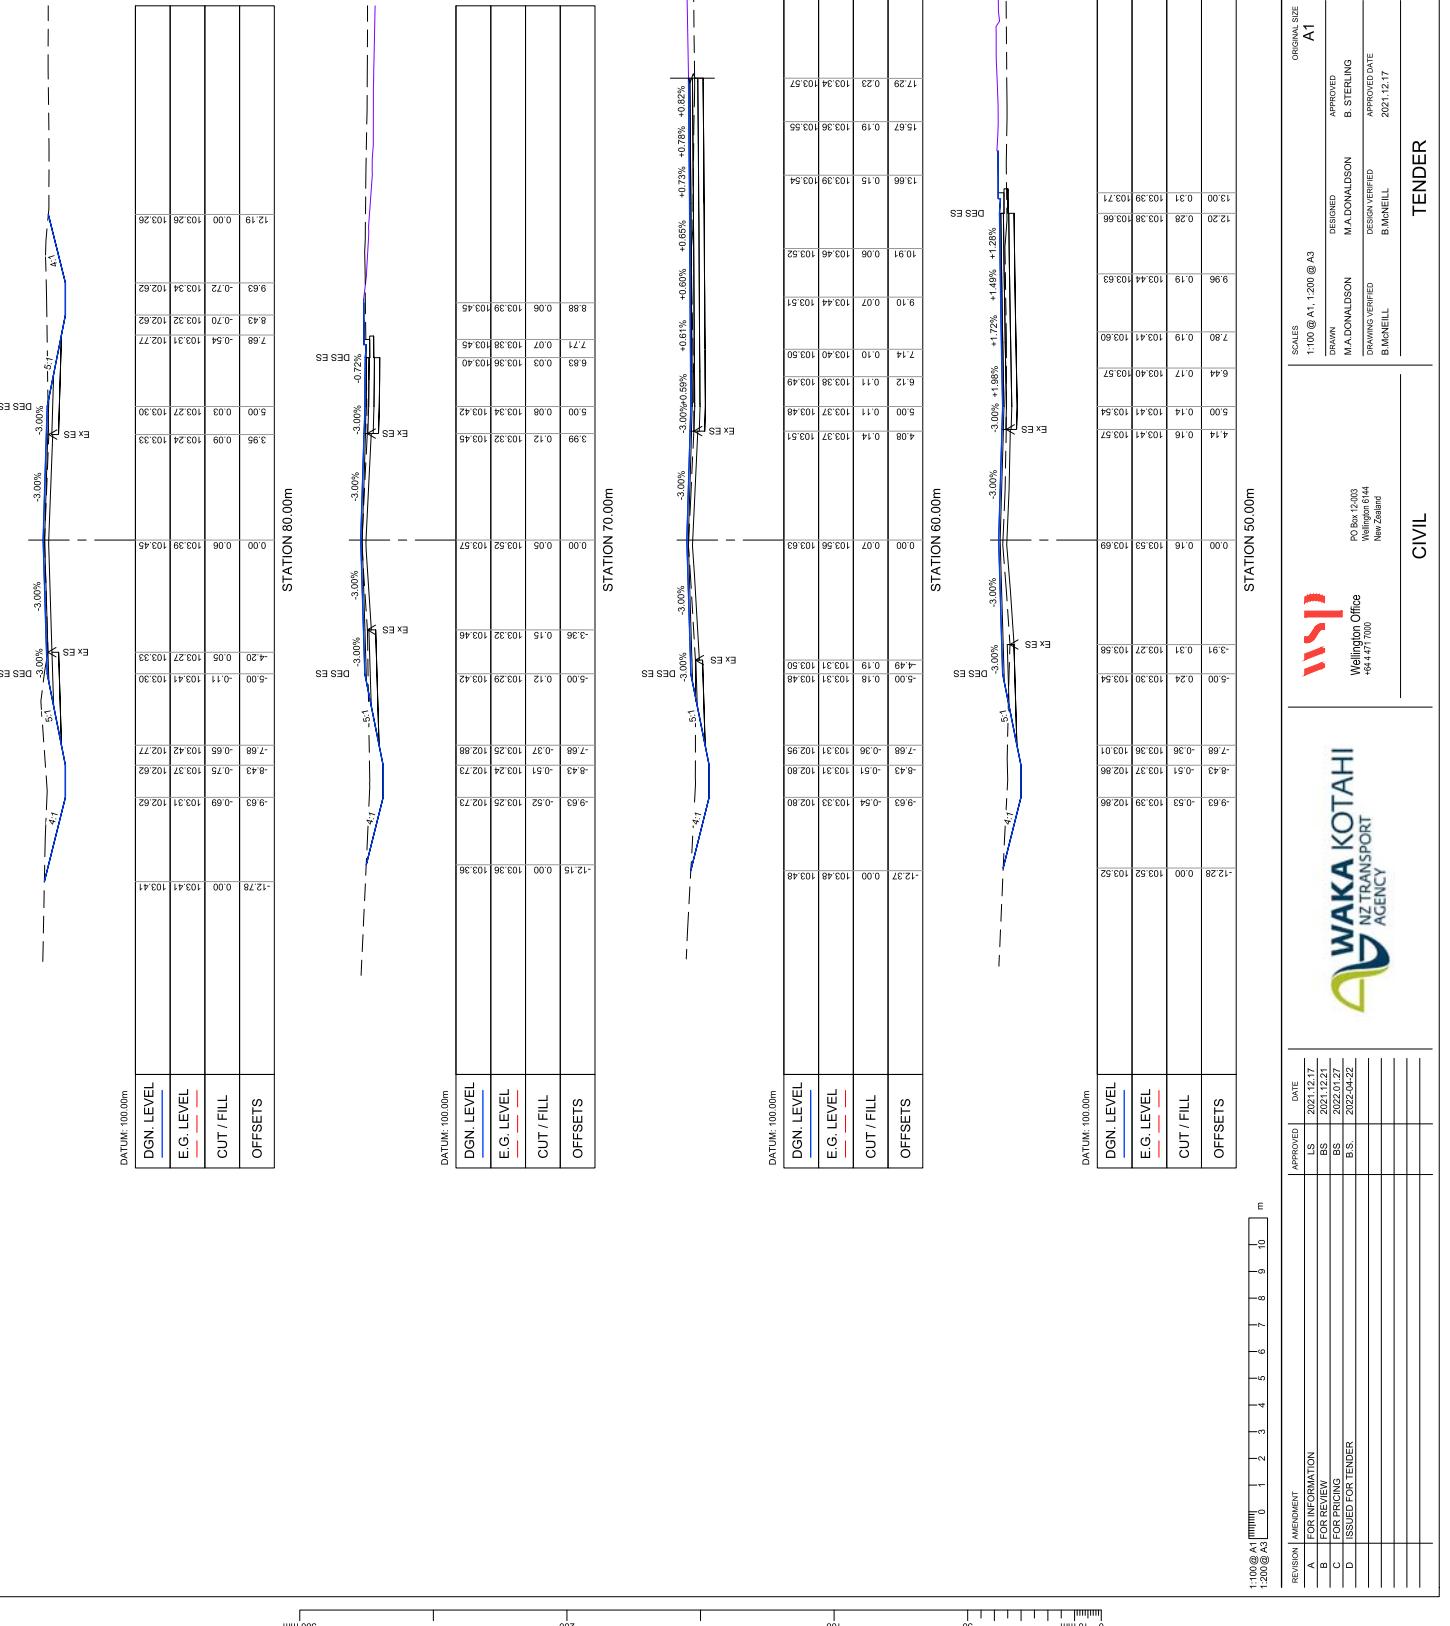

CONTINUE DRAINS TO MERGE INTO
EXISTING DRAINAGE CHANNEL AT
ROAD CALLVERT 1.375 - 103.00

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|-----------------|------------|------------|---------|
| STATION 100.00m | | | |
| DGN LEVEL | E.G. LEVEL | CUT / FILL | OFFSETS |
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| 102.82 | -0.50 | 0.50 | 102.82 |
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| 98.60 | -4.72 | 4.72 | 98.60 |
| 98.58 | -4.74 | 4.74 | 98.58 |
| 98.56 | -4.76 | 4.76 | 98.56 |
| 98.54 | -4.78 | 4.78 | 98.54 |
| 98.52 | -4.80 | 4.80 | 98.52 |
| 98.50 | -4.82 | 4.82 | 98.50 |
| 98.48 | -4.84 | 4.84 | 98.48 |
| 98.46 | -4.86 | 4.86 | 98.46 |
| 98.44 | -4.88 | 4.88 | 98.44 |
| 98.42 | -4.90 | 4.90 | 98.42 |
| 98.40 | -4.92 | 4.92 | 98.40 |
| 98.38 | -4.94 | 4.94 | 98.38 |
| 98.36 | -4.96 | 4.96 | 98.36 |
| 98.34 | -4.98 | 4.98 | 98.34 |
| 98.32 | -5.00 | 5.00 | 98.32 |
| 98.30 | -5.02 | 5.02 | 98.30 |
| 98.28 | -5.04 | 5.04 | 98.28 |
| 98.26 | -5.06 | 5.06 | 98.26 |
| 98.24 | -5.08 | 5.08 | 98.24 |
| 98.22 | -5.10 | 5. | |

APPENDIX B

NEW ZEALAND TRANSPORT AGENCY

TIER 1.5 - CONTROL BUILDING

51-34037



NTIA TIER 1.5 TYPE CONTROL BUILDING.
THIS IS A STANDARDISED BUILDING TYPE THAT IS CONSTRUCTED AT SEVERAL SITES
REFER TO SPECIFIC SITE PLAN OR LOCATION OF CONTROL BUILDING WITHIN SITE
THIS BUILDING HAS BEEN DESIGNED TO THE FOLLOWING WORST CASE SCENARIO SITE
CONDITIONS
WINDZONE: VERY HIGH
EARTHQUAKE ZONE: 3
EXPOSURE ZONE: ZONE D
WHERE THE PROPOSED LOCATION OF THE TIER 1.5 BUILDING TYPE EXCEEDS TO THE ABOVE
SCENARIOS, THEN THE BUILDING WILL NEED TO BE DESIGNED SPECIFICALLY FOR THE SITE.

| DRAWING LIST | | | |
|--------------|-----------------|------------------|-------------------------------|
| DRG NO. | PROJECT No. | HEET | DRAWING TITLE |
| | | CURRENT REVISION | |
| | TIER1.5-CT-BLDG | | ARCHITECTURAL DRAWING INDEX |
| | A001 | | GENERAL LAYOUTS |
| | A010 | | GENERAL ARRANGEMENT PLAN |
| | A011 | 2 | SET OUT PLAN |
| | A012 | | SECURITY PLAN |
| | A015 | | REFLECTED CEILING PLAN |
| | A10 | | ROOF PLAN |
| | A10 | | SUB FLOOR FRAMING PLAN |
| | A120 | | FLOOR FRAMING PLAN |
| | A121 | | ROOF FRAMING PLAN |
| | A122 | | EXTERIOR RAMP & STAIR DETAILS |
| | A160 | | EXTERIOR ELEVATIONS |
| | A201 | | EXTERIOR ELEVATIONS |
| | A250 | | SECTION ELEVATIONS |
| | A300 | | STRUCTURE & CIVILS |
| | A301 | | MECHANICAL SYSTEMS |
| | A301 | | MECHANICAL SYSTEMS |
| | A400 | | BALCONIES |
| | A401 | | SECTION DETAILS |
| | A410 | | WINDOW DETAILS |
| | A415 | | DOOR DETAILS |
| | A50 | | DOOR & WINDOW SCHEDULE |
| | A800 | | HYDRAULICS PLANNING PLAN |
| | A801 | | MECHANICAL LAYOUT PLAN |
| | A800 | | POWER & COMMS LAYOUT |
| | A801 | | LIGHTING LAYOUT |

TENDER / CONSENT

NEW ZEALAND TRANSPORT AGENCY
Project TIER 1.5 - CONTROL BUILDING
creativespaces
ARCHITECTURAL DRAWING INDEX

Rev: 1

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Scale: 1:1

Date:

Drawn Date

06/07/19

Checked Date

06/07/19

Approved Date

06/07/19

Project No.: 51-34037-A001

Code File No.: G51-34037-A001

Page Date: 15/07/2019 10:37:34

No. Revision

1

ARCHITECTURAL SYMBOLS

| | |
|--|---|
| | CENTRELINE OF ELEMENT |
| | TILE SETOUT POINT |
| | BUILDING GRID SETOUT POINT |
| | LEVEL DATUM - TOP OF ELEMENT LEVEL DATUM - BOTTOM OF ELEMENT |
| | PLAN SPOT RELATIVE LEVEL |
| | FALL |
| | RL 1245 |
| | FULL DIRECTION SYMBOLS |
| | CEILING TAG |
| | DOOR TAG |
| | ROOM NUMBER |
| | WALL TYPE TAG |
| | WINDOW TAG |
| | CURTAIN WALL TAG |
| | CONCRETE FLOOR SLAB SETDOWN |
| | CONCRETE FLOOR SLAB EDGE |
| | PLAN - FINISH FLOOR LEVEL |
| | PLAN - SLAB LEVEL |

EXTERNAL COLOUR SELECTIONS:

| | |
|--|---|
| | DULUX GREY FAIRFAX |
| | RESINE GREEN LEAF |
| | CORROSTEEL GREY FAIRFAX |
| | GREY FAIRFAX PAINT FINISH |
| | GREY FAIRFAX PAINT FINISH |
| | GREY FAIRFAX PAINT FINISH |
| | SUPERIOR PAINT COLOUR POWDERCOAT GREY FAIRFAX |
| | BLACK ANODISED GREY FAIRFAX |
| | EXTERIOR DECORATIVE TRIMS RESINE ALABASTER |
| | LUMBAR TRIM RESINE ALABASTER |

| | |
|--|---------------------|
| | RESINE ALABASTER |
| | CEILING WALLS |
| | INTERIOR DOOR TRIMS |
| | RESINE GREY FAIRFAX |
| | RESINE ALABASTER |

FLOOR FINISHES:

| | |
|--|---|
| | FLOOR FINISHES |
| | INSTALL FLOORING VINYL TO ALL SPACES |
| | TARKETT CARPET |
| | COLOR 46 |
| | SHIRTING TRIM 9x16 BEVELLED PINE F-J SHIRTING PROFILE |

TENDER / CONSENT


NEW ZEALAND TRANSPORT AGENCY TIER 1.5 - CONTROL BUILDING ARCHITECTURAL WORKS GENERAL ARRANGEMENT PLAN

Rev: A

Client
Project
Title
Scale
As indicated

Location 1, GPO, Dunedin, Dunedin, New Zealand
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Drawing No: 51-34037-A100
A1
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GENERAL ARRANGEMENT PLAN

SCALE 1:25
0 250 500 750 1000 1250mm
SCALE 1:25 AT ORIGINAL SITE
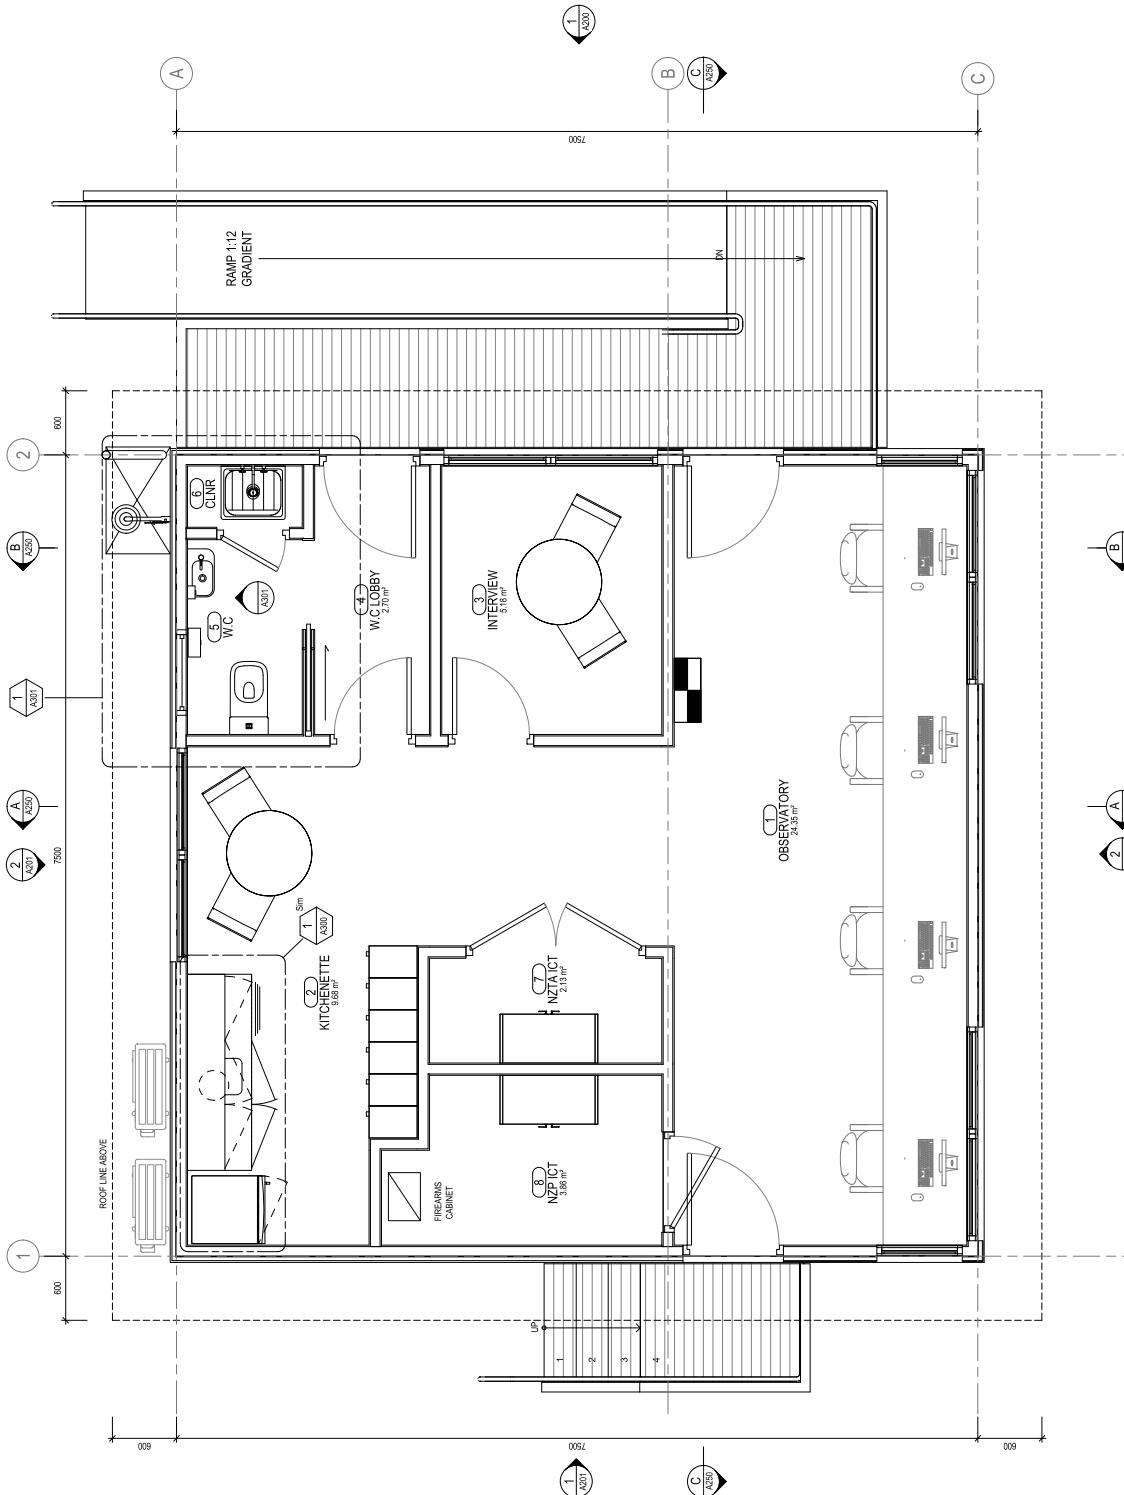
| 06/07/19 | RW | Drawn | Date |
|-------------------------------|----|----------|----------|
| 06/07/19 | RW | 06/07/19 | 06/07/19 |
| A CONSENT ISSUE | | | |
| A CLIENT REVIEW | | | |
| No Revision | | | |
| Per Date: 15/10/2018 10:37:36 | | | |

| ARCHITECTURAL SYMBOLS | |
|--------------------------|---------------------------------|
| € | CENTRELINE OF ELEMENT |
| ◆ | FILE SET OUT POINT |
| — | LEVEL DATUM - TOP OF ELEMENT |
| ▲ | LEVEL DATUM - BOTTOM OF ELEMENT |
| ◆ | PLAN/RELATIVE LEVEL |
| ◆ | FALLOUT/RETURN SYMBOL |
| ◆ | FALL |
| ACT 2400 | CEILING TAG |
| (C) | DOOR TAG |
| GUD | ROOM NUMBER |
| WLT | WALL TYPE TAG |
| WTAG | CURTAIN WALL TAG |
| SD | CONCRETE FLOOR SUB-BEAM |
| SD | CONCRETE FLOOR SLAB EDGE |
| PLAN- FINISH FLOOR LEVEL | PLAN- SLAB LEVEL |
| SL 00/000 | PLAN- |


INSULATION NOTES:

ROOF:
FIT R3.0 FIBERGLASS BATS TO ALL CEILING SPACES
PINK BATT'S & SKULL ROOF INSULATION SHALL
BE INSTALLED IN THE ROOF DACHE 25MM
AIR GAP BE TWEEN INSULATION AND ROOF - UNDELAY

WALL INSULATION:
EXTERIOR WALLS ARE TO BE INSULATED WITH R2.8
PINK BATT'S OR FIBERGLASS BATS

UNDERFLOOR INSULATION:
MAMOTH POLYESTER 19 UNDERFLOOR SECTIONS
FITTED BETWEEN FLOOR JOISTS

BRACING LEGEND

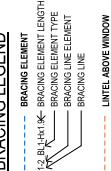

| ROOM SCHEDULE | | |
|---------------|-------------|---------------------|
| Number | Name | Area |
| 1 | OBSERVATORY | 24.35m ² |
| 2 | H BIEGE | 0.53m ² |
| 3 | INTERVIEW | 5.33m ² |
| 4 | WC C/B | 2.70m ² |
| 5 | WC | 1.96m ² |
| 6 | C/NR | 0.62m ² |
| 7 | NZ/ACT | 2.13m ² |
| 8 | Nz/CT | 3.88m ² |

FLOOR LEGEND

| FLOOR TYPES: | |
|--------------|------------------|
| F01 | TIMBER FLOOR |
| F02 | 19mm THERMO WOOD |
| F03 | 19mm THERMO WOOD |
| F04 | 19mm THERMO WOOD |
| F05 | 19mm THERMO WOOD |
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| F379 | 19mm THERMO WOOD |

CEILING LEGEND

| | |
|--|------|
| PLASTERBOARD CEILING PAINTED | C101 |
| ROUNDED PLASTERBOARD, LA PAINTED | C102 |
| 300mm ROOF CELINGS BATTENS ON GIB 225 CLIP FRIED TO ROOF FRAMING | |
| SOFFIT LINING | C103 |
| 6mm THICK FIBRE CEMENT SHEET | C104 |
| PREPARED JOINTERS | C105 |
| SAFETY FRAMING | C106 |
| PAINTED | |

CEILING NOTES

- REFERS TO ELECTRICAL DRAWINGS TO COORDINATE LIGHTING AND FOR INSTALLATION DETAILS
- REFER TO SERVICES DRAWINGS FOR OTHER REQUIRED SERVICES ACCESS POINTS
- PROVIDE ACCESS PANEL IN CEILING AS ACCORDING TO BUILDING SERVICES REQUIREMENTS
- CEILING PLAN TO BE READ IN CONJUNCTION WITH BUILDING SERVICES AND RELEVANT FITTINGS TO LOG WHERE SPACED EVERY 1000mm
- CEILING DOCUMENT FITTINGS TO LOG WHERE SPACED EVERY 1000mm
- PROVIDE ADDITIONAL SUPPORT IN THE CEILING SUSPENSION SYSTEM WHERE CEILING MOUNTED CURTAIN TRACKS ARE USED. FITTINGS SPACED TO ALIGN WITH POSSIBLE CEILING LINE AND SPACED EVERY 1000mm
- CURTAIN TRACKS ARE TO BE LOGGED FITTINGS SPACED EVERY 1000mm
- ALWAYS POSSIBLE TO CEILINE LINE AND SPACED EVERY 1000mm

TENDER / CONSENT

NEW ZEALAND TRANSPORT AGENCY
TIER 1.5 - CONTROL BUILDING
ARCHITECTURAL WORKS
REFLECTED CEILING PLAN

Rev: 1
Drawing No: 51-34037-A105
A1 Drawing No: 51-34037-A105
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Client: New Zealand Transport Agency
Project: Tier 1.5 - Control Building
Title: Architectural Works
Scale: DO NOT SCALE
Sheet: 1:25

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REFLECTED CEILING PLAN

Scale: 1:25

0 250 500 750 1000 1250mm
SCALE 1:25 AT ORIGINAL SITE

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| 1 CONSENT ISSUE | Date |
| No Revision | Drawn Date |
| Proj Date: 15/10/2018 10:37:37 | Code File No: G161134037C000Rev01Tier1.5TRWB1.5.RWKA.dwg |
| 1 CONSENT ISSUED | |
| No Revision | Date |
| Proj Date: 15/10/2018 10:37:37 | Code File No: G161134037C000Rev01Tier1.5TRWB1.5.RWKA.dwg |

SUB FLOOR FRAMING & FOOTING LEGEND


GROUND BEARING CAPACITY
SOIL MUST HAVE A GROUND BEARING CAPACITY OF 300kPa OR GREATER. IF THE SOIL HAS A GROUND BEARING CAPACITY OF LESS THAN 300kPa, THE PILE LENGTHS AND THE NUMBER OF TIMBER BEARERS SHALL BE INCREASED TO ENSURE THE ULTIMATE BEARING CAPACITY IS NOT LESS THAN 300kPa.

| | | |
|------|---------------------------|---|
| P01 | TIMBER PILE | 125x125mm 16 TUMBER PILE IN ADOM/400, 900mm DEEP CONCRETE FOOTING |
| BRR1 | TIMBER BEARER - PROTECTED | • 140x100mm S33x12 TIMBER BEARER |
| BRR2 | TIMBER BEARER - EXPOSED | • 140x100mm S33x12 TIMBER BEARER NOTE: THE TIMBER BEARERS SHALL BE FIXED TO EACH TUBE PILE WITH 50x50mm SS WASHER. BEARER TO BE OVER 300mm OUTWARD |

TENDER / CONSENT

NEW ZEALAND TRANSPORT AGENCY TIER 1.5 - CONTROL BUILDING ARCHITECTURAL WORKS SUBFLOOR FRAMING PLAN

Rev: 1
Drawing No: 51-34037-A120
A1
Drawing Date: 05/07/19
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Client Project Title
DO NOT SCALE As indicated

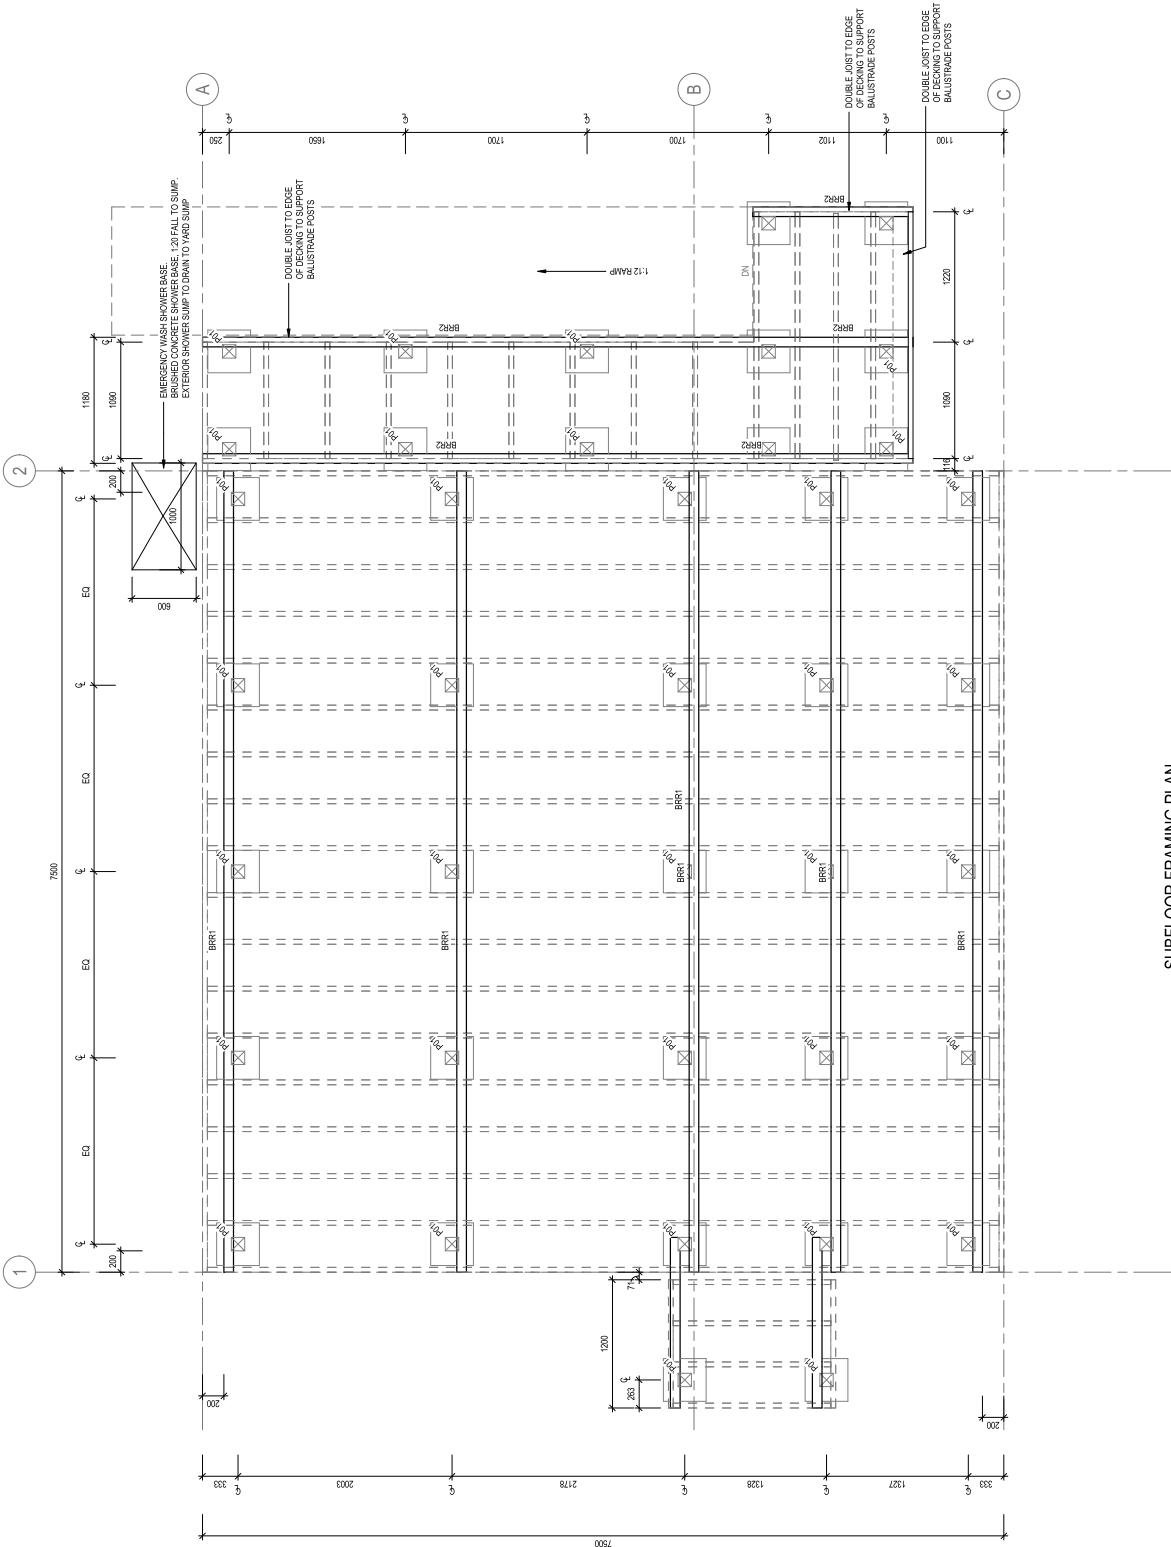


TENDER / CONSENT

NEW ZEALAND TRANSPORT AGENCY
TIER 1.5 - CONTROL BUILDING
ARCHITECTURAL WORKS
FLOOR FRAMING PLAN

Drawing No: **51-34037-A121**

Client: **New Zealand Transport Agency**
 Project: **Tier 1.5 - Control Building**
 Title: **Architectural Works**
 Scale: **1:25**

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TENDER / CONSENT

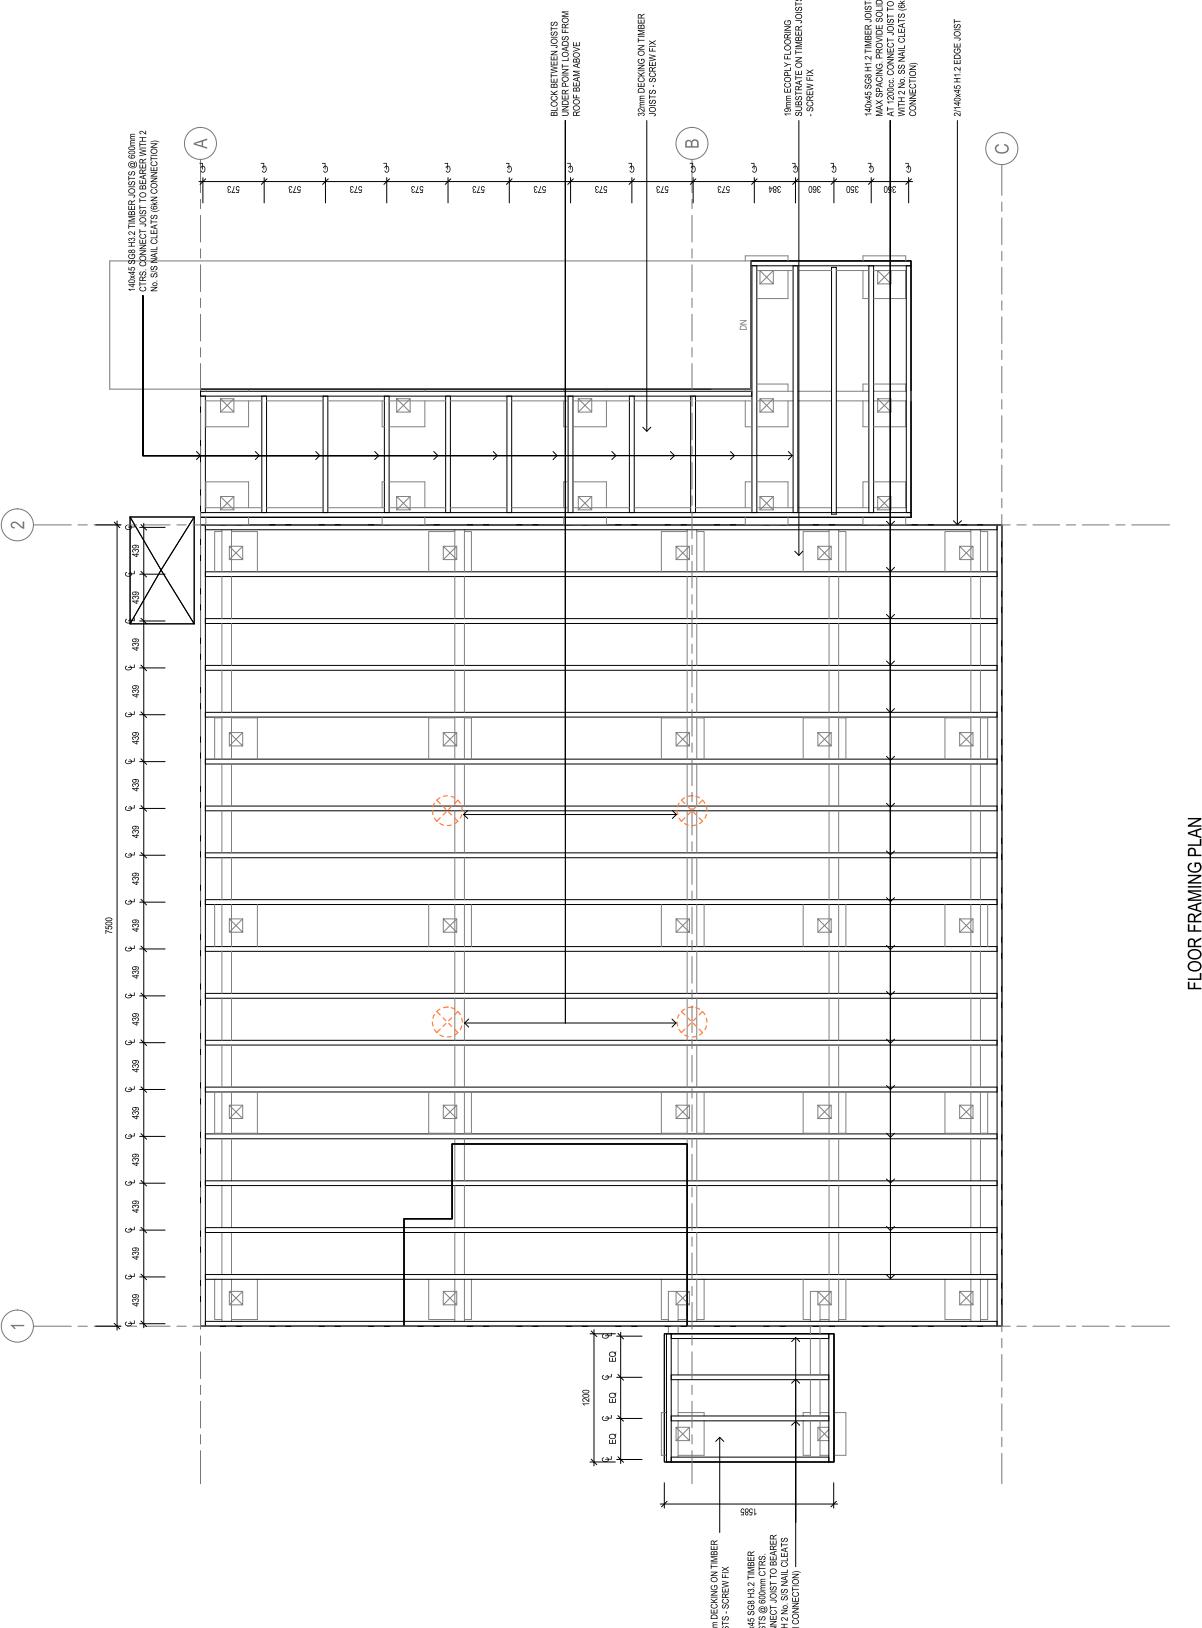**NEW ZEALAND TRANSPORT AGENCY
TIER 1.5 - CONTROL BUILDING
ARCHITECTURAL WORKS
ROOF FRAMING PLAN**


Drawing No: **51-34037-A122**
Drawing Date: **A1**
Scale: **1:25**
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ROOF FRAMING PLAN

SCALE 1:25



SCALE 1:25 AT ORIGINAL SITE

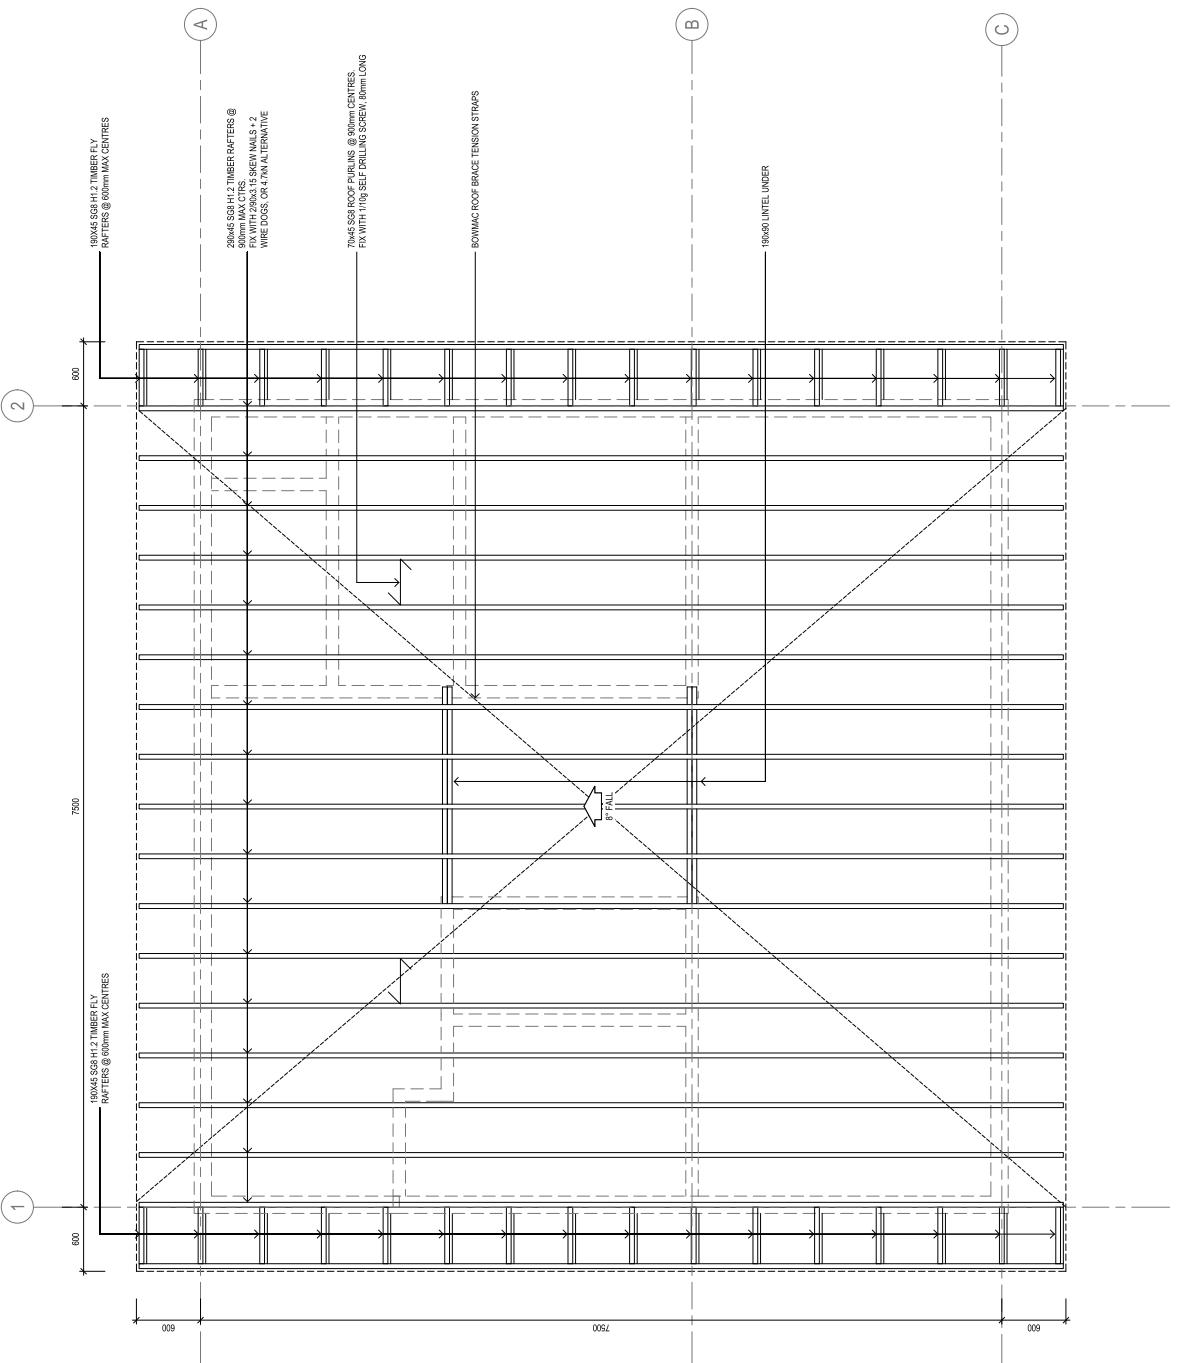

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| 1 CONSENT ISSUE | Date |
| Code File No: | 06/19/2019 10:37:39 |
| No Revision | |
| Proj Date: | |
| Proj Ref: | |

Client **Project**
Tier 1.5 - Control Building
Title **Architectural Works**
DO NOT SCALE

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WALL TYPE LEGEND

WAI | TYPES

WT01

WT03

WT04 WT05

ROOF LEGEND

GU01

| | | |
|-------------|--------------|---|
| DP01 | 100mm | GR |
| | • D/W | |
| | • FIN | |
| | | ROOF NOTES |
| | | <p>1. ALL OTHER RAIN SEALANTS TO MATCH 2. REFER TO SERVICE PERMIT 3. ALL ROOF PENE TRATES 4. CONNECT ALL NEW STORM WATER FLOWS TO DISCHARGE.</p> |


TENDER / CONSENT

NEW ZEALAND TRANSPORT AGENCY
TIER 1.5 - CONTROL BUILDING
ARCHITECTURAL WORKS

Rev: 2
EXTerior ELEVATIONS
A1 Drawing No: **51-34037-A200**
Original Size



SIDE ELEVATION 1

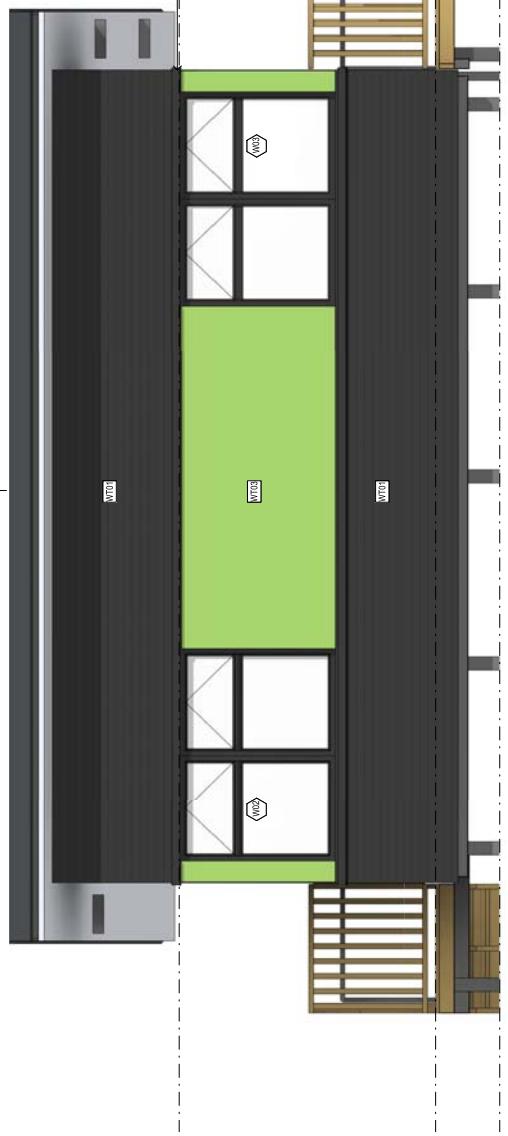

FRONT ELEVATION




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TENDER / CONSENT

NEW ZEALAND TRANSPORT AGENCY
TIER 1.5 - CONTROL BUILDING
ARCHITECTURAL WORKS
SECTIONS

Drawing No.: 51-34037-A250


Rev: 1

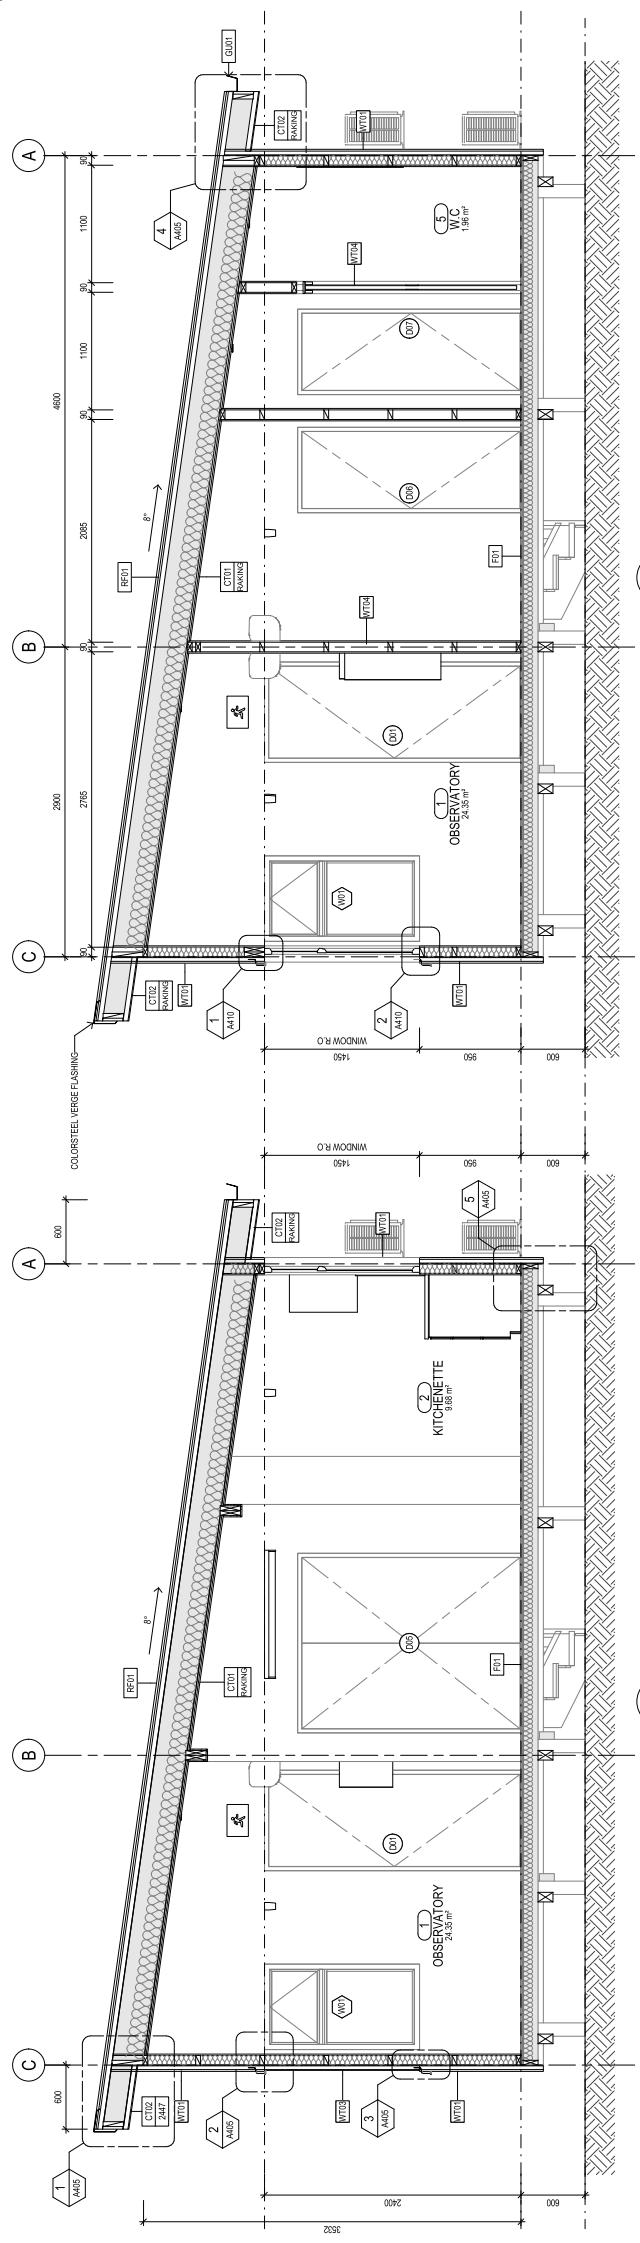

B SECTION
A100
SCALE 1:25

A SECTION
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SCALE 1:25

C SECTION
A100
SCALE 1:25

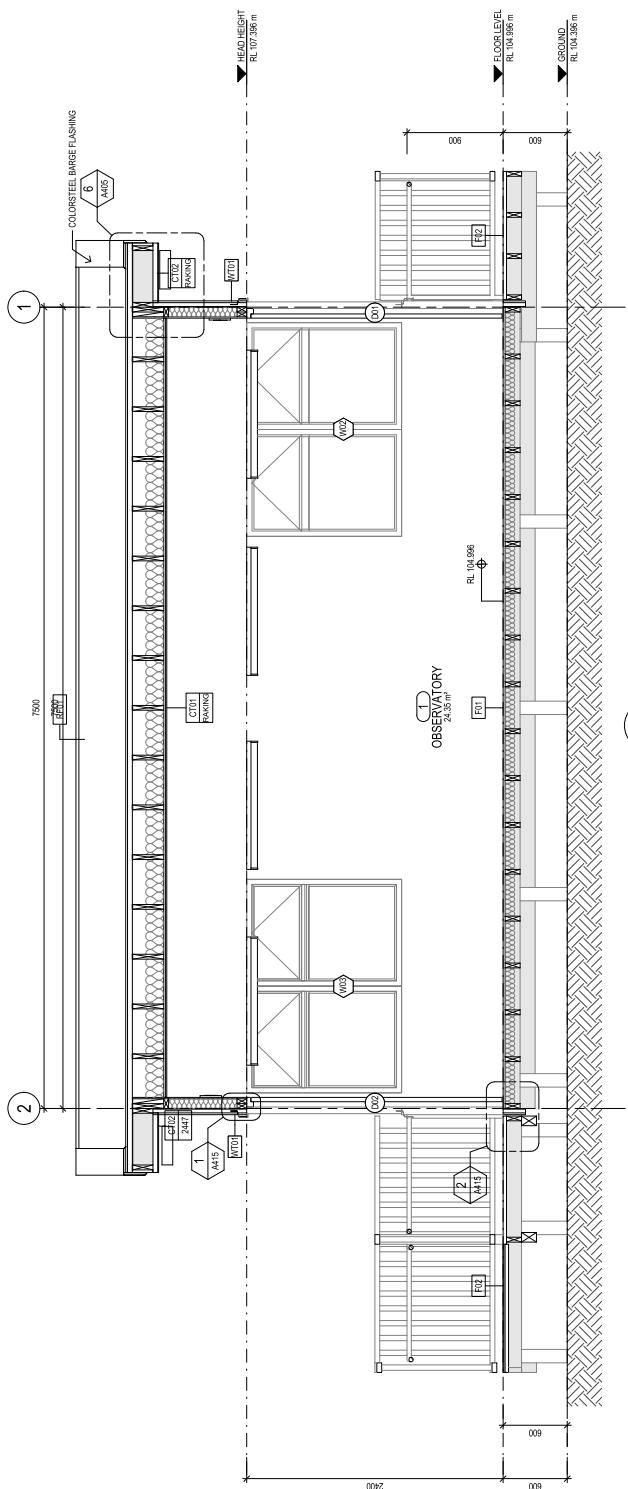

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1. CONSENT ISSUE
A FOR INFORMATION
No. Revision: Notes: *Indicates signatures on original issue or last revision of drawing
Cat File No.: 616134037-A250-DRAWER/15-TIER 1.5-FRONTIER-15-FRONTIER
Date: Date
Per Date: 15/10/2018 9:37:51
am.

Client Project Title
Design Check Approved Project Director
Approved Project Date
Scale 1:25
Comments: This drawing must be signed by Contractor unless signed as Approved

Project Manager Director Date
Drawn: M.W. 06/07/18
Title: Rev: 1
Drawing No.: 51-34037-A250
A1
Comments: This drawing must be signed by Contractor unless signed as Approved

NOTES

GENERAL: Responsibility to design and build all fixtures, fittings and equipment lies with the Client. All fixtures, fittings and equipment must be fitted in accordance with the relevant Building Regulations. Appliances must be fitted in accordance with the manufacturers recommendations with all wiring spares. All appliances shall be supplied by owner. Owner to confirm application forms prior to kitchen joinery fabrication commencing.

DRAWER RUNNERS

All drawers to have full height sides and backs with soft closing ball bearing slide track to be fitted to full travel distance.


HINGES

Generally concealed HETTH, Series or similar approved 30 mm thick door and drawer faces. Full or half overlay on equivalent cabinet doors behind. Site measure prior to manufacture of joining carcasses with the slot of their arm recessed splices to be brought to designer's attention. Units and tops are to be a nest fit between walls. Allow to template bench top to ensure an accurate fit.

CARCASSES:

Carcasses are to be 18mm standard white Melamine in general. All carcasses are to be cased with 2mm PVC where not visible. Corrugated shelves are to be 18mm white Melamine with 3mm PVC all other ends where visible white Melamine.

KITCHEN JOINERY PLAN

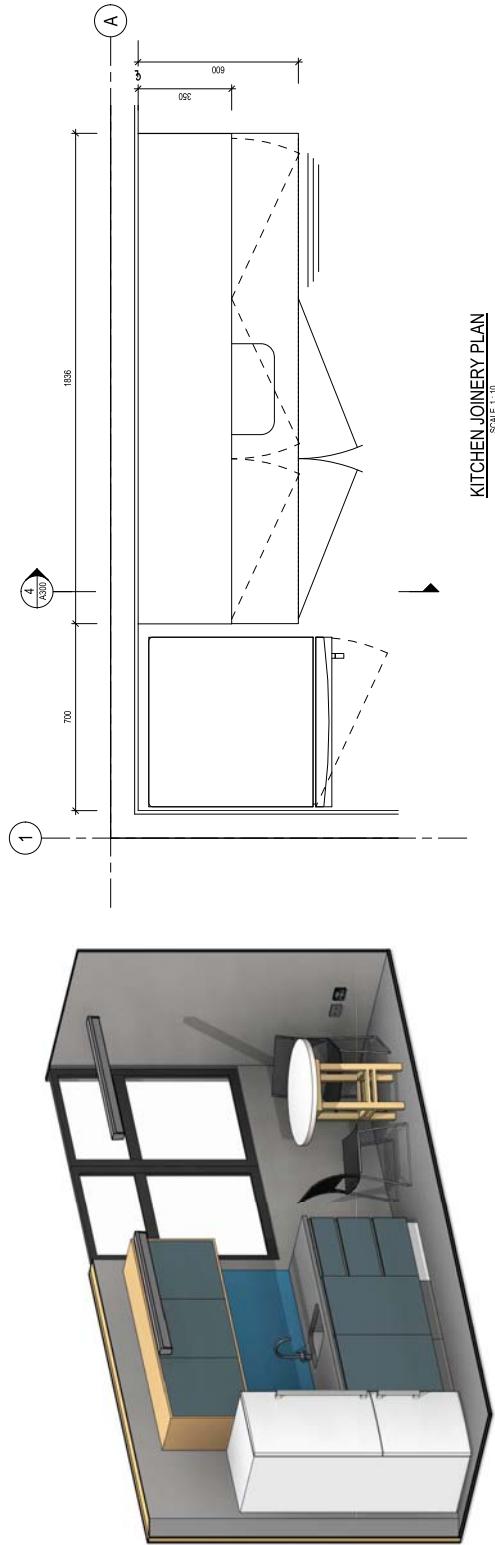KITCHEN JOINERY PLAN
SCALE 1:10

| CABINETRY FINISHES | |
|--------------------|--|
| [L1] | JONERY FINISH - TYPE 1 18mm MDF/FRS Beechwood Melamine colour CARBON EMBOSSED |
| [L2] | JONERY FINISH - TYPE 2 18mm MDF (M) Beechwood Melamine - colour RANFLY DAK WILDERNESS |
| [H1] | KORPATE - TYPE 1 Brushed stainless steel sheet mounted on 8mm MDF/FR |
| [H2] | KITCHEN BECHTOP - TYPE 1 Brushed Stainless steel bechtop on 35mm Neat Pine wood substrate |
| [H3] | BURN & FERAIL BF230815 Single Bowl Sink (Bowl size 380x400x20) allow 10mm |
| [H4] | HANDLES - BASE CABINETS & DRAWERS Marinco Mexico 250x250, 264mm, 8.5mm Black |
| [H5] | HANDLES - OVER HEAD CABINETS Marinco Mexico 400x400, 264mm, 8.5mm Black |
| [S1] | SPLASHBACK 10mm Empress glass splashback |
| [S2] | Cabinet reverse baffle |
| [S3] | MIXER TAP Monica Minimist goos neck sink mixer tap |

KITCHEN JOINERY - SECTION
SCALE 1:10

| KITCHEN JOINERY - SECTION | |
|---------------------------|---------------------------|
| [L1] | HEAD HEIGHT RL 07365 m |
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TENDER / CONSENT

NEW ZEALAND TRANSPORT AGENCY

TIER 1.5 - CONTROL BUILDING

WC ELEVATIONS

Drawing No: 51-34037-A301


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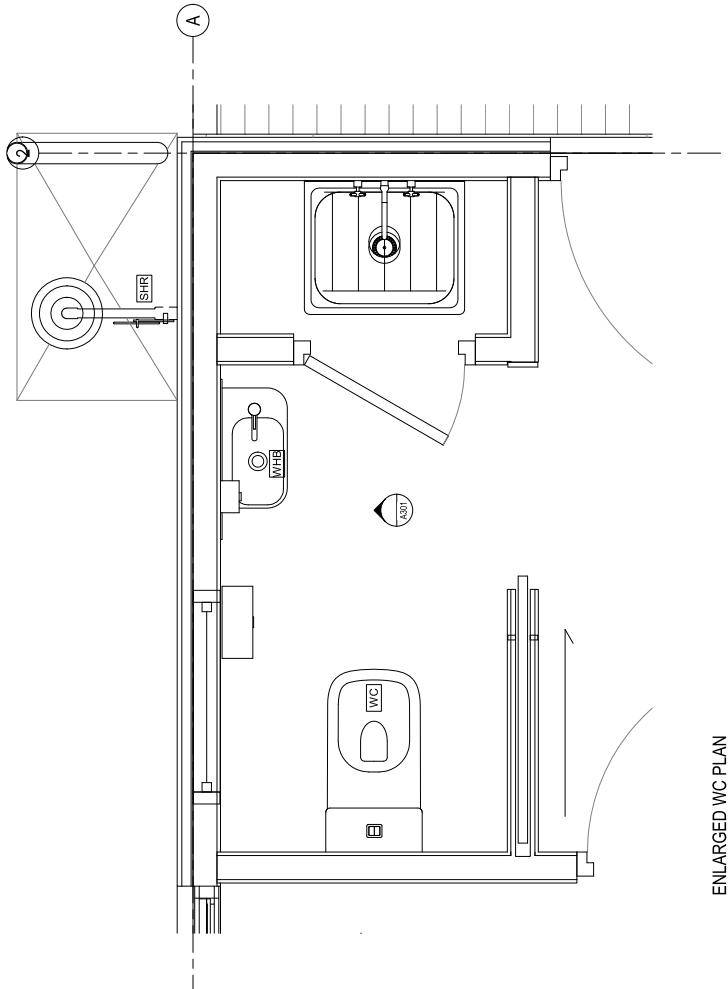
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signed as Approved



| BATHROOM ACCESSORIES | |
|----------------------|--|
| MIR | MIRROR: 1000mmH x 600mmW FRAMELESS MIRROR - CLUE FIRED TO WALL SURFACE |
| TPH | TOILET ROLL HOLDER: SINGLE JUMBO DISPENSER RESERVE: EVACUATOR/SPLIT |
| SOA | SOAP DISPENSER: ASI SURFACE MOUNTED VERTICAL |
| PTD | PAPER TOWEL DISPENSER: ASI SURFACE MOUNTED PAPER TOWEL DISPENSER: |

| BATHROOM FIXTURES | |
|-------------------|---|
| WC | WC PAN: CAROMA CURE WALL FACED TOILET SUITE WITH SOFT CLOSE SEAT PRODUCT CODE: 8281SW |
| WHB | WHB: BASIN: CAROMA LUNA HAND WASH BASIN BLACK BOTTLE TRAP |
| BMT | BATH MIXER: CAROMA LUNA BATH MIXER |
| CSS | CLEANERS SINK: FRANKE SS CLEANERS SINK WITH SPASHBACK AND BASKET: 1000MM X 500MM X 100MM DEEP FOR CLEANERS SINK, MODEL: FBN 12 SF |
| SIR | EXTERIOR SHOWER: PEKMAN LIFE SAVER WALL MOUNTED EXTERIOR EMERGENCY SHOWER HEAD WITH PULL DOWN ARM |


NZ TRANSPORT
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1 CONSENT ISSUE
No. Revision: None * indicates signatures on original issue of drawing or last revision of drawing
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Notes: * indicates signatures on original issue of drawing or last revision of drawing
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06/07/18

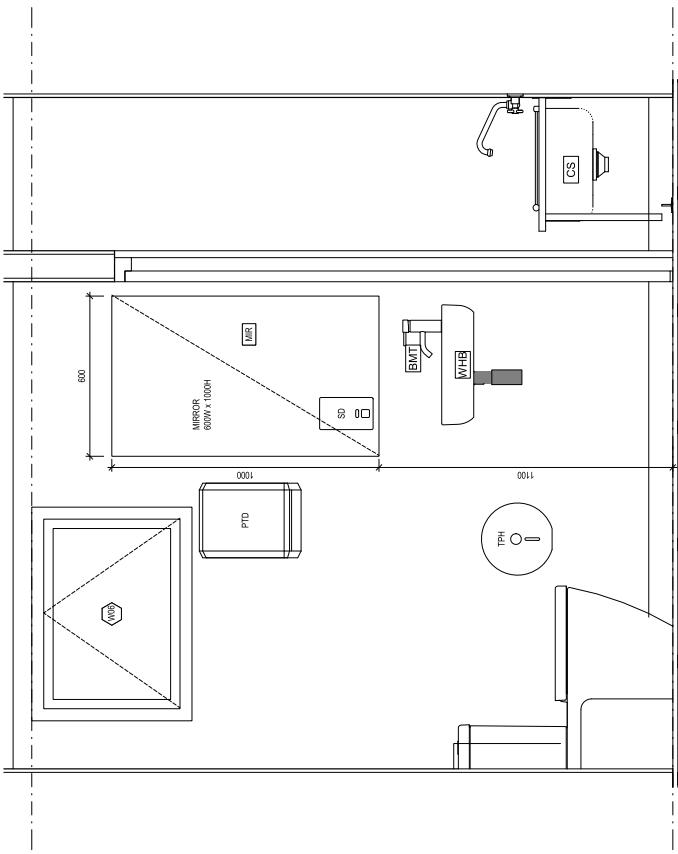Project Director Date

Manager Director Date

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NEW ZEALAND TRANSPORT AGENCY
TIER 1.5 - CONTROL BUILDING
ARCHITECTURAL WORKS
SECTION DETAILS

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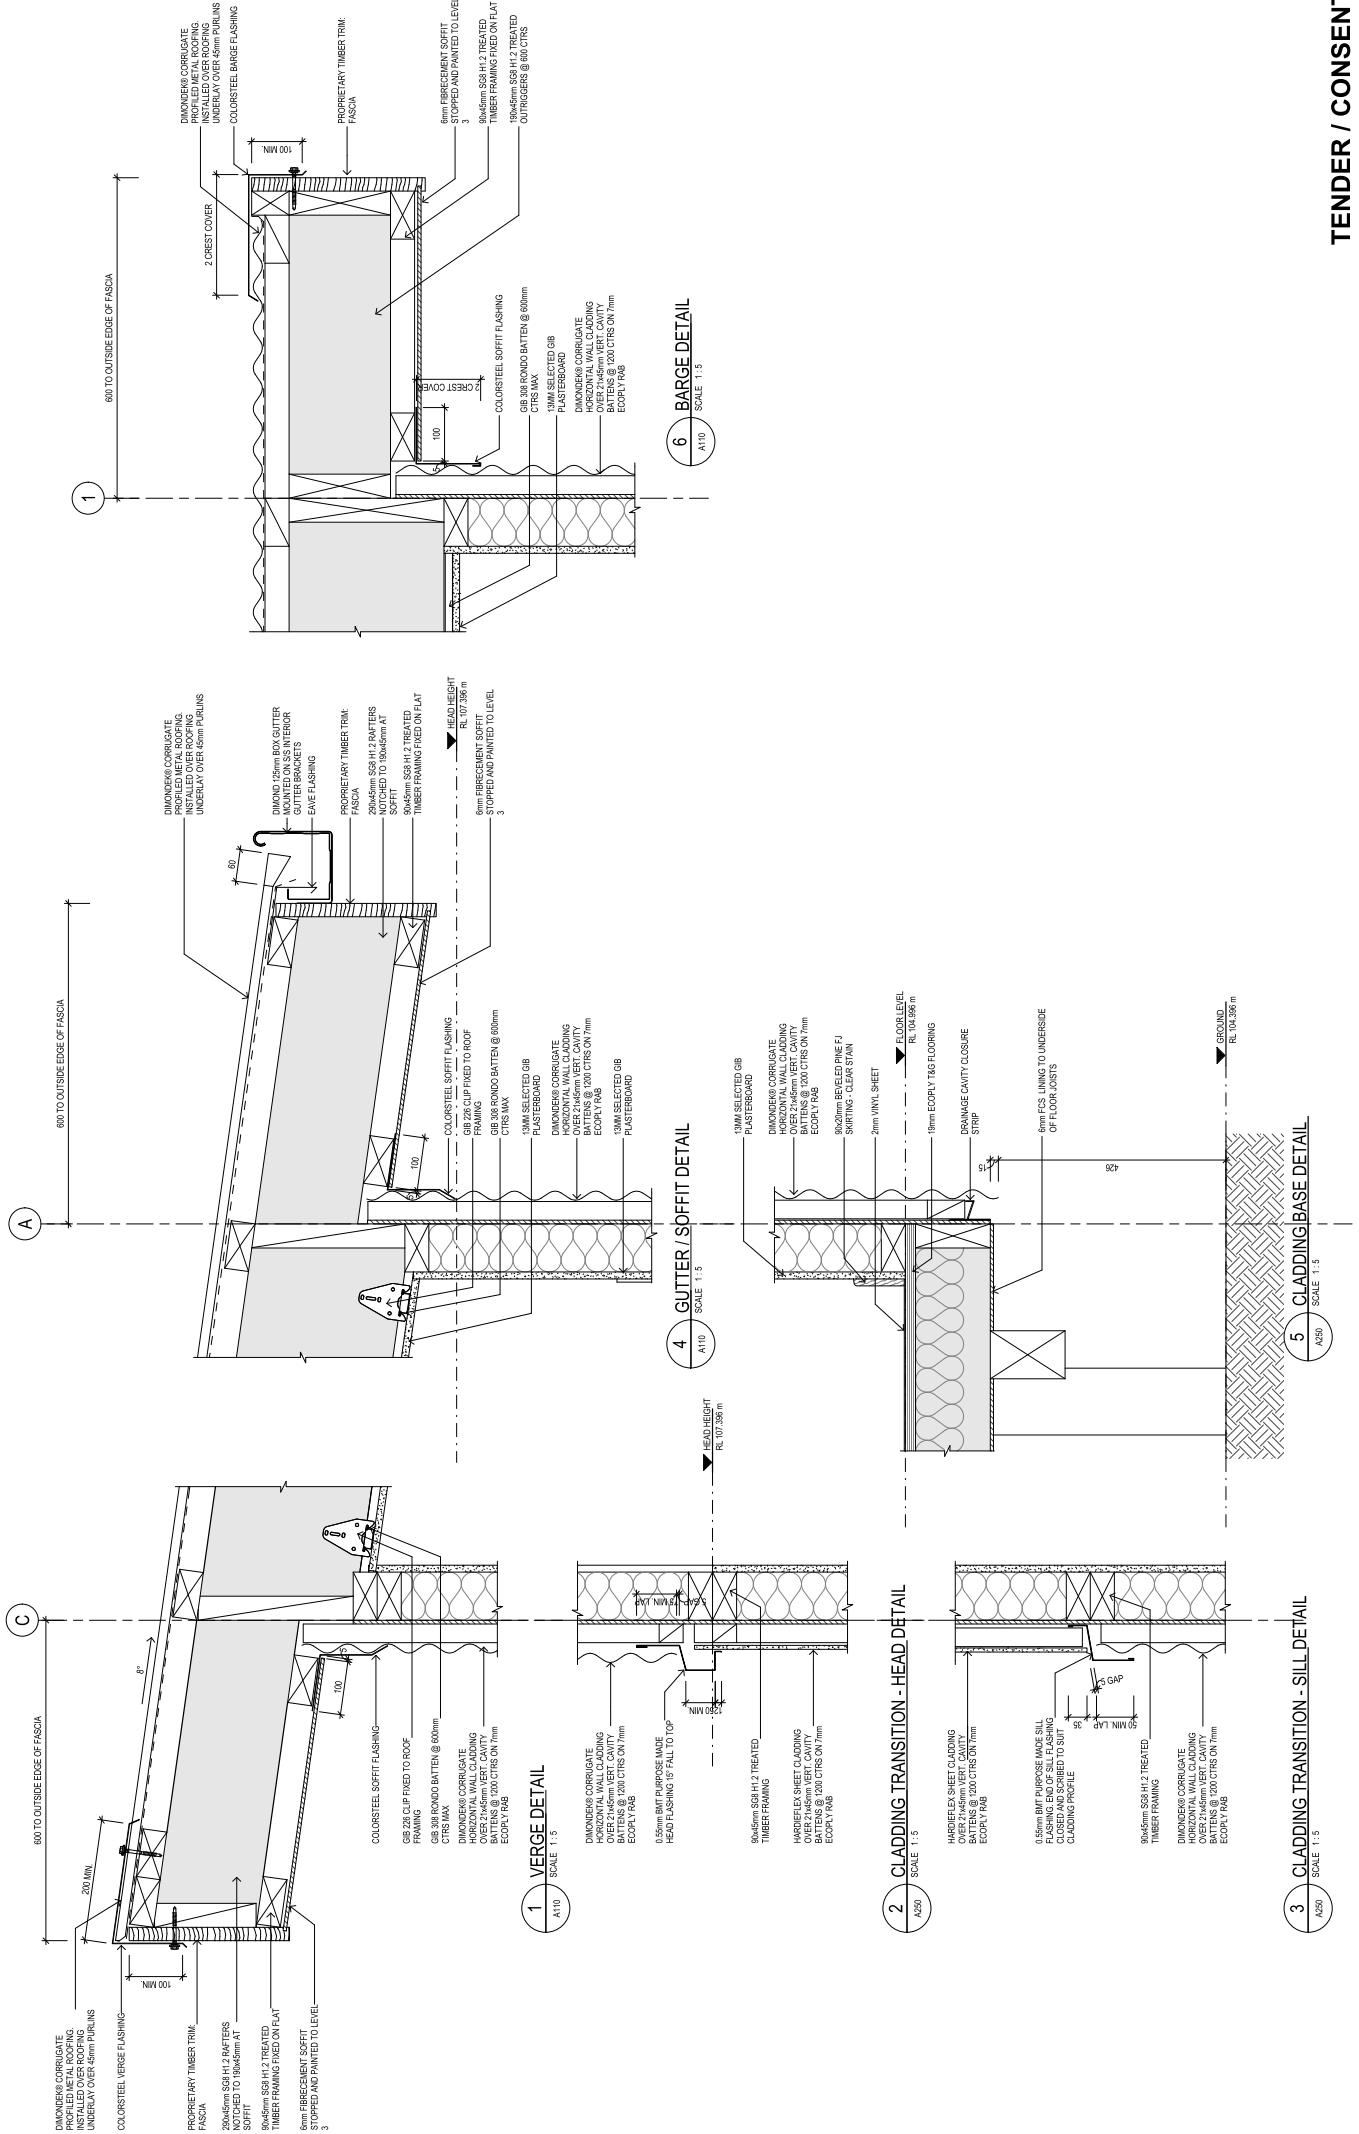
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Cad File No.: 616134037-A405-A1

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SILL FLASHING - TRANSITION

SCALE 1:2

FCS SIL FLASHING TO LAP UNDER
WINDOW SILL FLASHING JOIN TO ALIGN
WITH WINDOW FRAME EDGE

WINDOW SILL FLASHING

LINE OF WINDOW FRAME EDGE TO ALIGN
WITH HEAD FLASHING JOIN

HEAD FLASHING - TRANSITION

SCALE 1:2

5 Detail 10

SCALE 1:2

WOODHEAD
creativespaces



Detail 10

SCALE 1:2

A101

ORIGINAL SITE

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SCALE 1:2

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NEW ZEALAND TRANSPORT AGENCY
TIER 1.5 - CONTROL BUILDING
ARCHITECTURAL WORKS
DOOR DETAILS


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Rev: 1

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GHD Group of Companies
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Client: D. ANGUS
 Project: TIER 1.5 - CONTROL BUILDING
 Title: DOOR DETAILS
 Date: A1
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06/07/18
 Job Manager: Director: Date:
 Ref No.: 616134037-A415
 Job No.: 51-34037-A415
 Project: TIER 1.5 - CONTROL BUILDING

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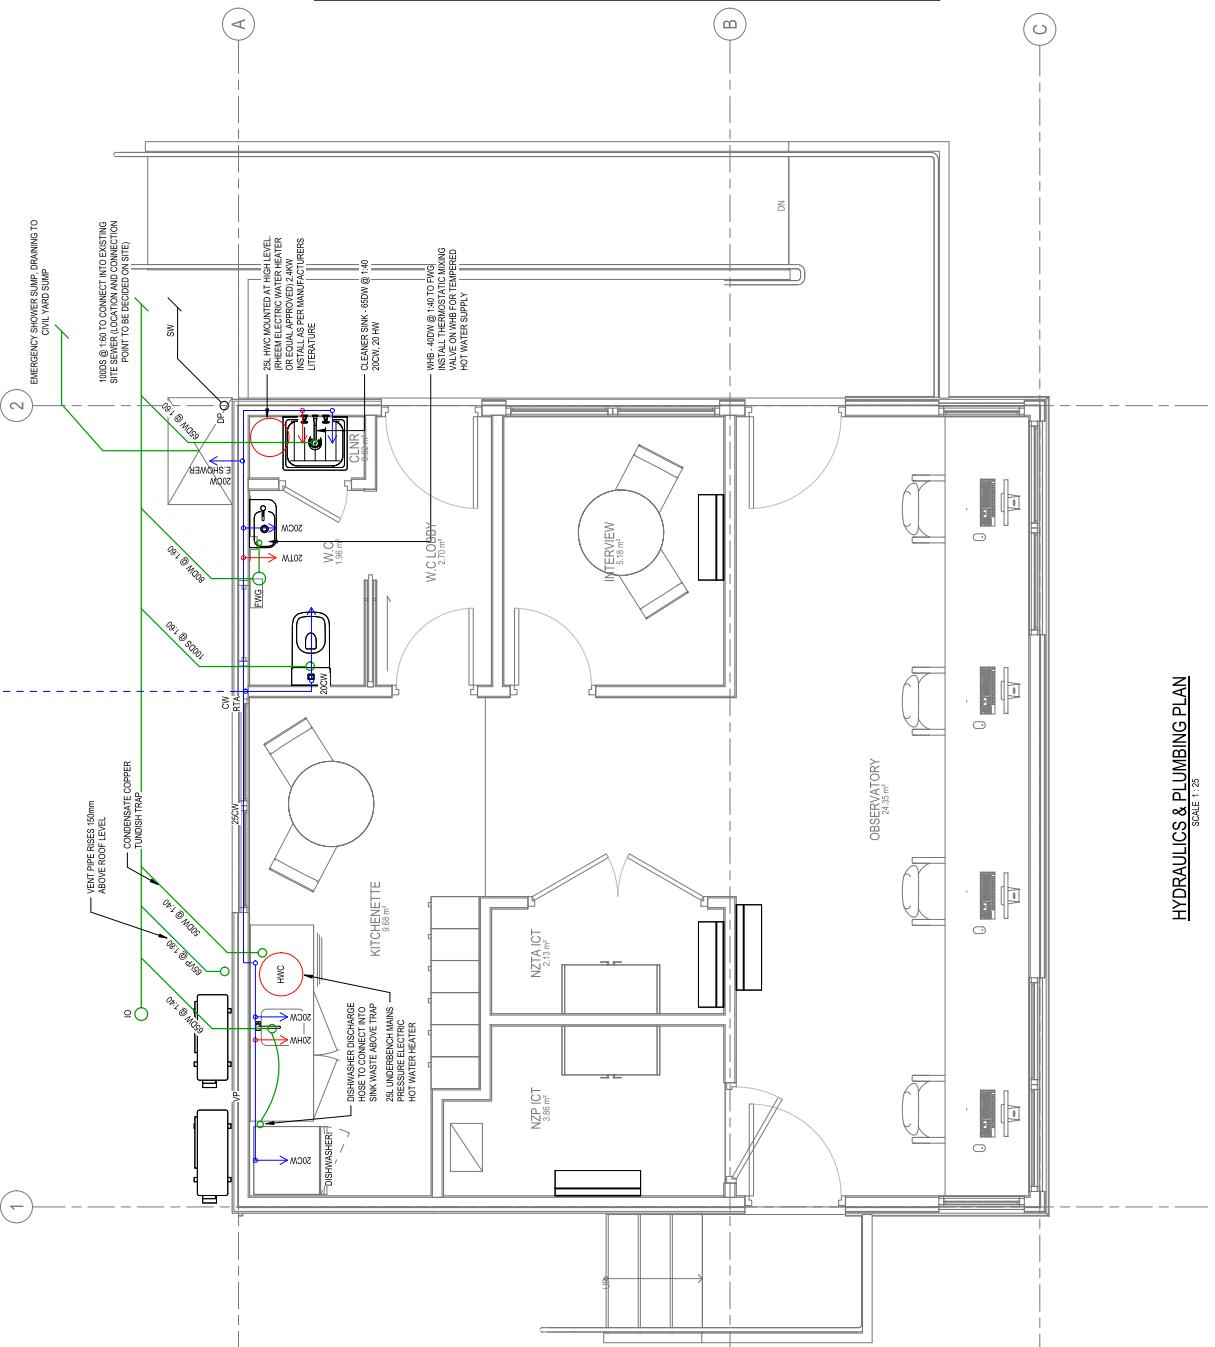
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HYDRAULICS & PLUMBING PLAN

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Project Title

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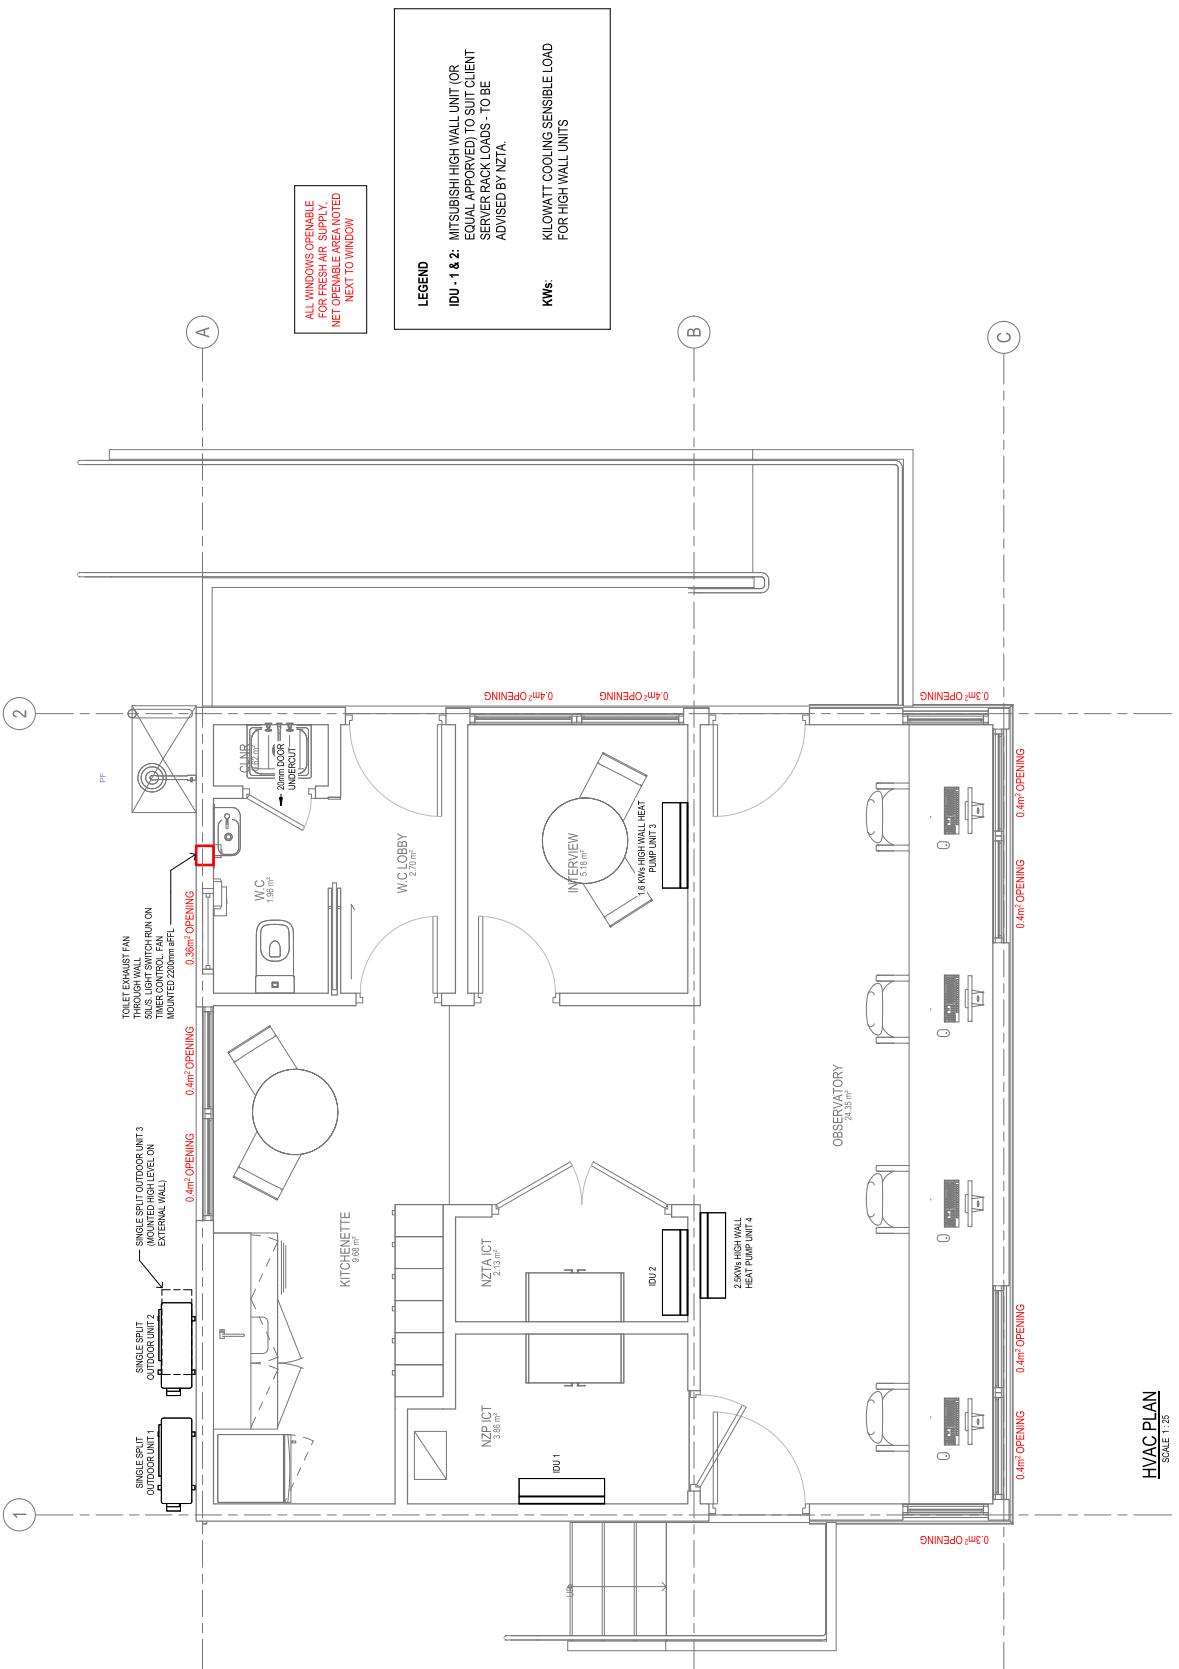
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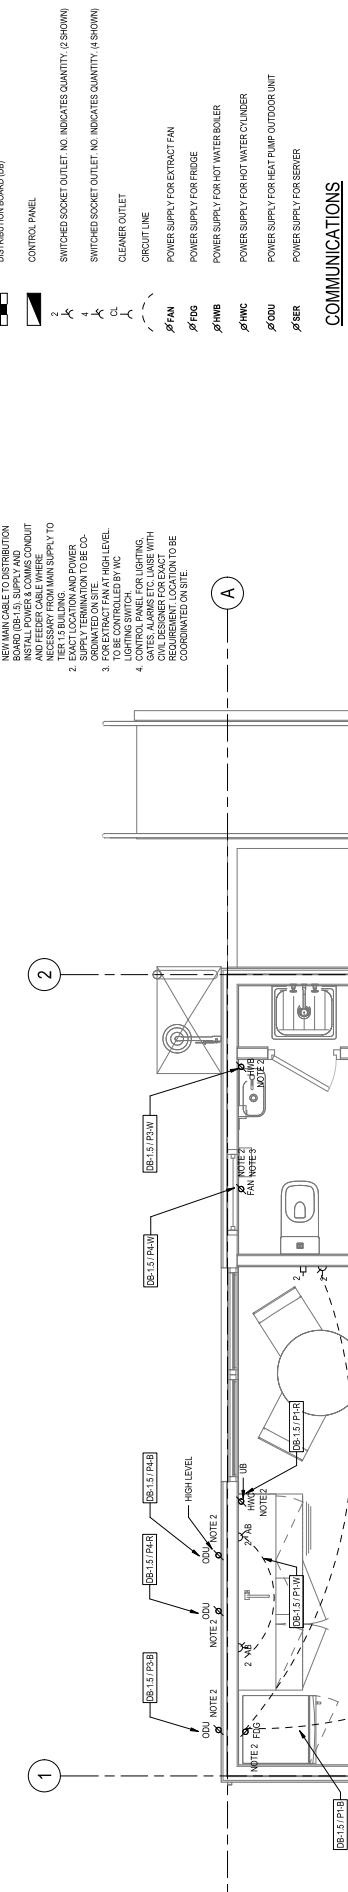
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POWER

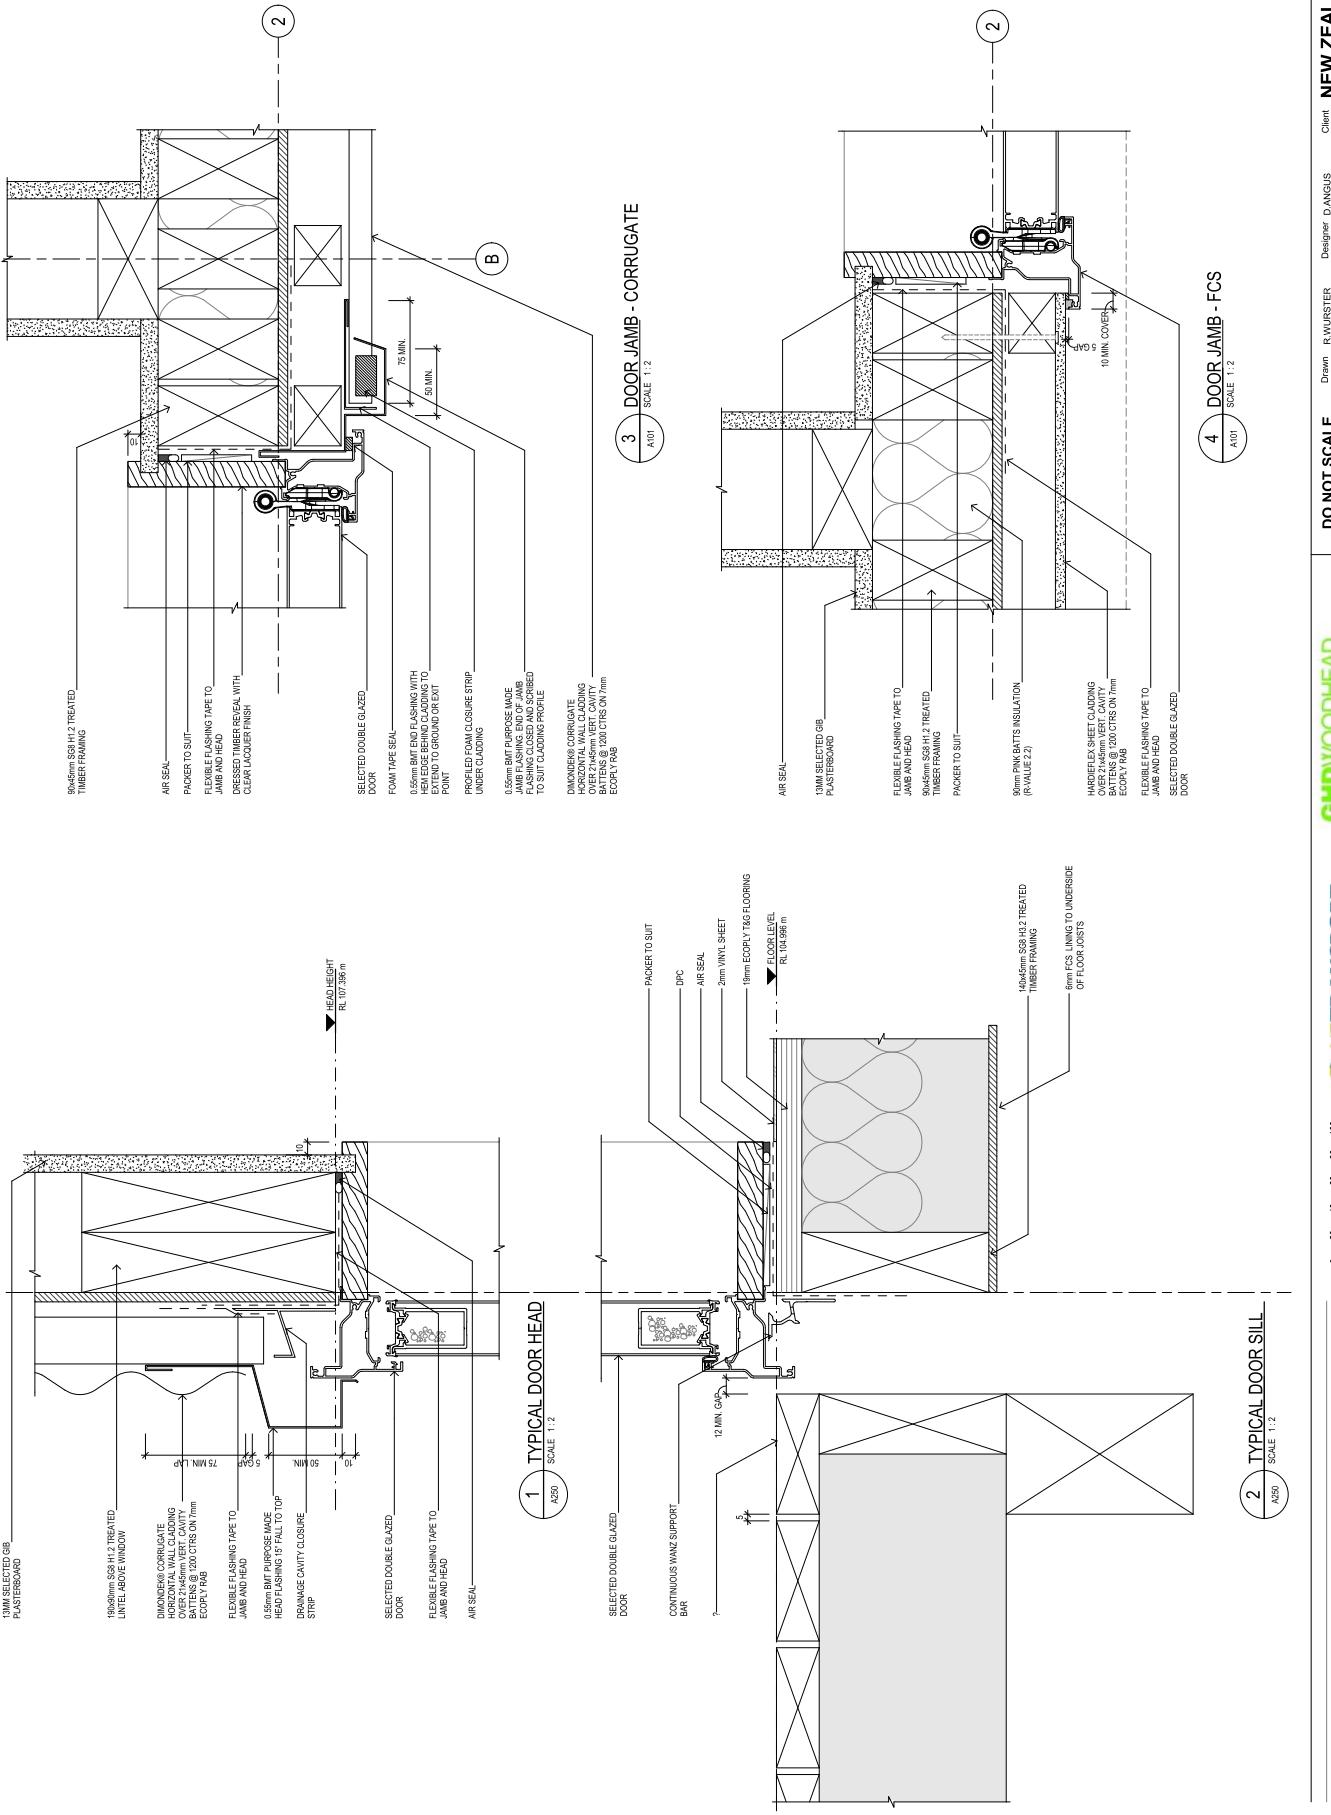

COMMUNICATIONS

COMMUNICATIONS OUTLET FOR DATA PROVIDE SINGLE MOUNTING PLATE WITH NUMBER OF OUTLETS AS INDICATED 2 SHOWN

COMMUNICATION SERVICES SHOWN FOR INFORMATION & COORDINATION ONLY. SUPPLY AND INSTALLATION OF SERVICES BY OTHERS.

ABBREVIATIONS

| | |
|-----|------------------------|
| AB | ABOVE BENCH |
| AFL | ABOVE FLOOR LEVEL |
| CAV | CLOSED ACCESS SOCKET |
| FOG | FRIDGE |
| HWB | HOT WATER BOILER |
| HNC | HEAT NITRACE |
| OU | OUTDOOR UNIT |
| PHU | HEAT PUMP OUTDOOR UNIT |
| UB | UNDER BENCH |

GENERAL NOTES

1. ALL ELECTRICAL INSTALLATION SHALL COMPLY WITH THE NZS 3025:2013 AND IEC 60364-5-50:2010. CIRCUITS OF ALL SERVICES AND DOOR SWINGS OR CONFINED WITH THE ARCHITECTED ROOM TO LIGHT SWITCH AND WIRING INSTALLATION.
2. CIRCUITS ARE TO BE PROVIDED AT 120V AC, 50Hz, 16A, 3-core Cables.
3. UNLESS OTHERWISE STATED, ALL LIGHT SWINGS ARE TO BE PROVIDED AT 120V AC, 50Hz, 16A, 3-core AFL AND POWER OUTLETS AT 230V AC, 50Hz, 16A, 3-core AFL.
4. RUN AN UNSHIELDED ACTIVE BUS BAR WHICH EMERGENCY LIGHT FITTINGS AND PROVIDE ENERGISED CIRCUITS.
5. ALL CIRCUITS SHALL BE PROTECTED BY PLASTIC CRIMP WIRES.
6. LIAISE WITH ALL TRADES.
7. WHEN REQUIRED FOR SUPPORT AND FOR SIGHTING, USE INSULATED SPANNERS, SCREWDRIVERS, SCREWDRIVER SETS, SCREWDRIVER BRACKETS AND KNIVES BETWEEN PUPILS.
8. CABLES SHALL BE IN THE CLOUTS PROVIDED.
9. ALL DISTRIBUTION BOXES SHALL BE PROVIDED WITH A CIRCUIT BREAKER.
10. ALL CIRCUITS LABELED AS SPARE ON THE SNAKE HIPS. THE SNAKE HIPS SHALL BE PROVIDED BY THE CONTRACTOR.
11. ALL SURFACE CONDUITS SHALL BE GRAY.
12. ALL LUMINAIRES SHALL BE SECURELY ATTACHED TO THE SURFACE CONDUITS.
13. THIS DOCUMENT IS FOR INFORMATION PURPOSES ONLY. IT IS THE CONTRACTOR'S RESPONSIBILITY TO COORDINATE WITH ALL RELEVANT ARCHITECTURAL DRAWINGS, DETAILS, ELEVATIONS, JOINERY DETAILS AND WITH OTHER CONTRACTORS.
14. BEND, GENTLY, WHEN FITTING AND CUTTING CABLES. SMALL CABLES SHOULD BE SUPPLIED BY LOCAL LIGHTING CIRCUITS.
15. LIAISE WITH MECHANICAL TRADE FOR EXACT LOCATION OF MECHANICAL EQUIPMENT AND FINAL TERMINATION OF CABLES.

TENDER / CONSENT

NEW ZEALAND TRANSPORT AGENCY
TIER 1.5 - CONTROL BUILDING
POWER, & COMMS LAYOUT

Rev: 1
Drawing No: 51-34037-A900
Drawing Date: 15/10/2018 10:38:04
Client Name: GHD Group Ltd
Project Name: GHD Project
Title: GHD Project

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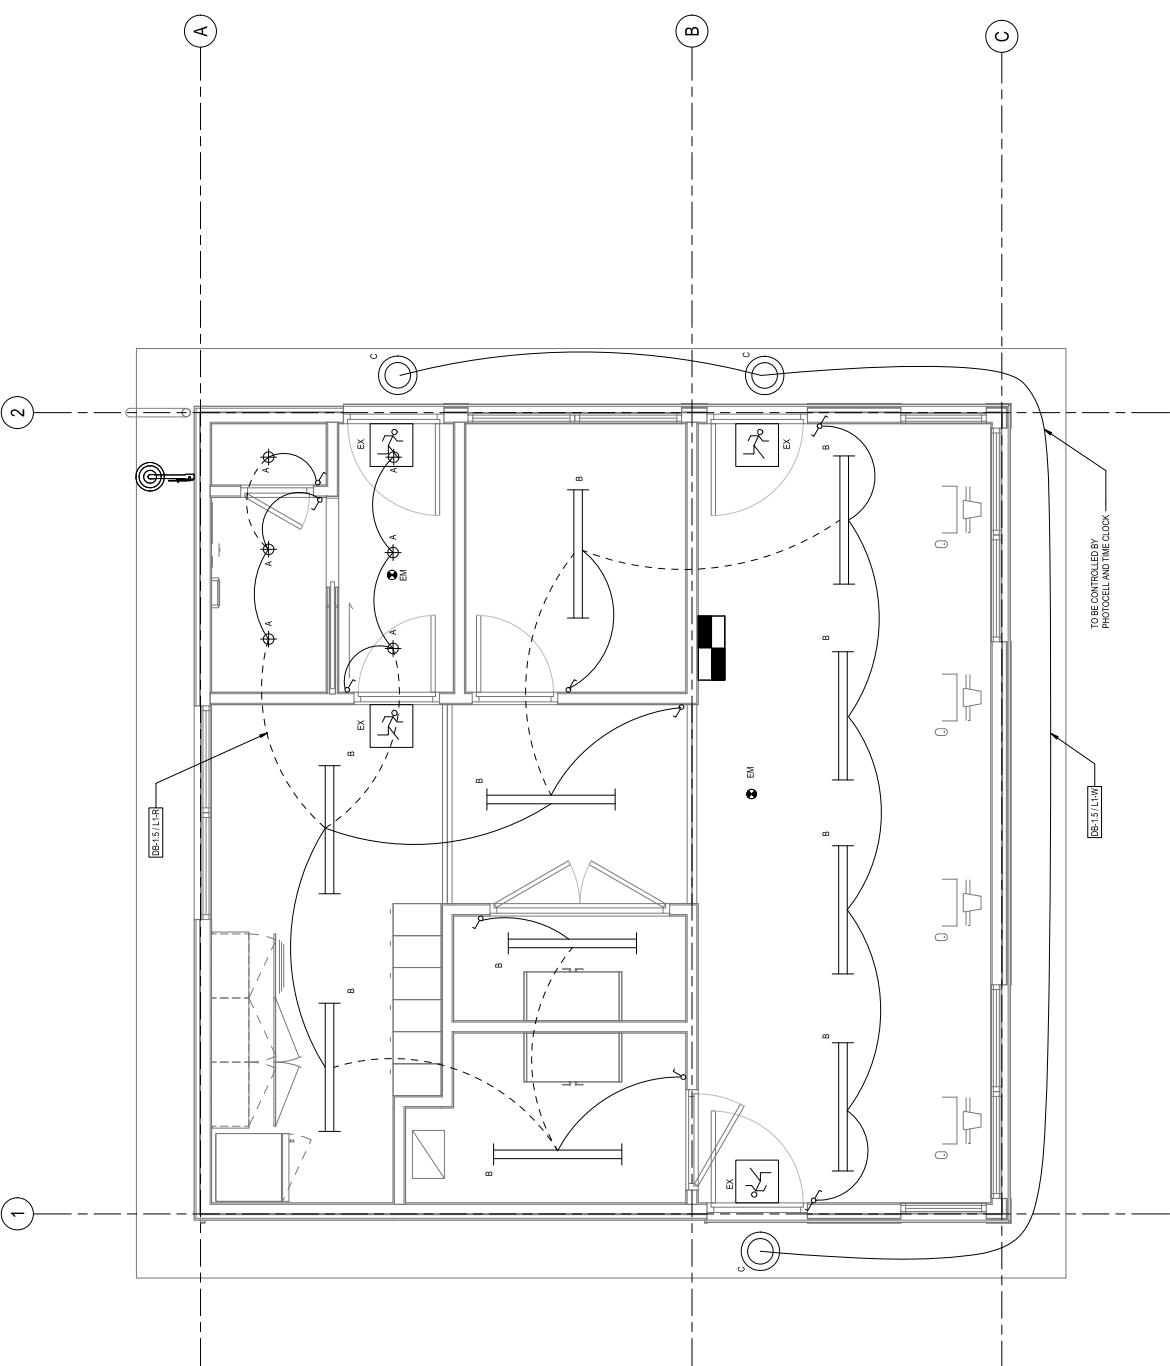
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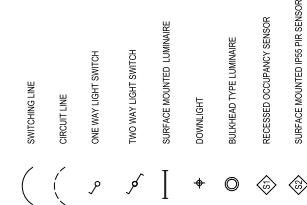
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LIGHTING



EMERGENCY LIGHTING



LUMINAIRE SCHEDULE

| LABEL | IMAGE | DESCRIPTION |
|-------|-------|---|
| A | | VERSALUX COMO MINI 1W LED AND 770lm OUTPUT IP44 RATED, FACE FLUSH CLEAR REFLECTOR, CW/NON DRIVER, 4000K COLOUR TEMPERATURE. LUMINAIRE TO BE RECESSED INTO CEILING. |
| B | | VERSALUX MINI UNDER EXTRUDED ALUMINIUM AWL LED WITH 770lm OUTPUT IP44 RATED, CW/NON DRIVER, 4000K COLOUR TEMPERATURE. LUMINAIRE TO BE SURFACE MOUNTED TO UNDER SIDE OF SOFFIT LUMINAIRE TO BE SURFACE MOUNTED TO SURFACE. A 240mm DIFFUSER IS PROVIDED. |
| D | | LEGRAND BULKAHEAD R 280 PLAIN LED LUMINAIRE WITH EMERGENCY LIGHTING FUNCTION. 1W LED WITH 270lm OUTPUT IP44 RATED CW BATTERY PACK, WITH MINIMUM 90MINUTES DISCHARGE TIME. COLOUR 4000K COOL WHITE. LUMINAIRE TO BE SURFACE MOUNTED TO WALL. |
| EM | | LEGRAND BULKAHEAD CORDLESS OR BATTERYPowered EMERGENCY LUMINAIRE 185204LL, CW/19W LED LUMINAIRE TO BE SURFACE MOUNTED TO WALL. |
| EX | | LEGEND SATTELITE CORNER EMERGENCY LUMINAIRE MANUFACTURED BY GEMINI. 1W LED, 90MINUTE MINIMUM & 90 MINUTES DISCHARGE TIME. BATTERY BACK UP AND SURFACE MOUNTING KIT. MIN. 1M ABOVE DOOR. LUMINAIRE TO BE SURFACE MOUNTED TO WALL ABOVE DOOR. |

TENDER / CONSENT

**NEW ZEALAND TRANSPORT AGENCY
TIER 1.5 - CONTROL BUILDING**

LIGHTING LAYOUT

Rev: 1
Drawing No: 51-34037-A901
Scale: As indicated
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GHDWOODHEAD
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Lighting Layout
Scale 1:25

0 250 500 750 1000 1250mm
Scale 1:25 At Original Site

| 1 CONSENT ISSUE | Date | Drawn | Date |
|-----------------|---------------------|-------|------|
| No Revision | 06/07/19 | Drawn | Date |
| Proj Date | 15/07/2019 15:36:05 | | |
| Code File No. | G16134037-A901 | | |

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APPENDIX C