

Memorandum

То	Selwyn District Council. C/o Jane Anderson
Сору	Brendan Sterling, Lara Stace
From	Samuel Hammond
Office	Christchurch
Date	29 July 2022
File/Ref	WSP Ref: 5-C4353.09 - 09CON SDC Ref: D220001
Subject	Rakaia Weigh Right CVSC - Response to s92 RFI dated 6 July 2022

Purpose

This memorandum serves as a response to Selwyn District Council's Request for Further Information pursuant to Section 92 of the Resource Management Act 1991 (RMA) dated 6 July 2022 for the Notice of Requirement for a Minor Alternation to a Designation and Outline Plan Application prepared by WSP on behalf of the NZ Transport Agency – Waka Kotahi.

Response

Design and Appearance

- 1. Please provide a landscape plan and confirm building colours to provide mitigation around the weigh station area, and to address these visual amenity concerns.
- 2. No landscaping has been proposed for the CVSC site. Waka Kotahi have directed WSP to avoid the use of landscaping citing safety, security, and maintenance concerns.
 - The Tier 1.5 building has been designed to use Dulux 'Grey Friars' corrugated cladding, and Resene 'Green Friars' hardieflex cladding, and Colorsteel 'Grey Friars' roofing. This information is provided on Drawing 51-34037.A100 of Appendix A attached to and forming part of this response. For completeness, these drawings were attached to the initial application as Appendix B.
- 3. Please confirm the number, size and location of signs proposed for the site.

The proposal seeks to install 7 signs on the CVSC site. 1 additional sign will be located at the intersection of North Rakaia Road and State Highway 1. The locations and types of signs are shown on Appendix B attached to and forming part of this response. Appendix C shows the design and size of non-typical signs which will be installed onsite.

Lighting

Please provide a Lux assessment to confirm that the design and location of the proposed lighting will ensure that light spill onto surrounding properties and road network is minimised.



Sheet E-4011 attached as Appendix D and forming part of this response shows the 2 Lux Isoline Plot for the proposed southbound Rakaia Weigh Right CVSC. The location of proposed onsite lighting is also shown.

The proposed lighting for the site has been designed in and is in compliance with AS/NZS1158.3.1:2022 which covers lighting schemes in the generality of roads¹ and AS/NZS4282:2019 which controls the obtrusive effects of outdoor lighting².

Appendix A shows light minor levels of light spill outside of the site boundary protruding onto North Rakaia Road and State Highway 1.

Light spill onto State Highway 1 will be limited to the shoulder of the road corridor and will not extend into the traffic lanes. As such, adverse effects of the safe and efficient operation of vehicles using State Highway 1 will be less than minor.

Light spill onto North Rakaia Road is limited to the grass berm on the southern side of the road. No light spill is anticipated to occur on the carriage way of North Rakaia Road. As such, adverse effects of the safe and efficient operation of vehicles using North Rakaia Road will be negligible and less than minor.

No light spill is anticipated to occur onto private property surrounding the site.

Traffic

4. Is a left auxiliary turn lane being provided from SH1 into North Rakaia Road? If yes, can an updated intersection design be provided, and tracking updated to demonstrate the left turn movements from this land into North Rakaia Road? If not, can an assessment be undertaken to determine the requirements for a left turn auxiliary lane?

No auxiliary lane has been provided for in the design. This has been directed to WSP by Waka Kotahi safety engineers.

- 5. Within the notes section found within Appendix E Vehicle Access and Parking (sheet C-2300 D) traffic management it is stated that onsite staff need to direct the driver for 10m wide loads.
 - a. How often are loads of this or near size expected to visit the site.

It is unknown how often oversized vehicles are expected to visit the site. Typically, oversized vehicle movements are recorded and pre-planned to operate when the Sate Highway network is least busy.

b. How has conflict been managed with North Rakaia Road for heavy vehicles entering and exiting the site at the same time.

The CVSC site has been designed to facilitate the movement of simultaneous heavy vehicles entering and exiting the site. This is shown on Appendix E attached to and forming part of this response.

Oversized vehicles if and when entering and exiting the site at the same time will be directed by on-staff site operating the CVSC. The movement of these vehicles onto and off the CVSC site is shown on Appendix F attached to and forming part of this response.

c. Can tracking be provided for the left turn from North Rakaia Road onto SHI for design vehicle in sheet C-2300D?

Yes. Please see Appendix E and F attached to and forming part of this response.

https://www.standards.govt.nz/shop/asnzs-1158-3-12020/

² https://www.standards.govt.nz/shop/asnzs-42822019/

6. In the manoeuvring highlighted in the red boxes below required and what is its purpose?

Please see the revised plans attached as Appendix E and F and forming part of this response.

7. If the above manoeuvring is required (particularly within the northernmost red box), please confirm how traffic will be managed on SHI noting that the truck will block both traffic lanes and this will be included in the operational management plan?

As above. Please see the revised plans attached as Appendix E and F. Manoeuvring as seen in the northernmost red box is not required.

8. It is understood that the first 90m of North Rakaia Road will be sealed to the same standard as SH1, however can it be confirmed that this will be maintained by Waka Kotahi as per discussions with Selwyn District Council?

The first 90m of North Rakaia Road is located within the Designation TR7 area. Given the purpose of designation TR7 is to 'undertake maintenance, operation, use, and improvement to the state highway network', and as stated within an email dated 25 March 2022 and attached as Appendix G, Waka Kotahi will be responsible for its maintenance.

Proposed works in TR1

It is noted that Section 10.1.1 Designation TR1 notes that the works within designation TR1 are detailed in Appendix A. The plans provide details of the proposed works within TR7 but do not appear to detail the proposed works in TR1. Please provide further information regarding the scale and location of the proposed works within TR1.

The works stated in Section 10.1.1 Designation TR1 of the initial application are shown in the plans attached as Appendix H forming part of this response.

These works are minor in scale and are in ancillary to the CVSC works proposed to occur on Designation TR7.

I trust that this information provided satisfies all the elements of the further information request. If you have any further queries regarding this response, please contact Lara Stace, Principal Resource Management Planner at lara.stace@wsp.com as my last day with WSP is Friday, 29th of July 2022.

Kind regards

Samuel Hammond

Appendix A

NEW ZEALAND TRANSPORT AGENCY TIER 1.5 - CONTROL BUILDING

51-34037



NZTA TIER 1.5 TYPE CONTROL BUILDING.

THIS IS A STANDARDISED BUILDING TYPE THAT IS CONSTRUCTED AT SEVERAL SITES

REFER TO SPECIFIC SITE PLAN FOR LOCATION OF CONTROL BUILDING WITHIN SITE

THIS BUILDING HAS BEEN DESIGNED TO THE FOLLOWING 'WORST CASE SCENARIO' SITE

EARTHQUAKE ZONE: 3 **EXPOSURE ZONE:** ZONE D

WHERE THE PROPOSED LOCATION OF THE TIER 1.5 BUILDING TYPE EXCEEDS TO THE ABOVE SCENARIOS, THEN THE BUILDING WILL NEED TO BE DESIGNED SPECIFICALLY FOR THE SITE

DRG NO.			CURRENT
PROJECT No. SHEET		DRAWING TITLE	REVISION
1. ARCHITECTURAL			'
51-34037	A001	ARCHITECTURAL DRAWING INDEX	1
51-34037	A010	GENERAL NOTES	1
51-34037	A100	GENERAL ARRANGEMENT PLAN	1
51-34037	A101	SET OUT PLAN	2
51-34037	A102	SECURITY PLAN	1
51-34037	A105	REFLECTED CEILING PLAN	1
51-34037	A110	ROOF PLAN	1
51-34037	A120	SUBFLOOR FRAMING PLAN	1
51-34037	A121	FLOOR FRAMING PLAN	1
51-34037	A122	ROOF FRAMING PLAN	1
51-34037	A160	EXTERIOR RAMP & STAIR DETAILS	1
51-34037	A200	EXTERIOR ELEVATIONS	2
51-34037	A201	EXTERIOR ELEVATIONS	1
51-34037	A250	SECTIONS	1
51-34037	A300	KITCHEN JOINERY SETOUT	1
51-34037	A301	WC ELEVATIONS	1
51-34037	A400	PLAN DETAILS	1
51-34037	A405	SECTION DETAILS	1
51-34037	A410	WINDOW DETAILS	1
51-34037	A415	DOOR DETAILS	1
51-34037	A500	DOOR & WINDOW SCHEDULE	1
51-34037	A800	HYDRAULICS & PLUMBING PLAN	1
51-34037	A801	MECHANICAL LAYOUT PLAN	1
51-34037	A900	POWER, & COMMS LAYOUT	1
51-34037	A901	LIGHTING LAYOUT	1

TENDER / CONSENT

GHDWOODHEAD

creativespaces

Level 1, Grant Thornton House 215 Lambton Quay, Wellington New Zealand T 64 4 472 0799 F 64 4 472 0833 **E** wgtnmail@ghd.com **W** www.ghd.com

This document may only be used by GHD's client (and any other person who GHD has agreed can use this document) for the purpose for which it was prepared and must not be used by any other person or for any other purpose.

DO NOT SCALE

Scale 1:1

Client NEW ZEALAND TRANSPORT AGENCY

Project TIER 1.5 - CONTROL BUILDING **ARCHITECTURAL WORKS ARCHITECTURAL DRAWING INDEX**

1 CONSENT ISSUE

No Revision

05.07.19

GENERAL NOTES

- 1. COPYRIGHT OF THIS DRAWING IS VESTED IN THE PRINCIPAL CONSULTANT.
- 2. THE CONTRACTOR SHALL VERIFY ALL EXISTING IN-GROUND AND ABOVE-GROUND SERVICES WITHIN THE SCOPE OF WORKS BEFORE COMMENCING CONSTRUCTION/DEMOLITION. ANY DISCREPANCIES ARE TO BE REPORTED TO THE CONTRACT ADMINISTRATOR.
- 3. ALL WALLS, CEILINGS, FLOOR SURFACES AND JOINERY ITEMS TO BE FINISHED TO AVOID SHARP OR ROUGH EDGES TO THE SATISFACTION OF THE CONTRACT ADMINISTRATOR / SUPERINTENDENT'S AND OPERATOR.
- 4. ANY 3D DRAWINGS ARE INDICATIVE ONLY, AND ARE TO BE READ IN CONJUNCTION WITH OTHER
- RELEVANT DRAWINGS. 5. THIS DRAWINGS SHOULD BE READ IN CONJUNCTION WITH ALL RELEVANT CONTRACTS, SPECIFICATIONS, SCHEDULES AND DRAWINGS.
- REFER TO SCHEDULES / SPECIFICATION FOR FF&E AND FINISHES / MATERIALS CODES REFER TO MECHANICAL ENGINEER'S DRAWINGS FOR ALL MECHANICAL DETAILS
- REFER TO STRUCTURAL ENGINEER'S DRAWINGS FOR ALL STRUCTURAL DETAILS REFER TO FIRE ENGINEER'S DRAWINGS FOR ALL FIRE
- SYSTEM DETAILS REFER TO ELECTRICAL ENGINEER'S DRAWINGS FOR ALL ELECTRICAL DETAILS REFER TO CIVIL ENGINEERS DRAWINGS FOR ALL CIVIL
- DETAILS 7. DIMENSIONS: CONTRACTOR AND SUB-CONTRACTOR SHALL VERIFY ALL DIMENSIONS OF THIS DRAWING AND SITE CONDITIONS PRIOR TO ANY WORK
- COMMENCING. FIGURED DIMENSIONS TAKE PRECEDENCE OVER SCALED DIMENSIONS (UNLESS NOTED OTHERWISE). FIGURED DIMENSIONS ARE:
- TIMBER FRAMED WALL SETOUT: TO FACE OF TIMBER FRAMING
- MASONRY / CONCRETE SETOUT: FACE OF MASONRY / CONCRETE AND FACE OF OPENING.
- STEEL WORK SETOUT: CENTER LINE OF MEMBER. WINDOW SETOUT: - CENTER OF
- MULLIONS/TRANSOMS, EXCEPT WHERE THEY FORM THE PERIMETER FRAMING. DOOR SETOUT: - FACE OF LATCH FRAME SIDE; FOR
- SINGLE SWING DOORS (WL AS 1428.1) SOFFIT: FINISHED UNDERSIDE OF CEILINGS - SOFFIT
- HEIGHT IS MEASURED FROM FINISH FLOOR LEVEL. FITTINGS AND FIXTURES: - DIMENSIONS TO FIXTURES AND FITTINGS ARE SETOUT FROM "FINISH" WALL
- FACE / FINISH FLOOR LEVEL. FOR ADDITIONAL SETOUT INFORMATION WHERE NO DIMENSIONING SHOWN, REFER TO REFERENCE TAGS FOR DETAILED ARCHITECTURAL DRAWINGS.

TIMBER FRAMING

- 1. ALL TIMBER SHALL BE MSG8 RADIATA UNO.
- TIMBER TREATMENT TO COMPLY WITH NZS-3602.
- ALL BOLTS/BRACKETS WITHIN 500 METRES OF THE SEA ARE TO BE STAINLESS STEEL, ALL OTHER LOCATIONS, THEY ARE TO BE GALVANIZED. 4. ALL NUTS AND BOLT HEADS THROUGH TIMBER ARE TO HAVE GALVANIZED OR STAINLESS WASHERS. 50x50x3 mm FOR BOLTS NOT EXCEEDING 12 mm DIAMETER AND 65x65x5 mm FOR BOLTS NOT EXCEEDING 20mm DIAMETER.
- 5. BOLTS SHALL BE TO THE SIZES AND POSITIONS AS SHOWN ON THE DRAWINGS. ALLOW TO COUNTERSINK BOLT HEADS AND NUTS AS NECESSARY TO CLEAR LININGS. THE DIAMETER OF A HOLE FOR A BOLT SHALL NOT BE LESS THAN THE BOLT DIAMETER NOR EXCEED IT BY 1.5
- 6. NAILS, BRADS AND SCREWS AND BOLTS SHALL BE OF STEEL, GENERALLY IN ACCORDANCE WITH NZS 3604. MINIMUM PENETRATIONS OF NAILS,
- BRADS AND SCREWS SHALL BE 10 TIMES THE FASTENER DIAMETER INTO. 7. FRAMING. NAIL PENETRATION THROUGH PACKING WILL NOT COUNT. MINIMUM SHEET EDGE DISTANCE FOR FASTENERS SHALL BE 10 mm.
- 8. ALL FOLDED METAL ANGLES/NAIL PLATES/JOIST HANGERS AND MISCELLANEOUS TIMBER FASTENERS SHALL BE GALVANISED G.250 MILD STEEL CONFORMING TO AS 1397. GALVANISING REQUIRED 275 g/m³.
- 9. ALL TIMBER LINTELS SHALL BE AS PER NZS3604 UNO.

SAFETY IN DESIGN

- THE CONTRACTOR IS HEREBY NOTIFIED OF THEIR NEED TO UNDERSTAND ITS OBLIGATIONS OF SAFETY IN DESIGN UNDER THE HEALTH AND SAFETY AT WORK ACT 2015 WITH PARTICULAR REFERENCE TO SECTION 39 – SAFETY IN DESIGN.
- GHD HAS TAKEN ALL REASONABLE STEPS TO IDENTIFY HAZARDS ASSOCIATED WITH DESIGN VIA AN INTERNATIONALLY ACCREDITED SAFETY IN DESIGN REVIEW PROCESS AND HAS MADE THE RESULTING REGISTER AVAILABLE TO THE CLIENT AND CONTRACTOR FOR THEIR REFERENCE AND ACTION DURING THE CONSTRUCTION OF THIS
- IN THE EVENT THAT A DESIGN RELATED HAZARD BECOMES APPARENT TO THE CLIENT AND/OR CONTRACTOR, THEY ARE REQUIRED TO IMMEDIATELY NOTIFY GHD LTD OF THESE ISSUES AT WHICH POINT GHD WILL REVIEW THE DESIGN WITH ALL APPROPRIATE STAKEHOLDERS TO IDENTIFY THE APPROPRIATE RISK MITIGATION METHODS.
- GHD'S SAFETY IN DESIGN REVIEW RELIES ON THE CONTRACTOR UNDERTAKING ALL WORKS IN ACCORDANCE WITH THE HEALTH AND SAFETY AT WORK ACT (2015), SUBSEQUENT HEALTH AND SAFETY AT WORK REGULATIONS, IN CONJUNCTION WITH IDENTIFIED CODES AND INDUSTRY STANDARDS.

ARCHITECTURAL SYMBOLS CENTRELINE OF ELEMENT TILE SETOUT POINT BUILDING/GRID SETOUT POINT LEVEL DATUM - TOP OF ELEMENT LEVEL DATUM - BOTTOM OF ELEMENT ◆ RL 12.345 PLAN SPOT RELATIVE LEVEL

FALL FALL DIRECTION SYMBOL

ACT **CEILING TAG** 2400

DOOR TAG

(G.01) **ROOM NUMBER** W1

(D23)

WALL TYPE TAG

WINDOW TAG

(W.G.01-01)

(C.1.01-01) **CURTAIN WALL TAG**

⋙ SD

CONCRETE FLOOR SLAB EDGE

CONCRETE FLOOR SLAB SETDOWN

FFL 00.000

PLAN - FINISH FLOOR LEVEL

SL 00.000 PLAN - SLAB LEVEL

BRACING LEGEND

---- BRACING ELEMENT

1-2_BL1-Hx1.9— BRACING ELEMENT LENGTH BRACING ELEMENT TYPE BRACING LINE ELEMENT BRACING LINE

---- LINTEL ABOVE WINDOW

WALL TYPE LEGEND

WALL TYPES:



- CORRUGATED HORIZONTAL CLADDING 13mm STANDARD PLASTERBOARD
- INTERIOR LINING L4 FINISH • 90mm TIMBER FRAMING - STUDS @
- 400mm CENTRES R2.8 ULTRA WALL BATTS 7mm ECOPLY RAB - SCREW FIXED
- 45x21 H3.2 TIMBER CAVITY BATTENS CORRUGATED PROFILE CLADDING
- CORRUGATED HORIZONTAL CLADDING WT02 13mm STANDARD PLASTERBOARD
 - 90mm TIMBER FRAMING STUDS @ 400mm CENTRES

INTERIOR LINING - L4 FINISH

- 2mm GAUGED STEEL SHEET INSTALLED TO INSIDE FACE OF WALL FRAMING
- R2.8 ULTRA WALL BATTS 7mm ECOPLY RAB - SCREW FIXED
- 45x21 H3.2 TIMBER CAVITY BATTENS CORRUGATED PROFILE CLADDING
- JAMES HARDIE HARDIEFLEX PANEL 13mm STANDARD PLASTERBOARD
- INTERIOR LINING L4 FINISH 90mm TIMBER FRAMING - STUDS @
- 400mm CENTRES R2.8 ULTRA WALL BATTS
- 7mm ECOPLY RAB SCREW FIXED 45x21 H3.2 TIMBER CAVITY BATTENS JAMES HARDIE HARDIEFLEX SHEET

CLADDING WT04 INTERIOR TIMBER WALL

- 90mm TIMBER FRAMING STUDS @ 600mm CENTRES
- 13mm GIB PLASTERBOARD BOTH SIDES L4 FINISH - REFER TO BRACING PLAN FOR LOCATION BRACING UNITS



- INTERIOR TIMBER WALL 90mm TIMBER FRAMING - STUDS @
- 600mm CENTRES • 2mm GAUGED STEEL SHEET INSTALLED
- TO NZP ICT ROOM FACE OF WALL
- 13mm GIB PLASTERBOARD BOTH SIDES L4 FINISH - REFER TO BRACING PLAN FOR LOCATION BRACING UNITS

INSULATION NOTES:

FIT R3.6 FIBERGLASS BATTS TO ALL CEILING SPACES -PINK BATTS R3.6 SKILLION ROOF INSULATION SHALL BE INSTALLED TO SKILLION ROOF TO ACHIEVE 25MM AIR GAP BETWEEN INSULATION AND ROOF UNDERLAY

WALL INSULATION: EXTERIOR WALLS: ARE TO BE INSULATED WITH R2.8 PINK BATTS ULTRA FIBERGLASS BATTS.

UNDERFLOOR INSULATION: MAMMOTH POLYESTER R1.9 UNDERFLOOR SECTIONS FITTED BETWEEN FLOOR JOISTS

ROOF LEGEND

DIMOND CORRUGATE

- DIMOND CORRUGATE 0.55mm ROOFING
- COLORSTEEL MAXX FINISH COLOUR

FLOOR LEGEND

TIMBER FLOOR

CRS MAX

TIMBER DECK

TIMBER FLOOR

19mm PLYWOOD

SECURITY SCREWS

INSULATION R1.9

INSULATION R1.9

19mm PLYWOOD

140x45mm FLOOR JOISTS AT 450mm CRS

ADJACENT FLOOR JOISTS AT 1800mm

FULL DEPTH BLOCKING BETWEEN

MAMMOTH MULTI UNDERFLOOR

6mm FIBRE CEMENT LINING TO

EX. 100x32mm TIMBER DECKING

140x45 H3.2 FLOOR JOISTS AT 600 CRS

2mm GAUGED STEEL PLATE FIXED WITH

140x45mm H1.2 FLOOR JOISTS AT 450mm

ADJACENT FLOOR JOISTS AT 1800mm

FULL DEPTH BLOCKING BETWEEN

MAMMOTH MULTI UNDERFLOOR

6mm FIBRE CEMENT LINING TO

PROPRIETARY JOINTERS.

UNDERSIDE OF FLOOR JOISTS -

PROPRIETARY JOINTERS.

UNDERSIDE OF FLOOR JOISTS -

FLOOR TYPES:

F01

F02

F03

- 'GREY FRIARS' ROOF UNDERLAY
- 70x45mm H3.2 TIMBER PURLINS @ 900mm CTRS FIXED ON FLAT
- 290x45mm H1.2 TIMBER RAFTERS AT 480mm CTRS NOTCHED AT SOFFIT

STEEL GUTTER - 125 BOX

- DIMOND BOX 125 GUTTER PROFILE COLORSTEEL MAXX FINISH - COLOUR 'GREY FRIARS'
- 100mmØ DOWN PIPE
- DIMOND 0.55mm STEEL

FINISH TO MATCH ROOFING

ROOF NOTES

- 1. ALL OTHER RAINWATER GOODS, FIXINGS AND
- SEALANTS TO MATCH ROOF SHEETING. REFER TO SERVICES DRAWINGS FOR ALL ROOF
- SERVICE PENETRATIONS. 8. ALL ROOF PENETRATIONS TO BE APPROPRIATELY
- FLASHED/SEALED TO RIDGE LINE, REFER TO SPECIFICATION FOR DETAILS.
- 4. CONNECT ALL NEW RAINWATER DOWNPIPES TO STORM WATER RETICULATION AND LEGAL POINT OF DISCHARGE.

CEILING LEGEND



PLASTERBOARD CEILING 13mm PLASTERBOARD, L4 FINISH.



GIB 226 CLIP FIXED TO ROOF FRAMING SOFFIT LINING

308 RONDO CEILING BATTENS ON

- 6mm THICK FIBRE CEMENT SHEET
- PROPRIETARY JOINTERS 45mm FRAMING PAINTED

CEILING NOTES

- REFER TO ELECTRICAL DRAWINGS TO COORDINATE
- LIGHTING AND FOR INSTALLATION DETAILS REFER TO SERVICES DRAWINGS FOR OTHER
- REQUIRED CEILING ACCESS POINTS PROVIDE ACCESS PANELS IN CEILING IN
- ACCORDANCE WITH BUILDING SERVICES REQUIREMENTS.
- CEILING PLANS TO BE READ IN CONJUNCTION WITH BUILDING SERVICES AND RELEVANT SHOP DRAWINGS.
- CEILING EQUIPMENT/FITTINGS TO ALIGN WHERE POSSIBLE (CENTRE LINES) AND BE SPACED EVENLY
- BETWEEN ADJACENT WALLS. PROVIDE ADDITIONAL SUPPORTS IN THE CEILING
- SUSPENSION SYSTEM WHERE CEILING MOUNTED CURTAIN TRACKS ARE HUNG.
 - CEILING MOUNTED EQUIPMENT/FITTINGS ARE TO ALIGN WHERE POSSIBLE (CENTRE LINES) AND BE SPACED EVENLY BETWEEN ADJACENT WALLS.

- **BATHROOM FIXTURES:** WC PAN: CAROMA CUBE WALL FACED TOILET SUITE WITH
- SOFT CLOSE SEAT, PRODUCT CODE: 824615W
- WHB BASIN: CAROMA LUNA HAND WALL BASIN, BLACK BOTTLE TRAP BMT BASIN MIXER: CAROMA LIANO BASIN MIXER
- **CLEANERS SINK:** FRANKE SS CLEANERS SINK WITH SPLASHBACK AND BUCKET GRID. CODE: FRCS **CLEANERS SINK TAPWARE:** ZURN SINK FAUCET FOR CLEANERS SINK, MODEL: ZURN Z-SF
- SHR EXTERIOR SHOWER: SPEAKMAN LIFESAVER WALL MOUNTED EXTERIOR EMERGENCY SHOWER HEAD WITH PULL DOWN ARM

BATHROOM ACCESSORIES

MIRROR: 1000mmH x 600mmW FRAMLESS MIRROR GLUE FIXED TO WALL SURFACE

RESERVE, LIVI-COTTONSOFT

- TOILET ROLL HOLDER: SINGLE JUMBO DISPENSER
- **SOAP DISPENSER:** ASI SURFACE MOUNTED VERTICAL SOAP DISPENSER
- PAPER TOWEL DISPENSER: AS1 SURFACE MOUNTED PAPER TOWEL DISPENSER

TENDER / CONSENT

GHDWOODHEAD creativespaces

Level 1, Grant Thornton House 215 Lambton Quay, Wellington New Zealand T 64 4 472 0799 F 64 4 472 0833 E wgtnmail@ghd.com W www.ghd.com

Conditions of Use. This document may only be used by GHD's client (and any other person who GHD has agreed can use this document) for the purpose for which it was prepared and must not be used by any other person or for any other purpose.

Scale As indicated

DO NOT SCALE

Project TIER 1.5 - CONTROL BUILDING ARCHITECTURAL WORKS **GENERAL NOTES**

Client NEW ZEALAND TRANSPORT AGENCY

Drawing No: 51-34037-A010

1 CONSENT ISSUE


Plot Date: 15/10/2019 10:37:35

No Revision

Cad File No: G:\51\34037\CADD\Revit\TIER 1.5\TIER 1.5 RAKAIA\TIER 1.5 RAKAIA.rvt

05.07.19

Drawn Date

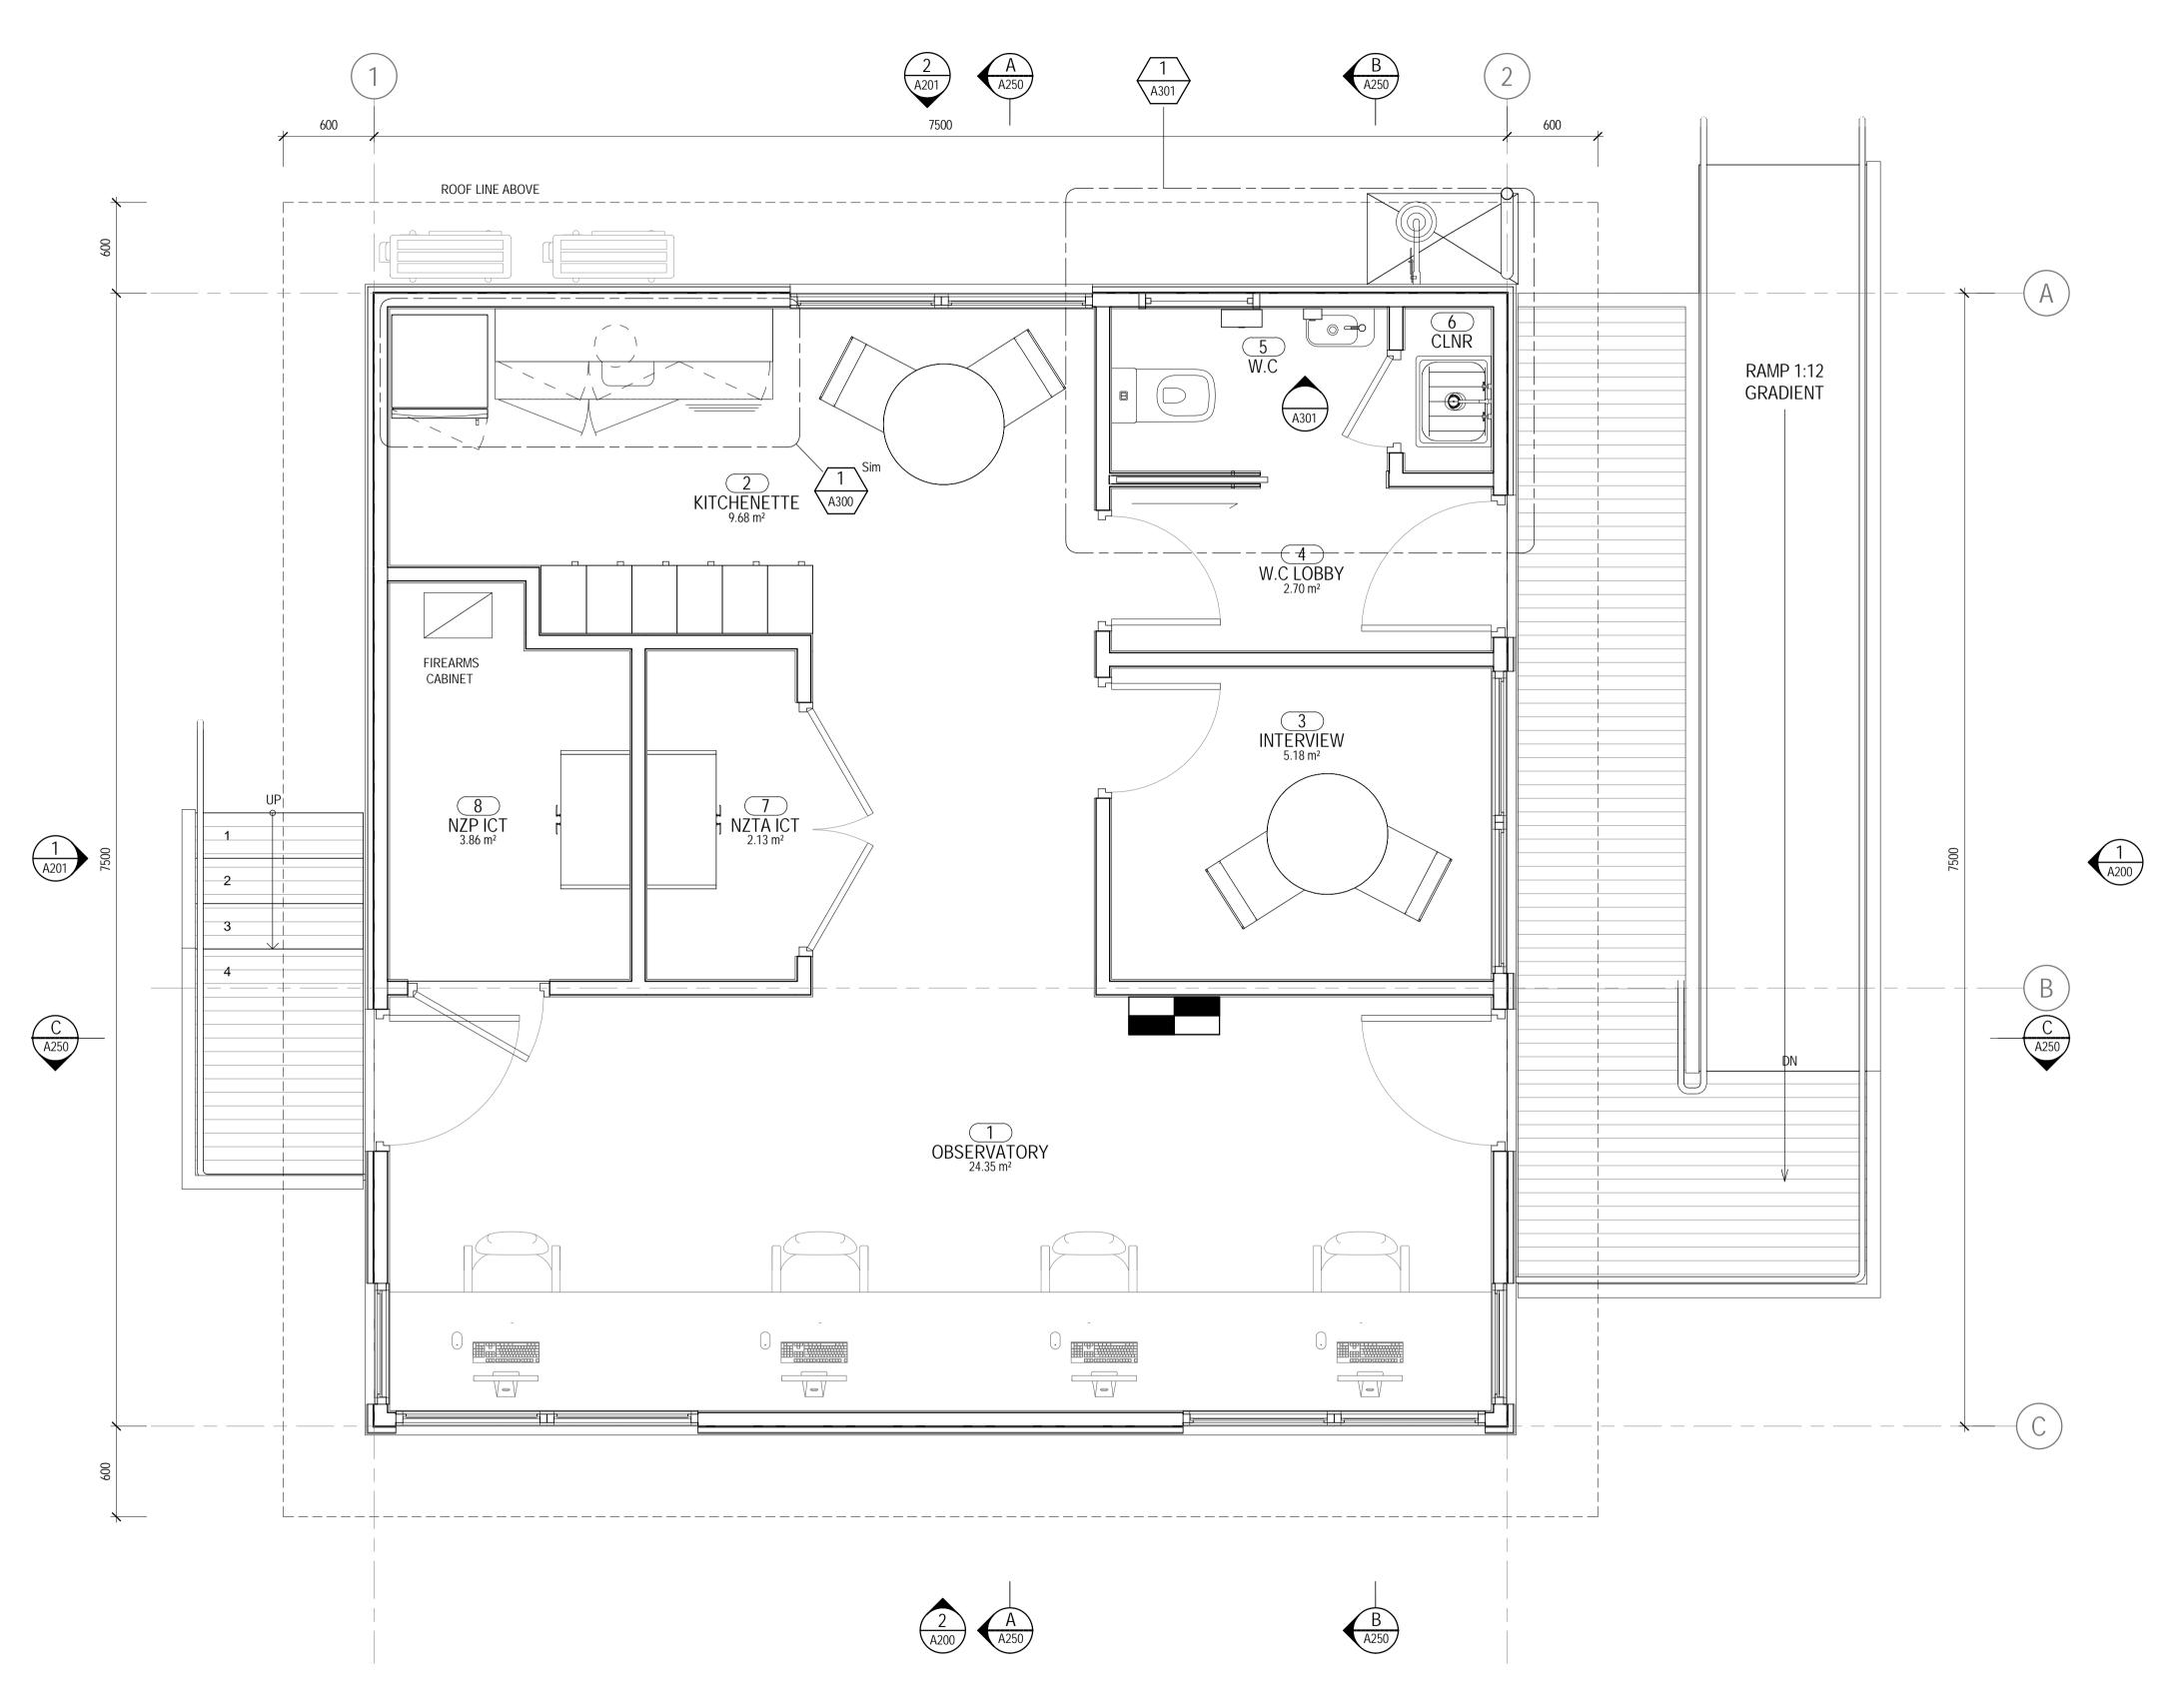

ARCHITECTURAL SYMBOLS CENTRELINE OF ELEMENT TILE SETOUT POINT BUILDING/GRID SETOUT POINT LEVEL DATUM - TOP OF ELEMENT LEVEL DATUM - BOTTOM OF ELEMENT → RL 12.345 PLAN SPOT RELATIVE LEVEL FALL DIRECTION SYMBOL ACT **CEILING TAG** 2400 DOOR TAG **ROOM NUMBER** WALL TYPE TAG (W.G.01-01) WINDOW TAG $\langle C.1.01-01 \rangle$ **CURTAIN WALL TAG** CONCRETE FLOOR SLAB SETDOWN CONCRETE FLOOR SLAB EDGE PLAN - FINISH FLOOR LEVEL SL 00.000 PLAN - SLAB LEVEL

EXTERNAL COLOUR **SELECTIONS:**

DULUX 'GREY FRIARS' CORRUGATE CLADDING:

HARDIEFLEX CLADDING: RESENE 'GREEN LEAF' COLORSTEEL 'GREY FRIARS' ROOFING: FASCIA & BARGE: 'GREY FRIARS' PAINT FINISH GUTTERS: 'GREY FRIARS' DOWNPIPES: 'GREY FRIARS' SOFFIT PAINT COLOUR: RESENE 'ALABASTER' FLASHINGS:

WINDOW & DOOR JOINERY: BLACK ANODISED 'GREY FRIARS' EXTERNAL DOOR PAINT: EXTERIOR DECKING/BALUSTRADES: RESENE WOODSMAN 'LIMED GUM'

INTERIOR PAINT COLOURS: RESENE 'ALABASTER' GENERAL WALLS: INTERIOR DOOR LEAFS: RESENE 'GREY FRIARS' INTERIOR DOOR TRIMS: RESENE 'GREY FRIARS' WINDOW TRIMS: RESENE 'ALABASTER' SKIRTING: RESENE 'ALABASTER'

FLOOR FINISHES:

FLOOR FINISHES: INSTALL FLOORING VINYL TO ALL SPACES: TARKITT IQ GRANIT

COLOUR: 461

SKIRTING TRIM: 90x10 BEVELLED PINE FJ SKIRTING PROFILE

WALL PAINT COLOUR: RESENE 'ALABASTER' CEILING PAINT COLOUR: RESENE 'ALABASTER' INTERIOR TRIM PAINT COLOUR: RESENE 'ALABASTER'

GENERAL ARRANGEMENT PLAN

250 500 750 1000 1250mm

GHDWOODHEAD creativespaces

Level 1, Grant Thornton House 215 Lambton Quay, Wellington New Zealand T 64 4 472 0799 F 64 4 472 0833 E wgtnmail@ghd.com W www.ghd.com

Conditions of Use.
This document may only be used by GHD's client (and any other person who GHD has agreed can use this document) for the purpose for which it was prepared and must not be used by any other person or for any other purpose.

DO NOT SCALE Scale As indicated

Client NEW ZEALAND TRANSPORT AGENCY


Project TIER 1.5 - CONTROL BUILDING **ARCHITECTURAL WORKS GENERAL ARRANGEMENT PLAN**

Drawing No: 51-34037-A100



1 CONSENT ISSUE 05.07.19 A CLIENT REVIEW RW WIP No Revision Drawn Date

Plot Date: 15/10/2019 10:37:36 a.m.

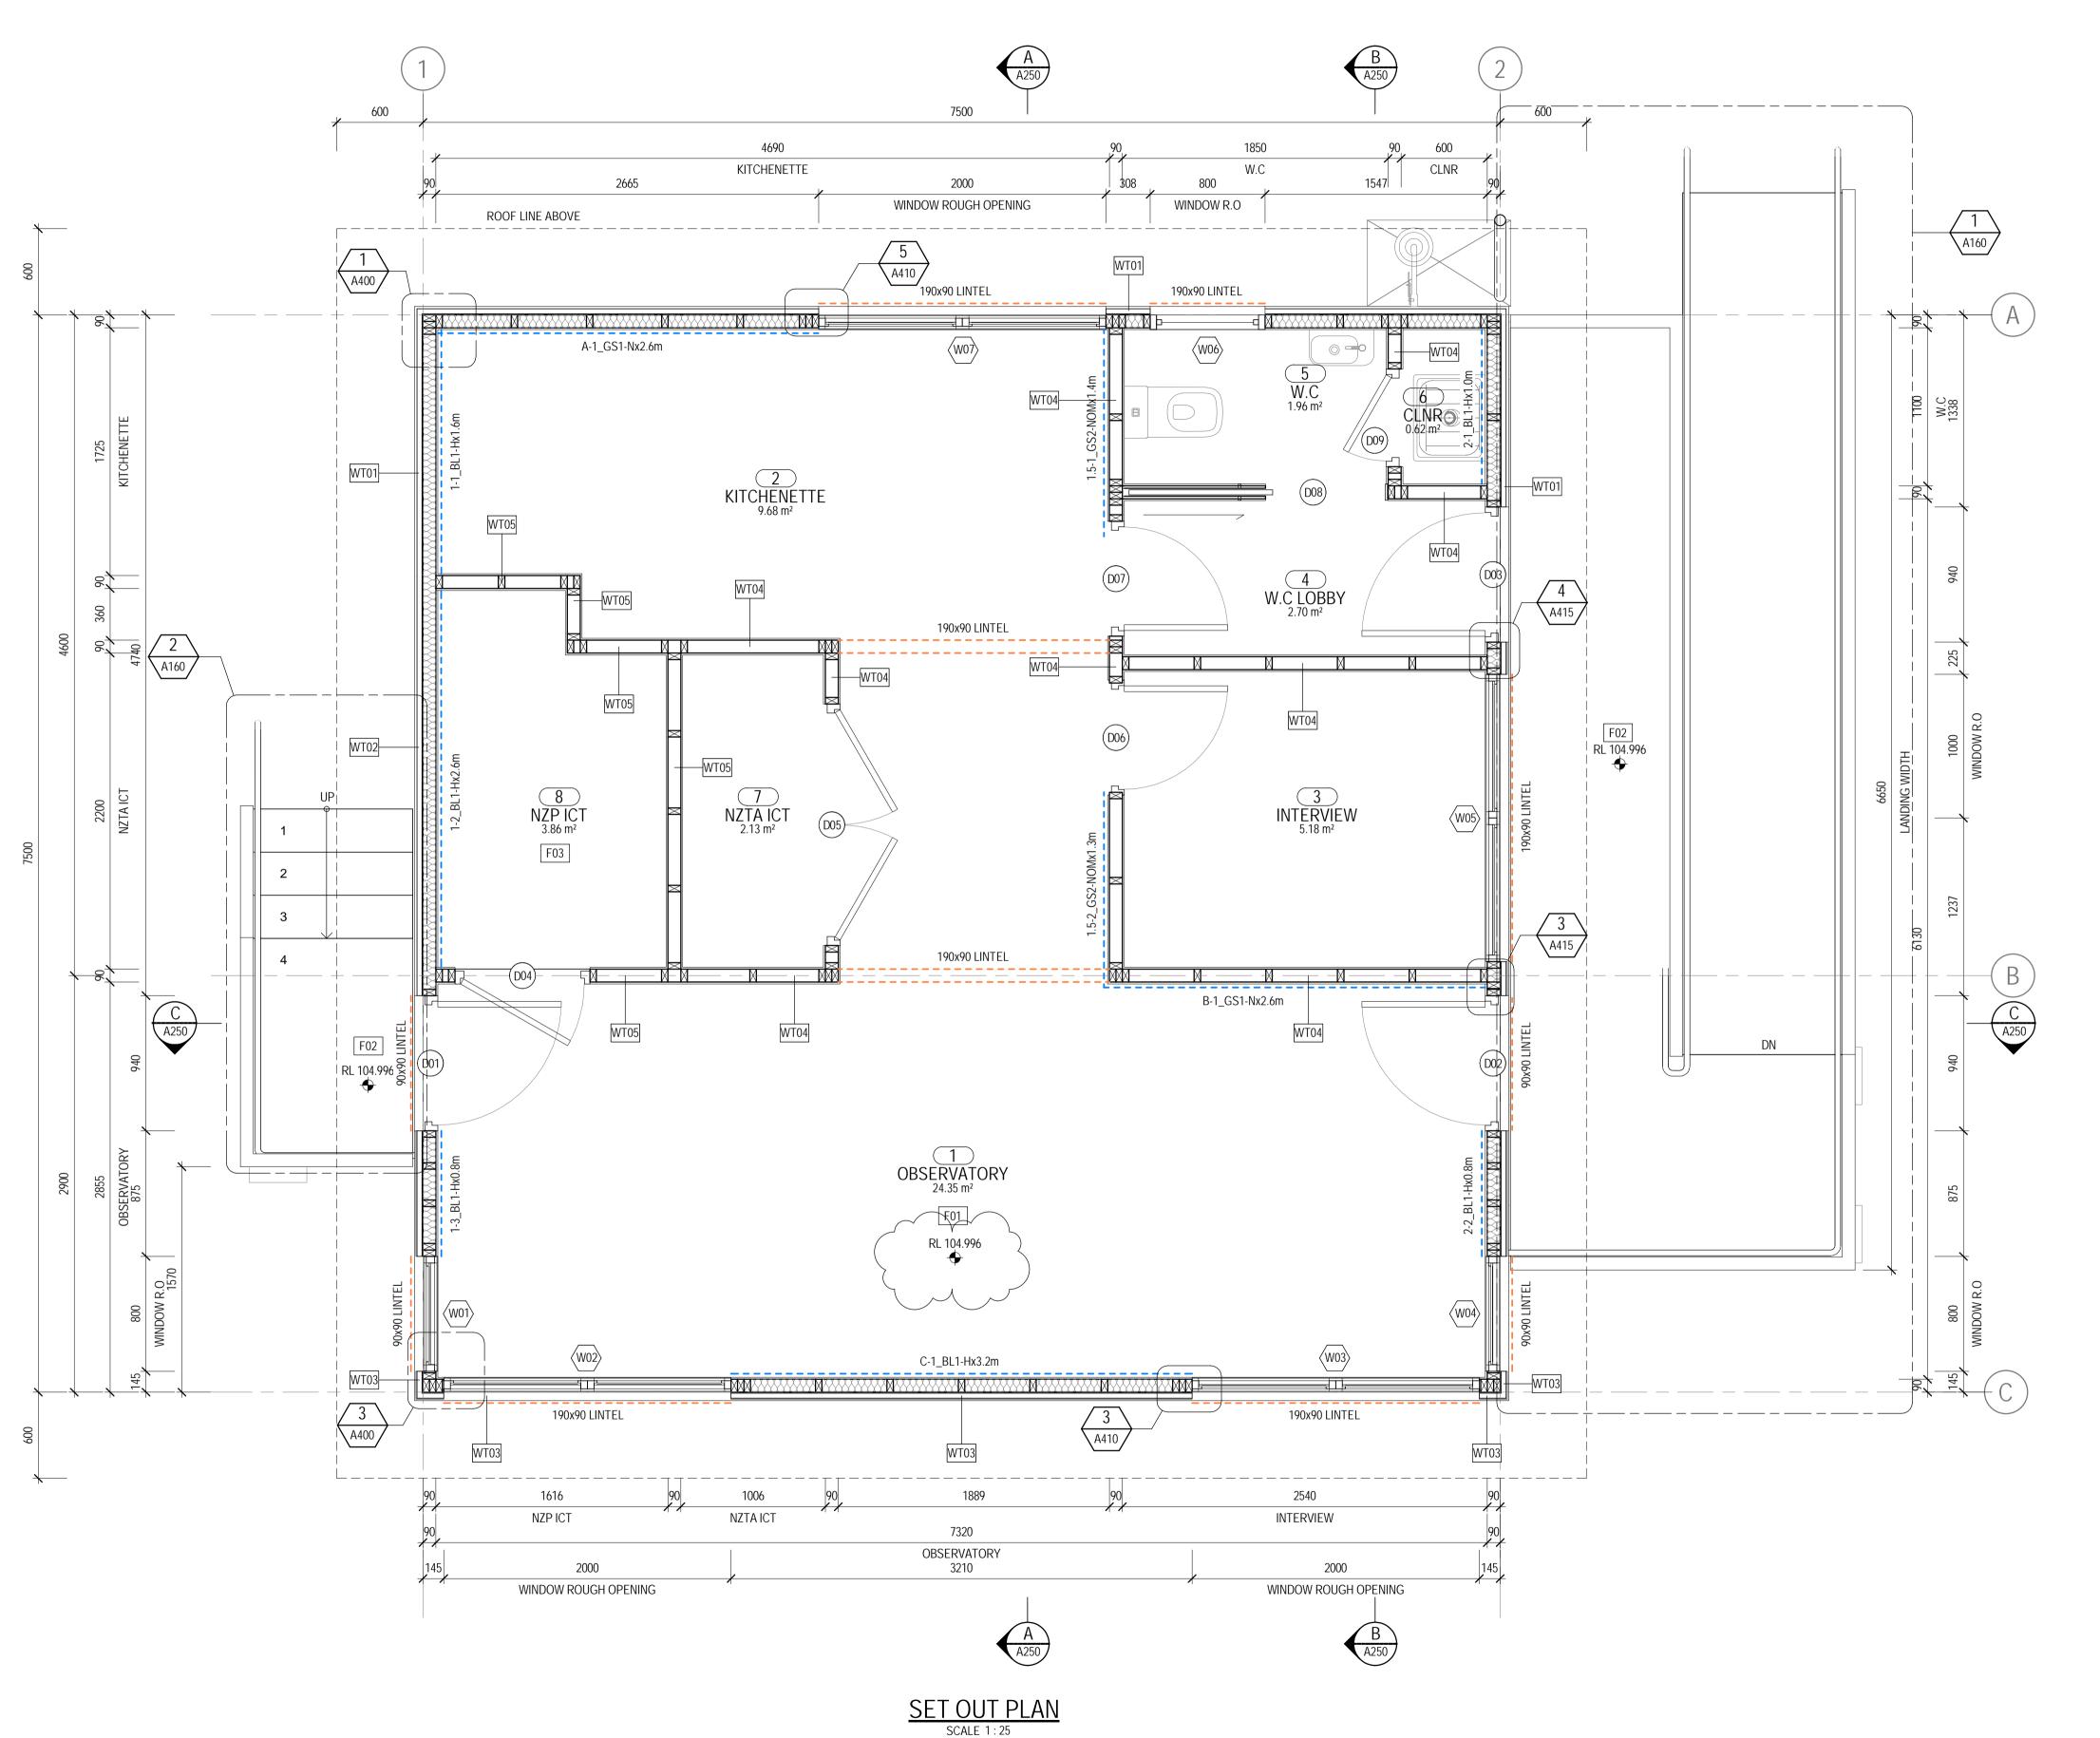

250 500 750 1000 1250mm

15.10.19

05.07.19

03.12.18

Drawn Date

INSULATION NOTES:

FIT R3.6 FIBERGLASS BATTS TO ALL CEILING SPACES -PINK BATTS R3.6 SKILLION ROOF INSULATION SHALL BE INSTALLED TO SKILLION ROOF TO ACHIEVE 25MM AIR GAP BETWEEN INSULATION AND ROOF UNDERLAY

WALL INSULATION:

EXTERIOR WALLS: ARE TO BE INSULATED WITH R2.8 PINK BATTS ULTRA FIBERGLASS BATTS.

UNDERFLOOR INSULATION: MAMMOTH POLYESTER R1.9 UNDERFLOOR SECTIONS

BRACING LEGEND

FITTED BETWEEN FLOOR JOISTS

---- BRACING ELEMENT 1-2_BL1-Hx1.9← BRACING ELEMENT LENGTH - BRACING ELEMENT TYPE BRACING LINE ELEMENT BRACING LINE

---- LINTEL ABOVE WINDOW

ROOM SCHEDULE							
Number	Name	Area					
1	OBSERVATORY	24.35 m ²					
2	KITCHENETTE	9.68 m ²					
3	INTERVIEW	5.18 m ²					
4	W.C LOBBY	2.70 m ²					
5	W.C	1.96 m ²					
6	CLNR	0.62 m ²					
7	NZTA ICT	2.13 m ²					
8	NZP ICT	3.86 m ²					

FLOOR LEGEND

TIMBER FLOOR

CRS MAX

TIMBER DECK

TIMBER FLOOR

CRS MAX

INSULATION R1.9

SECURITY SCREWS

19mm PLYWOOD

INSULATION R1.9

19mm PLYWOOD

140x45mm FLOOR JOISTS AT 450mm CRS

ADJACENT FLOOR JOISTS AT 1800mm

FULL DEPTH BLOCKING BETWEEN

MAMMOTH MULTI UNDERFLOOR

6mm FIBRE CEMENT LINING TO

PROPRIETARY JOINTERS.

UNDERSIDE OF FLOOR JOISTS -

EX. 100x32mm TIMBER DECKING

140x45 H3.2 FLOOR JOISTS AT 600 CRS

2mm GAUGED STEEL PLATE FIXED WITH

140x45mm H1.2 FLOOR JOISTS AT 450mm

ADJACENT FLOOR JOISTS AT 1800mm

FULL DEPTH BLOCKING BETWEEN

MAMMOTH MULTI UNDERFLOOR

• 6mm FIBRE CEMENT LINING TO

PROPRIETARY JOINTERS.

UNDERSIDE OF FLOOR JOISTS -

FLOOR TYPES:

F02

F03

TILE SETOUT POINT BUILDING/GRID SETOUT POINT LEVEL DATUM - TOP OF ELEMENT LEVEL DATUM - BOTTOM OF ELEMENT

PLAN SPOT RELATIVE LEVEL FALL DIRECTION SYMBOL

ARCHITECTURAL SYMBOLS

CENTRELINE OF ELEMENT

ACT **CEILING TAG** 2400 (D23) DOOR TAG

ROOM NUMBER

W1 WALL TYPE TAG (W.G.01-01) **WINDOW TAG**

(C.1.01-01) **CURTAIN WALL TAG**

CONCRETE FLOOR SLAB SETDOWN CONCRETE FLOOR SLAB EDGE

FFL 00.000 PLAN - FINISH FLOOR LEVEL

SL 00.000 PLAN - SLAB LEVEL

WALL TYPE LEGEND

WALL TYPES:

CORRUGATED HORIZONTAL CLADDING 13mm STANDARD PLASTERBOARD INTERIOR LINING - L4 FINISH • 90mm TIMBER FRAMING - STUDS @

400mm CENTRES R2.8 ULTRA WALL BATTS

 7mm ECOPLY RAB - SCREW FIXED 45x21 H3.2 TIMBER CAVITY BATTENS CORRUGATED PROFILE CLADDING

CORRUGATED HORIZONTAL CLADDING

 13mm STANDARD PLASTERBOARD INTERIOR LINING - L4 FINISH 90mm TIMBER FRAMING - STUDS @

400mm CENTRES 2mm GAUGED STEEL SHEET INSTALLED TO INSIDE FACE OF WALL FRAMING

 R2.8 ULTRA WALL BATTS 7mm ECOPLY RAB - SCREW FIXED 45x21 H3.2 TIMBER CAVITY BATTENS

CORRUGATED PROFILE CLADDING

JAMES HARDIE HARDIEFLEX PANEL 13mm STANDARD PLASTERBOARD

INTERIOR LINING - L4 FINISH • 90mm TIMBER FRAMING - STUDS @ 400mm CENTRES

 R2.8 ULTRA WALL BATTS 7mm ECOPLY RAB - SCREW FIXED

 45x21 H3.2 TIMBER CAVITY BATTENS JAMES HARDIE HARDIEFLEX SHEET

CLADDING INTERIOR TIMBER WALL

WT04

• 90mm TIMBER FRAMING - STUDS @ 600mm CENTRES • 13mm GIB PLASTERBOARD BOTH SIDES

L4 FINISH - REFER TO BRACING PLAN FOR LOCATION BRACING UNITS

INTERIOR TIMBER WALL • 90mm TIMBER FRAMING - STUDS @ 600mm CENTRES

 2mm GAUGED STEEL SHEET INSTALLED TO NZP ICT ROOM FACE OF WALL **FRAMING**

• 13mm GIB PLASTERBOARD BOTH SIDES L4 FINISH - REFER TO BRACING PLAN FOR LOCATION BRACING UNITS

TENDER / CONSENT

GHDWOODHEAD creativespaces

Level 1, Grant Thornton House 215 Lambton Quay, Wellington New Zealand **T** 64 4 472 0799 **F** 64 4 472 0833 E wgtnmail@ghd.com W www.ghd.com

Conditions of Use.
This document may only be used by GHD's client (and any other person who GHD has agreed can use this document) for the purpose for which it was prepared and must not be used by any other person or for any other purpose.

DO NOT SCALE Scale As indicated

Client NEW ZEALAND TRANSPORT AGENCY Project TIER 1.5 - CONTROL BUILDING


ARCHITECTURAL WORKS SET OUT PLAN

Drawing No: 51-34037-A101

1 CONSENT ISSUE

A FOR INFORMATION

2 REVISED FOR CONSENT

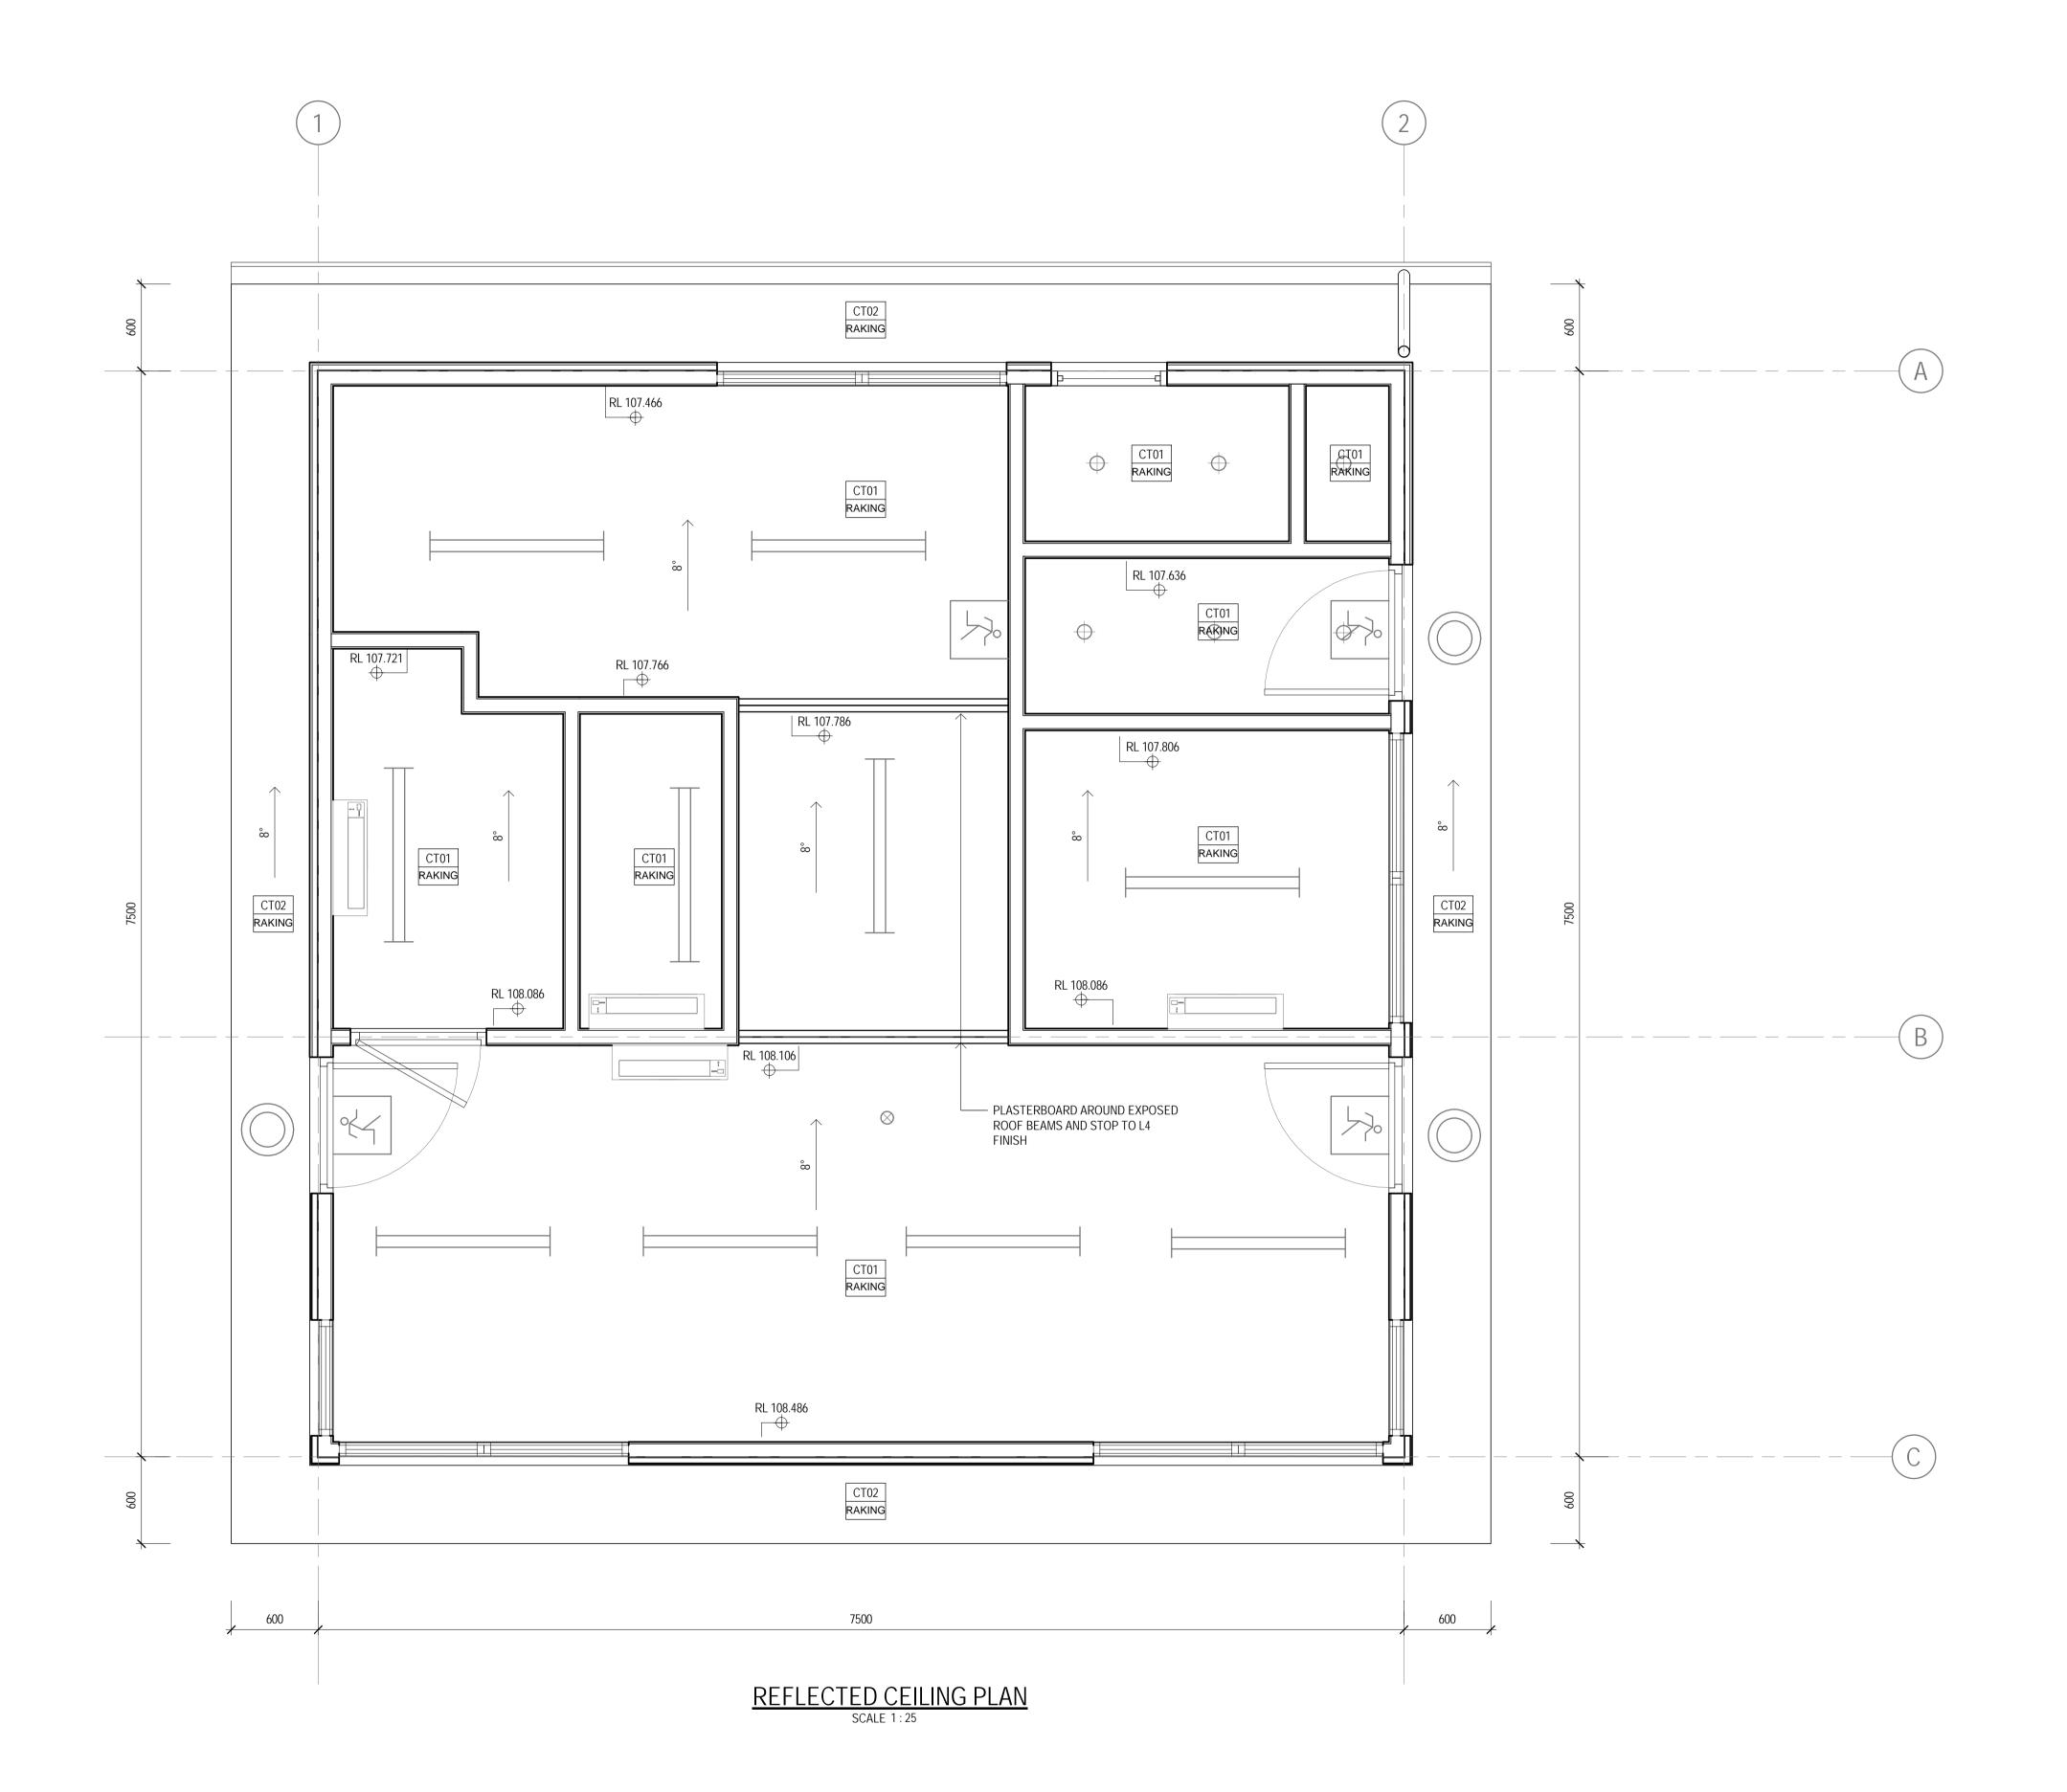

CEILING LEGEND

CT02 SOFFIT LINING

CEILING NOTES

REQUIREMENTS.

CT01

PLASTERBOARD CEILING

13mm PLASTERBOARD, L4 FINISH.

HEIGHT PAINTED

• 308 RONDO CEILING BATTENS ON

HEIGHT

• 6mm I HICK FIBRE CLIVILINI
• PROPRIETARY JOINTERS
• 45mm FRAMING

REQUIRED CEILING ACCESS POINTS PROVIDE ACCESS PANELS IN CEILING IN ACCORDANCE WITH BUILDING SERVICES

BETWEEN ADJACENT WALLS.

CURTAIN TRACKS ARE HUNG.

PAINTED

GIB 226 CLIP FIXED TO ROOF FRAMING

6mm THICK FIBRE CEMENT SHEET

• REFER TO ELECTRICAL DRAWINGS TO COORDINATE LIGHTING AND FOR INSTALLATION DETAILS REFER TO SERVICES DRAWINGS FOR OTHER


• CEILING PLANS TO BE READ IN CONJUNCTION WITH BUILDING SERVICES AND RELEVANT SHOP DRAWINGS.

 CEILING EQUIPMENT/FITTINGS TO ALIGN WHERE POSSIBLE (CENTRE LINES) AND BE SPACED EVENLY

PROVIDE ADDITIONAL SUPPORTS IN THE CEILING

SUSPENSION SYSTEM WHERE CEILING MOUNTED

 CEILING MOUNTED EQUIPMENT/FITTINGS ARE TO ALIGN WHERE POSSIBLE (CENTRE LINES) AND BE SPACED EVENLY BETWEEN ADJACENT WALLS.

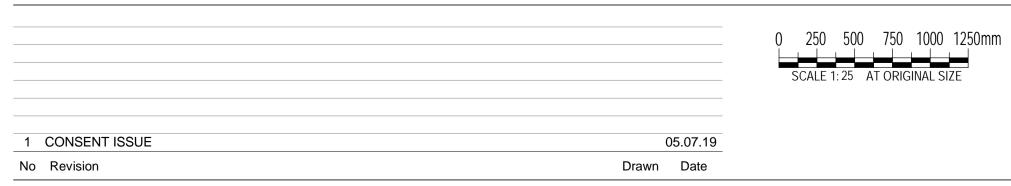

GHDWOODHEAD creativespaces

Level 1, Grant Thornton House 215 Lambton Quay, Wellington New Zealand T 64 4 472 0799 F 64 4 472 0833 E wgtnmail@ghd.com W www.ghd.com

Conditions of Use.
This document may only be used by
GHD's client (and any other person who
GHD has agreed can use this document) for the purpose for which it was prepared and must not be used by any other person or for any other purpose.


DO NOT SCALE Scale 1 : 25

Client NEW ZEALAND TRANSPORT AGENCY Project TIER 1.5 - CONTROL BUILDING

ARCHITECTURAL WORKS

REFLECTED CEILING PLAN

Drawing No: 51-34037-A105

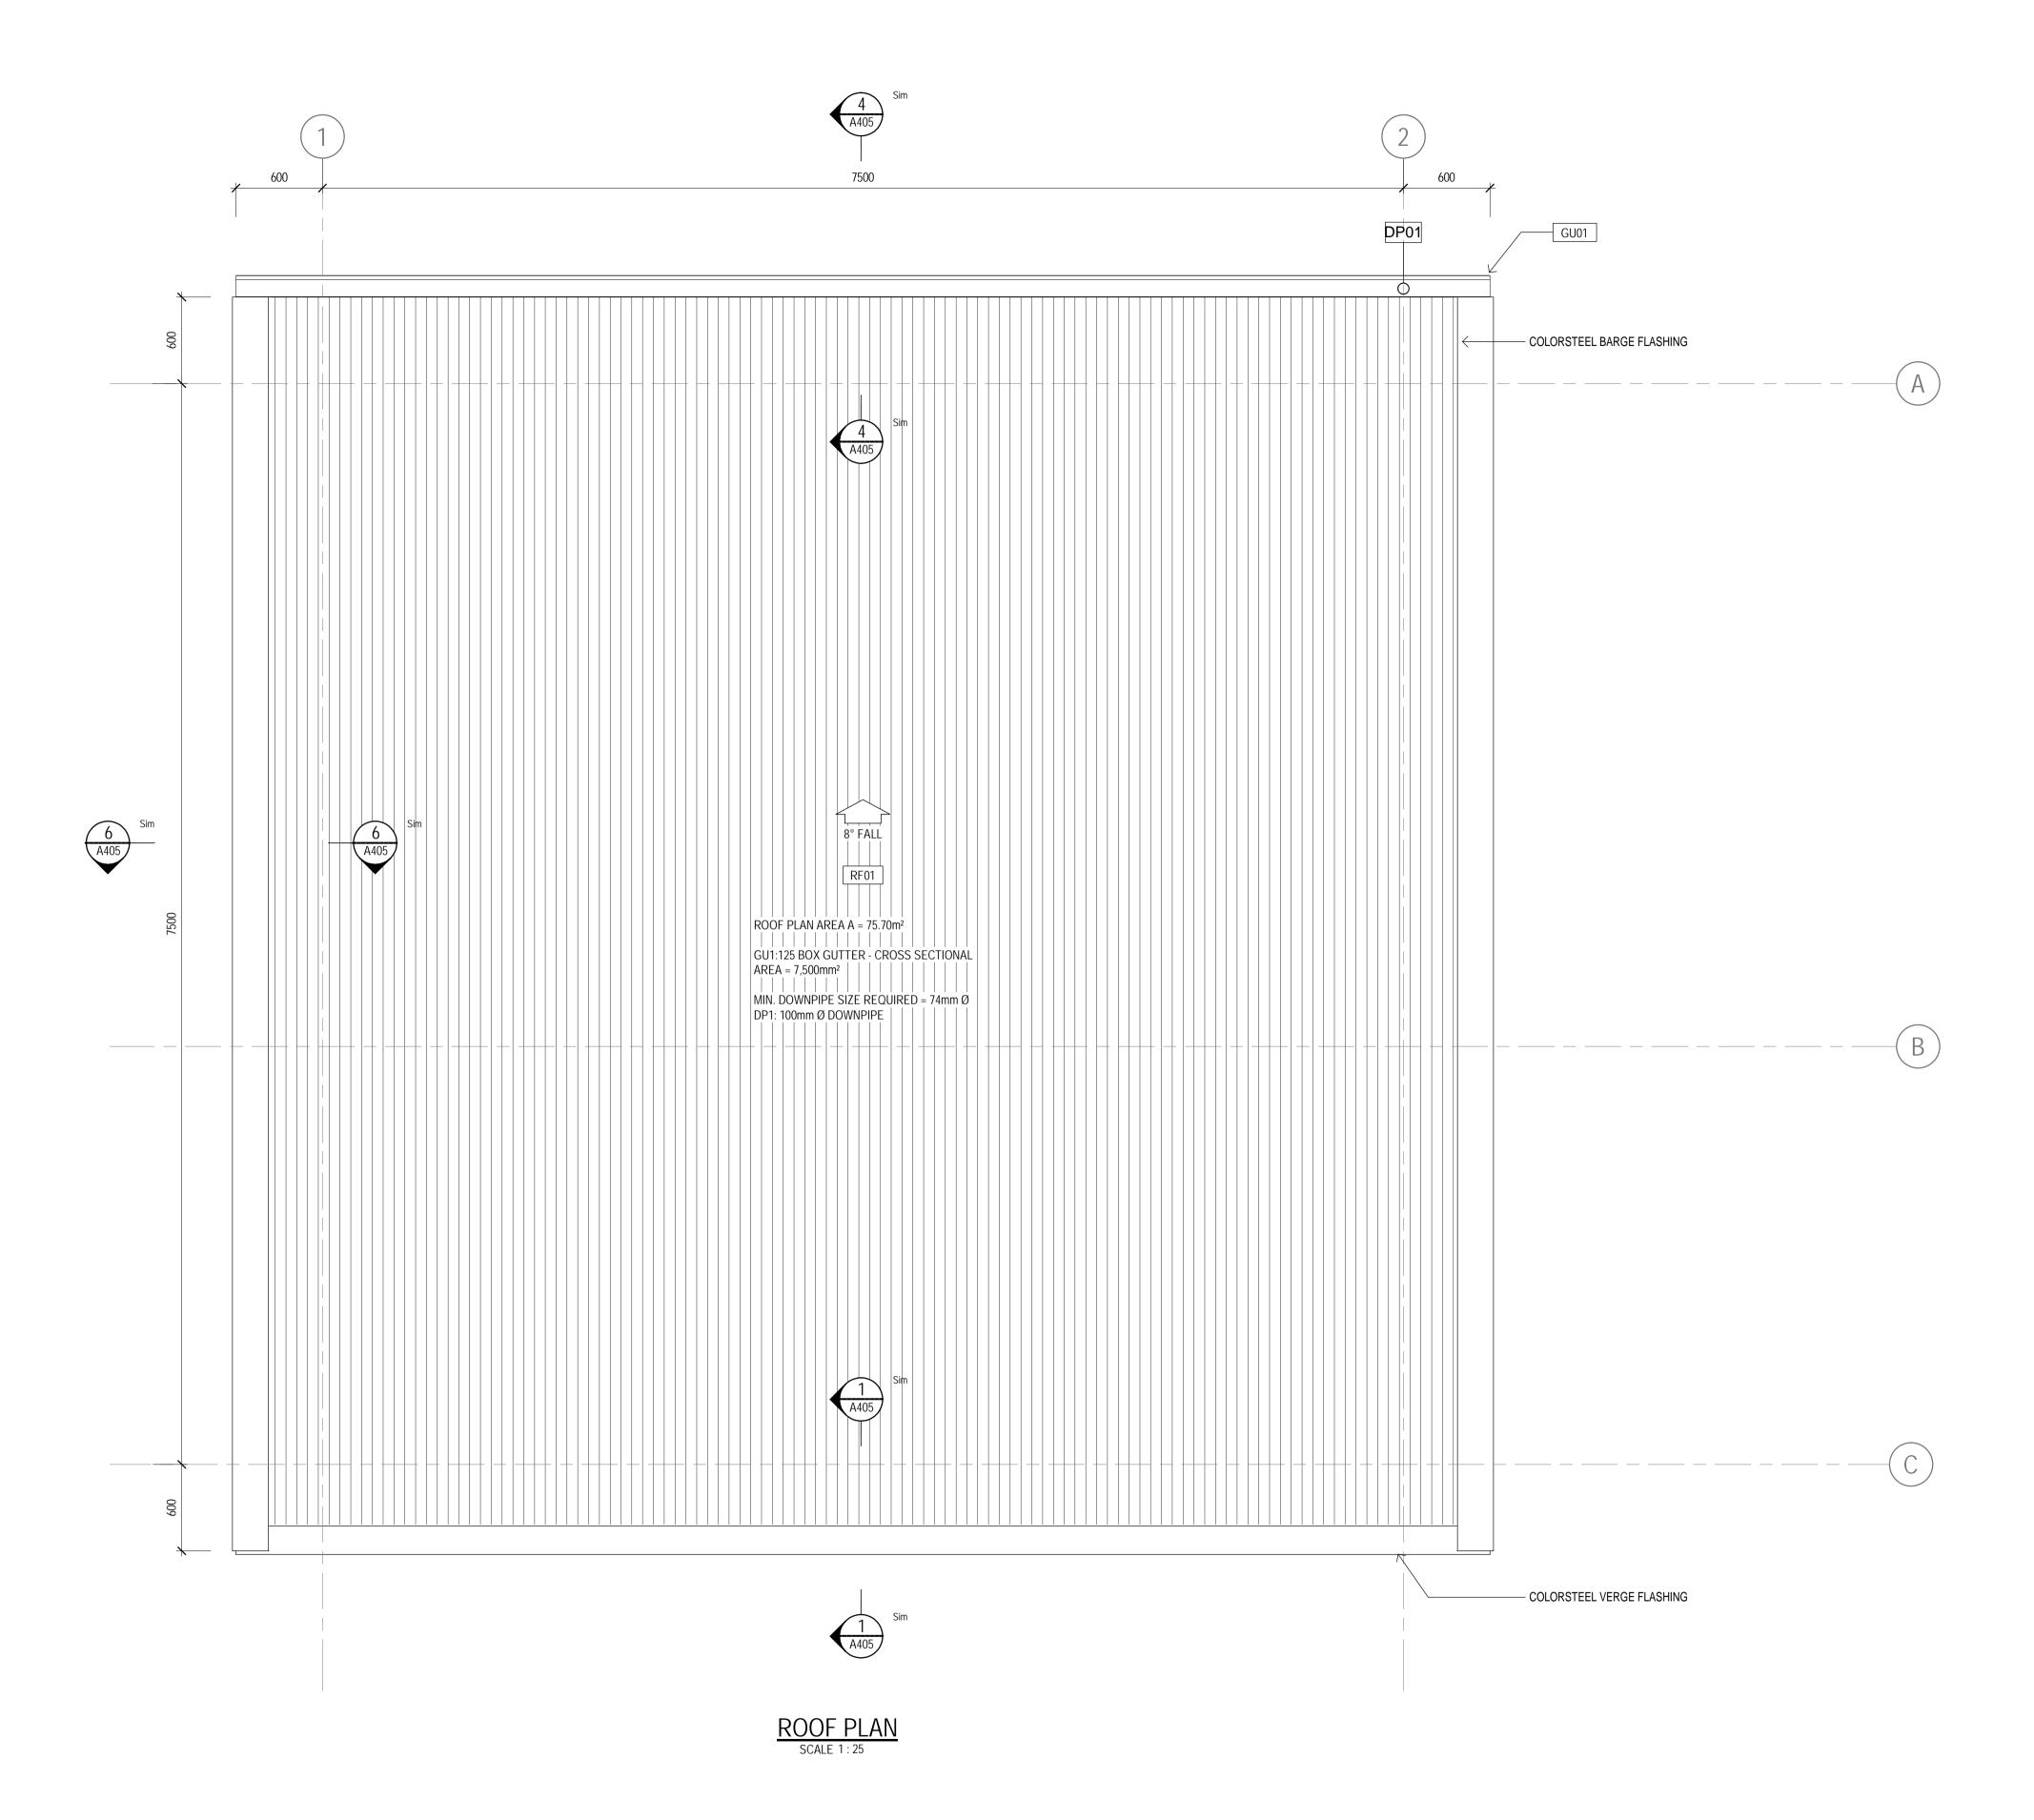

ROOF LEGEND

RF01 DIMOND CORRUGATE

'GREY FRIARS' ROOF UNDERLAY

GU01 STEEL GUTTER - 125 BOX

DP01 100mmØ DOWN PIPE
DIMOND 0.55mm STEEL

ROOF NOTES

DISCHARGE.

SERVICE PENETRATIONS.

SPECIFICATION FOR DETAILS.

'GREY FRIARS'

FINISH TO MATCH ROOFING

1. ALL OTHER RAINWATER GOODS, FIXINGS AND

3. ALL ROOF PENETRATIONS TO BE APPROPRIATELY FLASHED/SEALED TO RIDGE LINE, REFER TO

4. CONNECT ALL NEW RAINWATER DOWNPIPES TO STORM WATER RETICULATION AND LEGAL POINT OF

SEALANTS TO MATCH ROOF SHEETING. 2. REFER TO SERVICES DRAWINGS FOR ALL ROOF

CTRS FIXED ON FLAT

 DIMOND CORRUGATE 0.55mm ROOFING COLORSTEEL MAXX FINISH - COLOUR

70x45mm H3.2 TIMBER PURLINS @ 900mm

 290x45mm H1.2 TIMBER RAFTERS AT 480mm CTRS NOTCHED AT SOFFIT

 DIMOND BOX 125 GUTTER PROFILE COLORSTEEL MAXX FINISH - COLOUR

GHDWOODHEAD 250 500 750 1000 1250mm creativespaces Level 1, Grant Thornton House 215 Lambton Quay, Wellington New Zealand T 64 4 472 0799 F 64 4 472 0833 1 CONSENT ISSUE 05.07.19 E wgtnmail@ghd.com W www.ghd.com

Conditions of Use.
This document may only be used by
GHD's client (and any other person who
GHD has agreed can use this document) for the purpose for which it was prepared and must not be used by any other person or for any other purpose.

DO NOT SCALE Scale As indicated


Client NEW ZEALAND TRANSPORT AGENCY Project TIER 1.5 - CONTROL BUILDING

ARCHITECTURAL WORKS ROOF PLAN

A1 Drawing No: 51-34037-A110

No Revision

Drawn Date

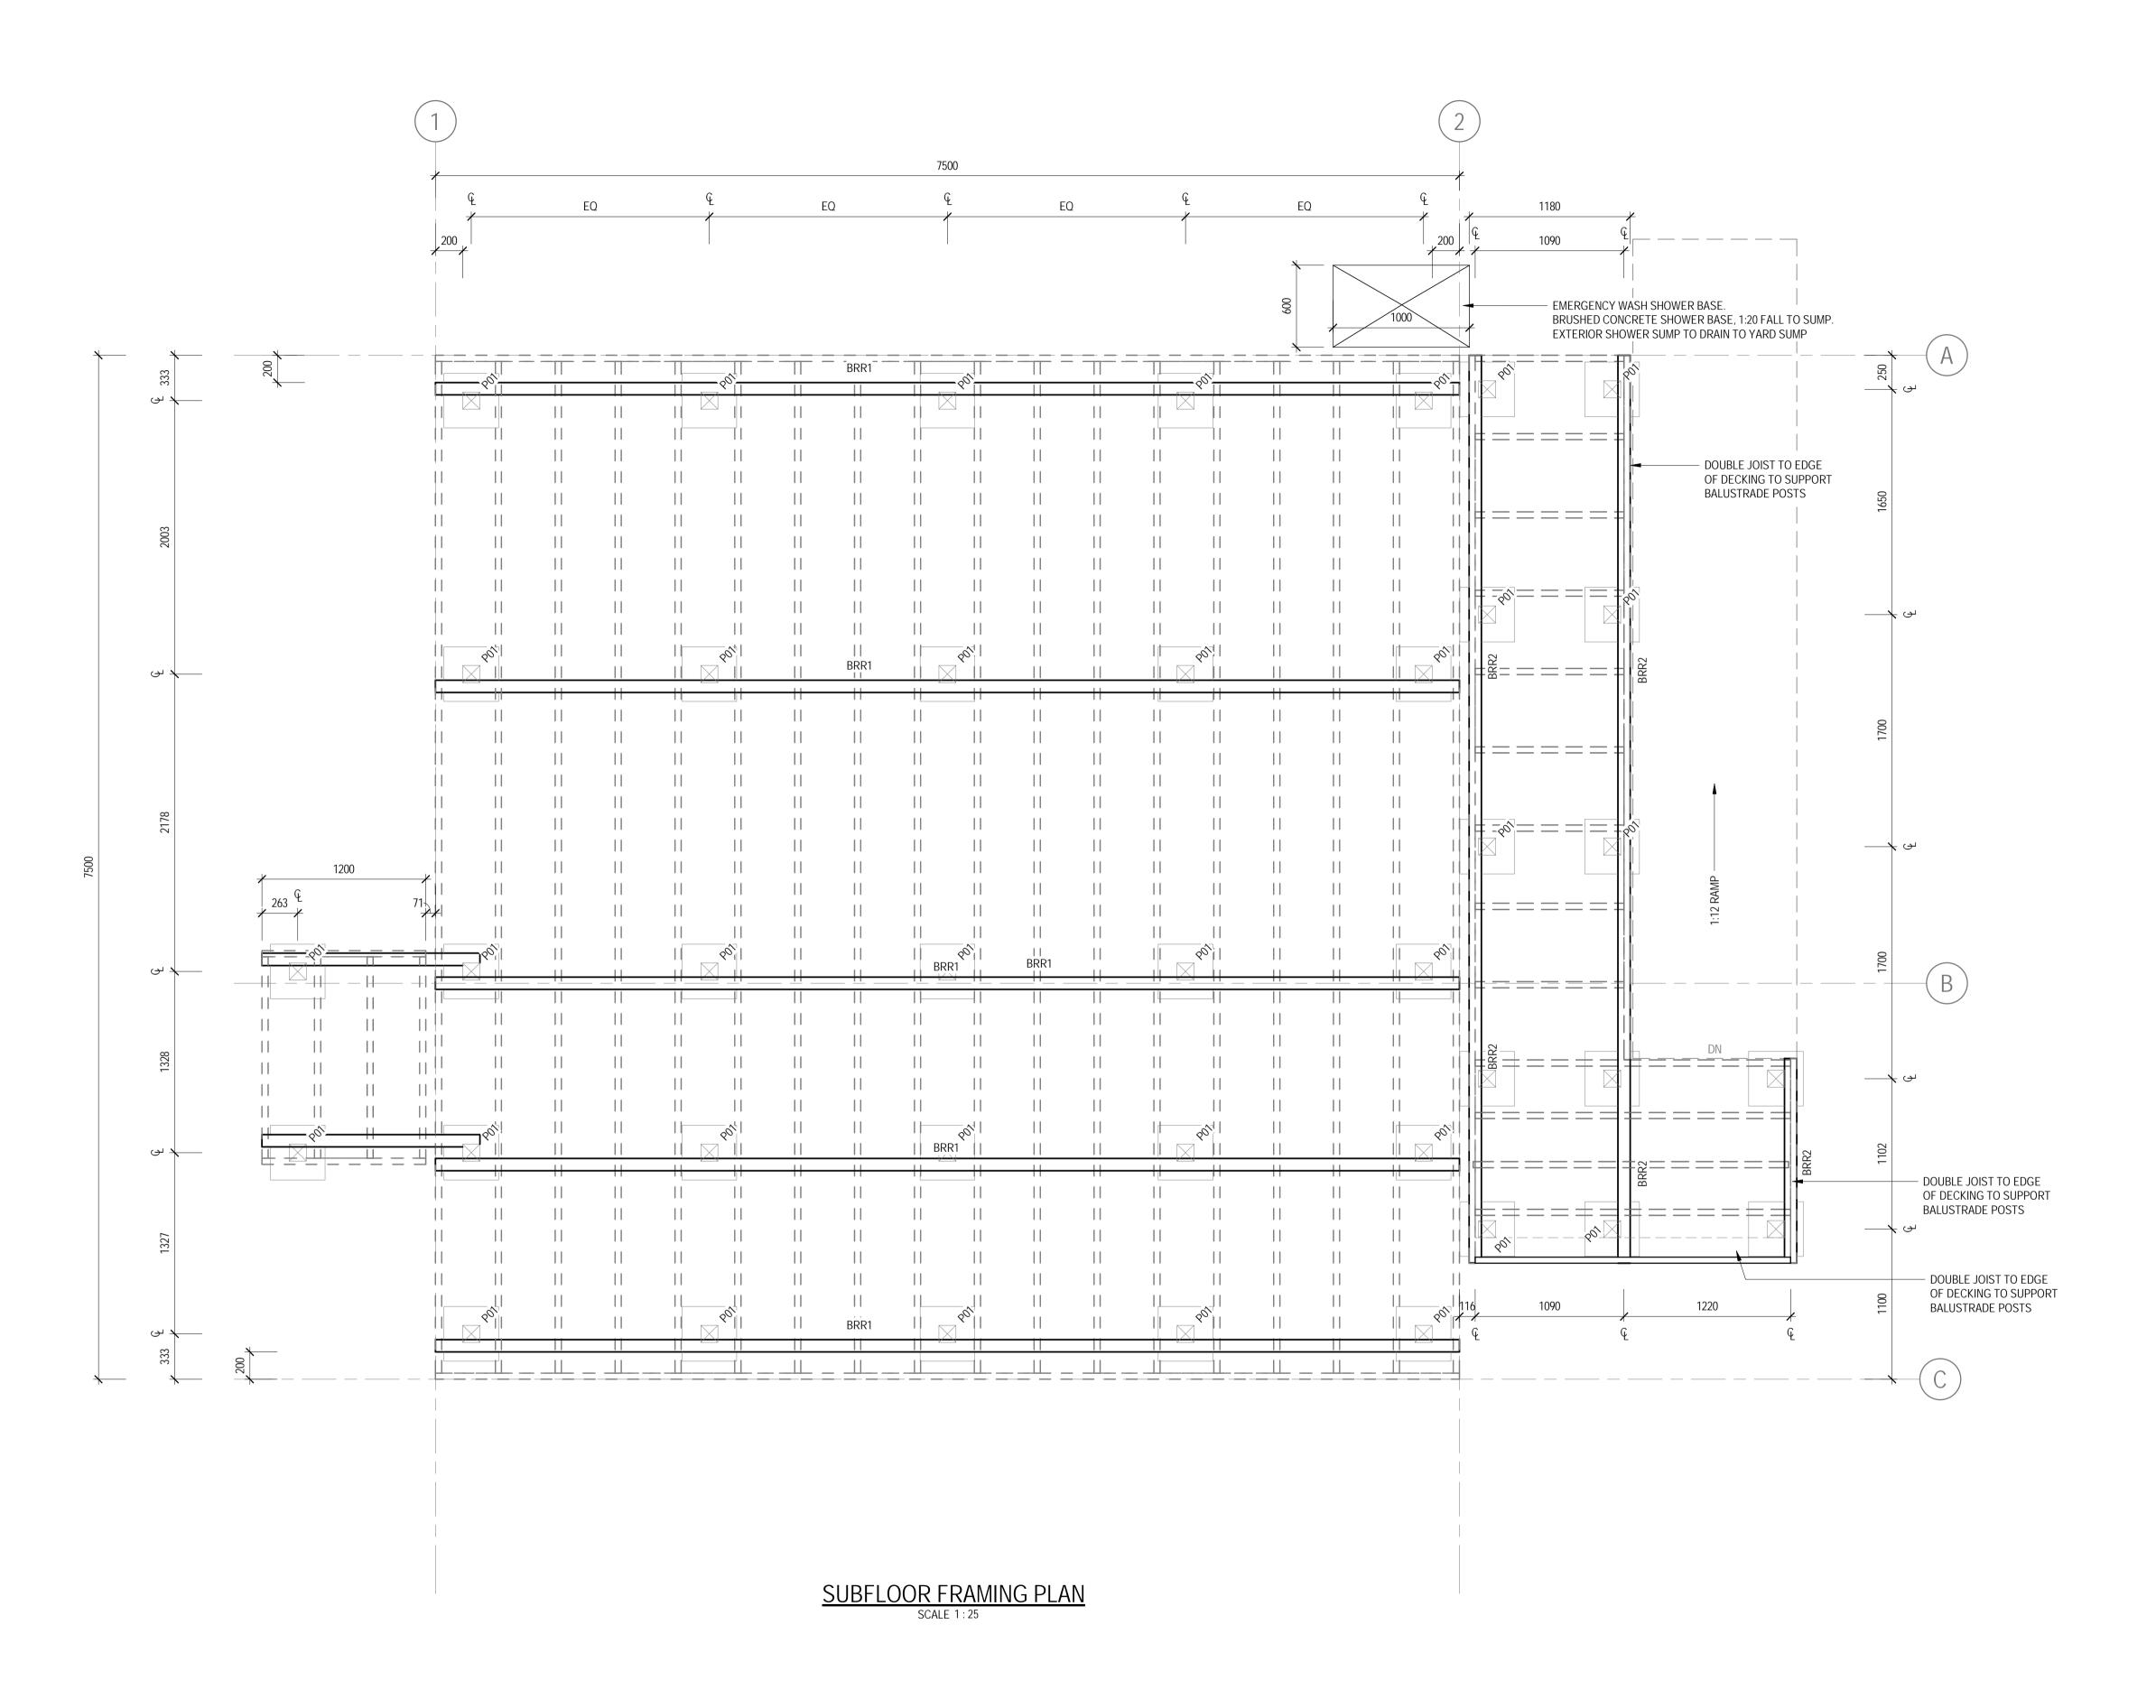

SUB FLOOR FRAMING & FOOTING LEGEND

GROUND BEARING CAPACITY

BEARING CAPACITY OF THE SOIL MUST MEET 'GOOD GROUND CONDITIONS' AS DEFINED IN NZS3604:2011 AND HAVE A ULTIMATE BEARING CAPACITY OF 300kPa.

IF THE PILE HOLES FAIL TO MEET THE 3000kPa ULTIMATE BEARING CAPACITY, THE ARCHITECT SHALL BE NOTIFIED AND A SPECIFIC ENGINEERING DESIGN WILL BE REQUIRED.

TIMBER PILE

 125x125mm H5 TIMBER PILE IN 400x400, 900mm DEEP CONCRETE FOOTING

BRR1 TIMBER BEARER - PROTECTED 140x90mm SG8 H1.2 TIMBER BEARER

BRR2 TIMBER BEARER - EXPOSED

NOTE: THE TIMBER BEARERS SHALL BE FIXED TO EACH TIMBER PILE WITH 1/ M12 SS BOLT WITH 50x50x3mm SS WASHER. BEARER TO BE OVER 300mm TO GROUND

140x90mm SG8 H3.2 TIMBER BEARER

TENDER / CONSENT

250 500 750 1000 1250mm 1 CONSENT ISSUE DA 05.07.19 No Revision Drawn Date

GHDWOODHEAD creativespaces

Level 1, Grant Thornton House 215 Lambton Quay, Wellington New Zealand T 64 4 472 0799 F 64 4 472 0833 E wgtnmail@ghd.com W www.ghd.com


Conditions of Use.
This document may only be used by
GHD's client (and any other person who
GHD has agreed can use this document) for the purpose for which it was prepared and must not be used by any other person or for any other purpose.

DO NOT SCALE Scale As indicated

Client NEW ZEALAND TRANSPORT AGENCY Project TIER 1.5 - CONTROL BUILDING

ARCHITECTURAL WORKS SUBFLOOR FRAMING PLAN

Drawing No: 51-34037-A120

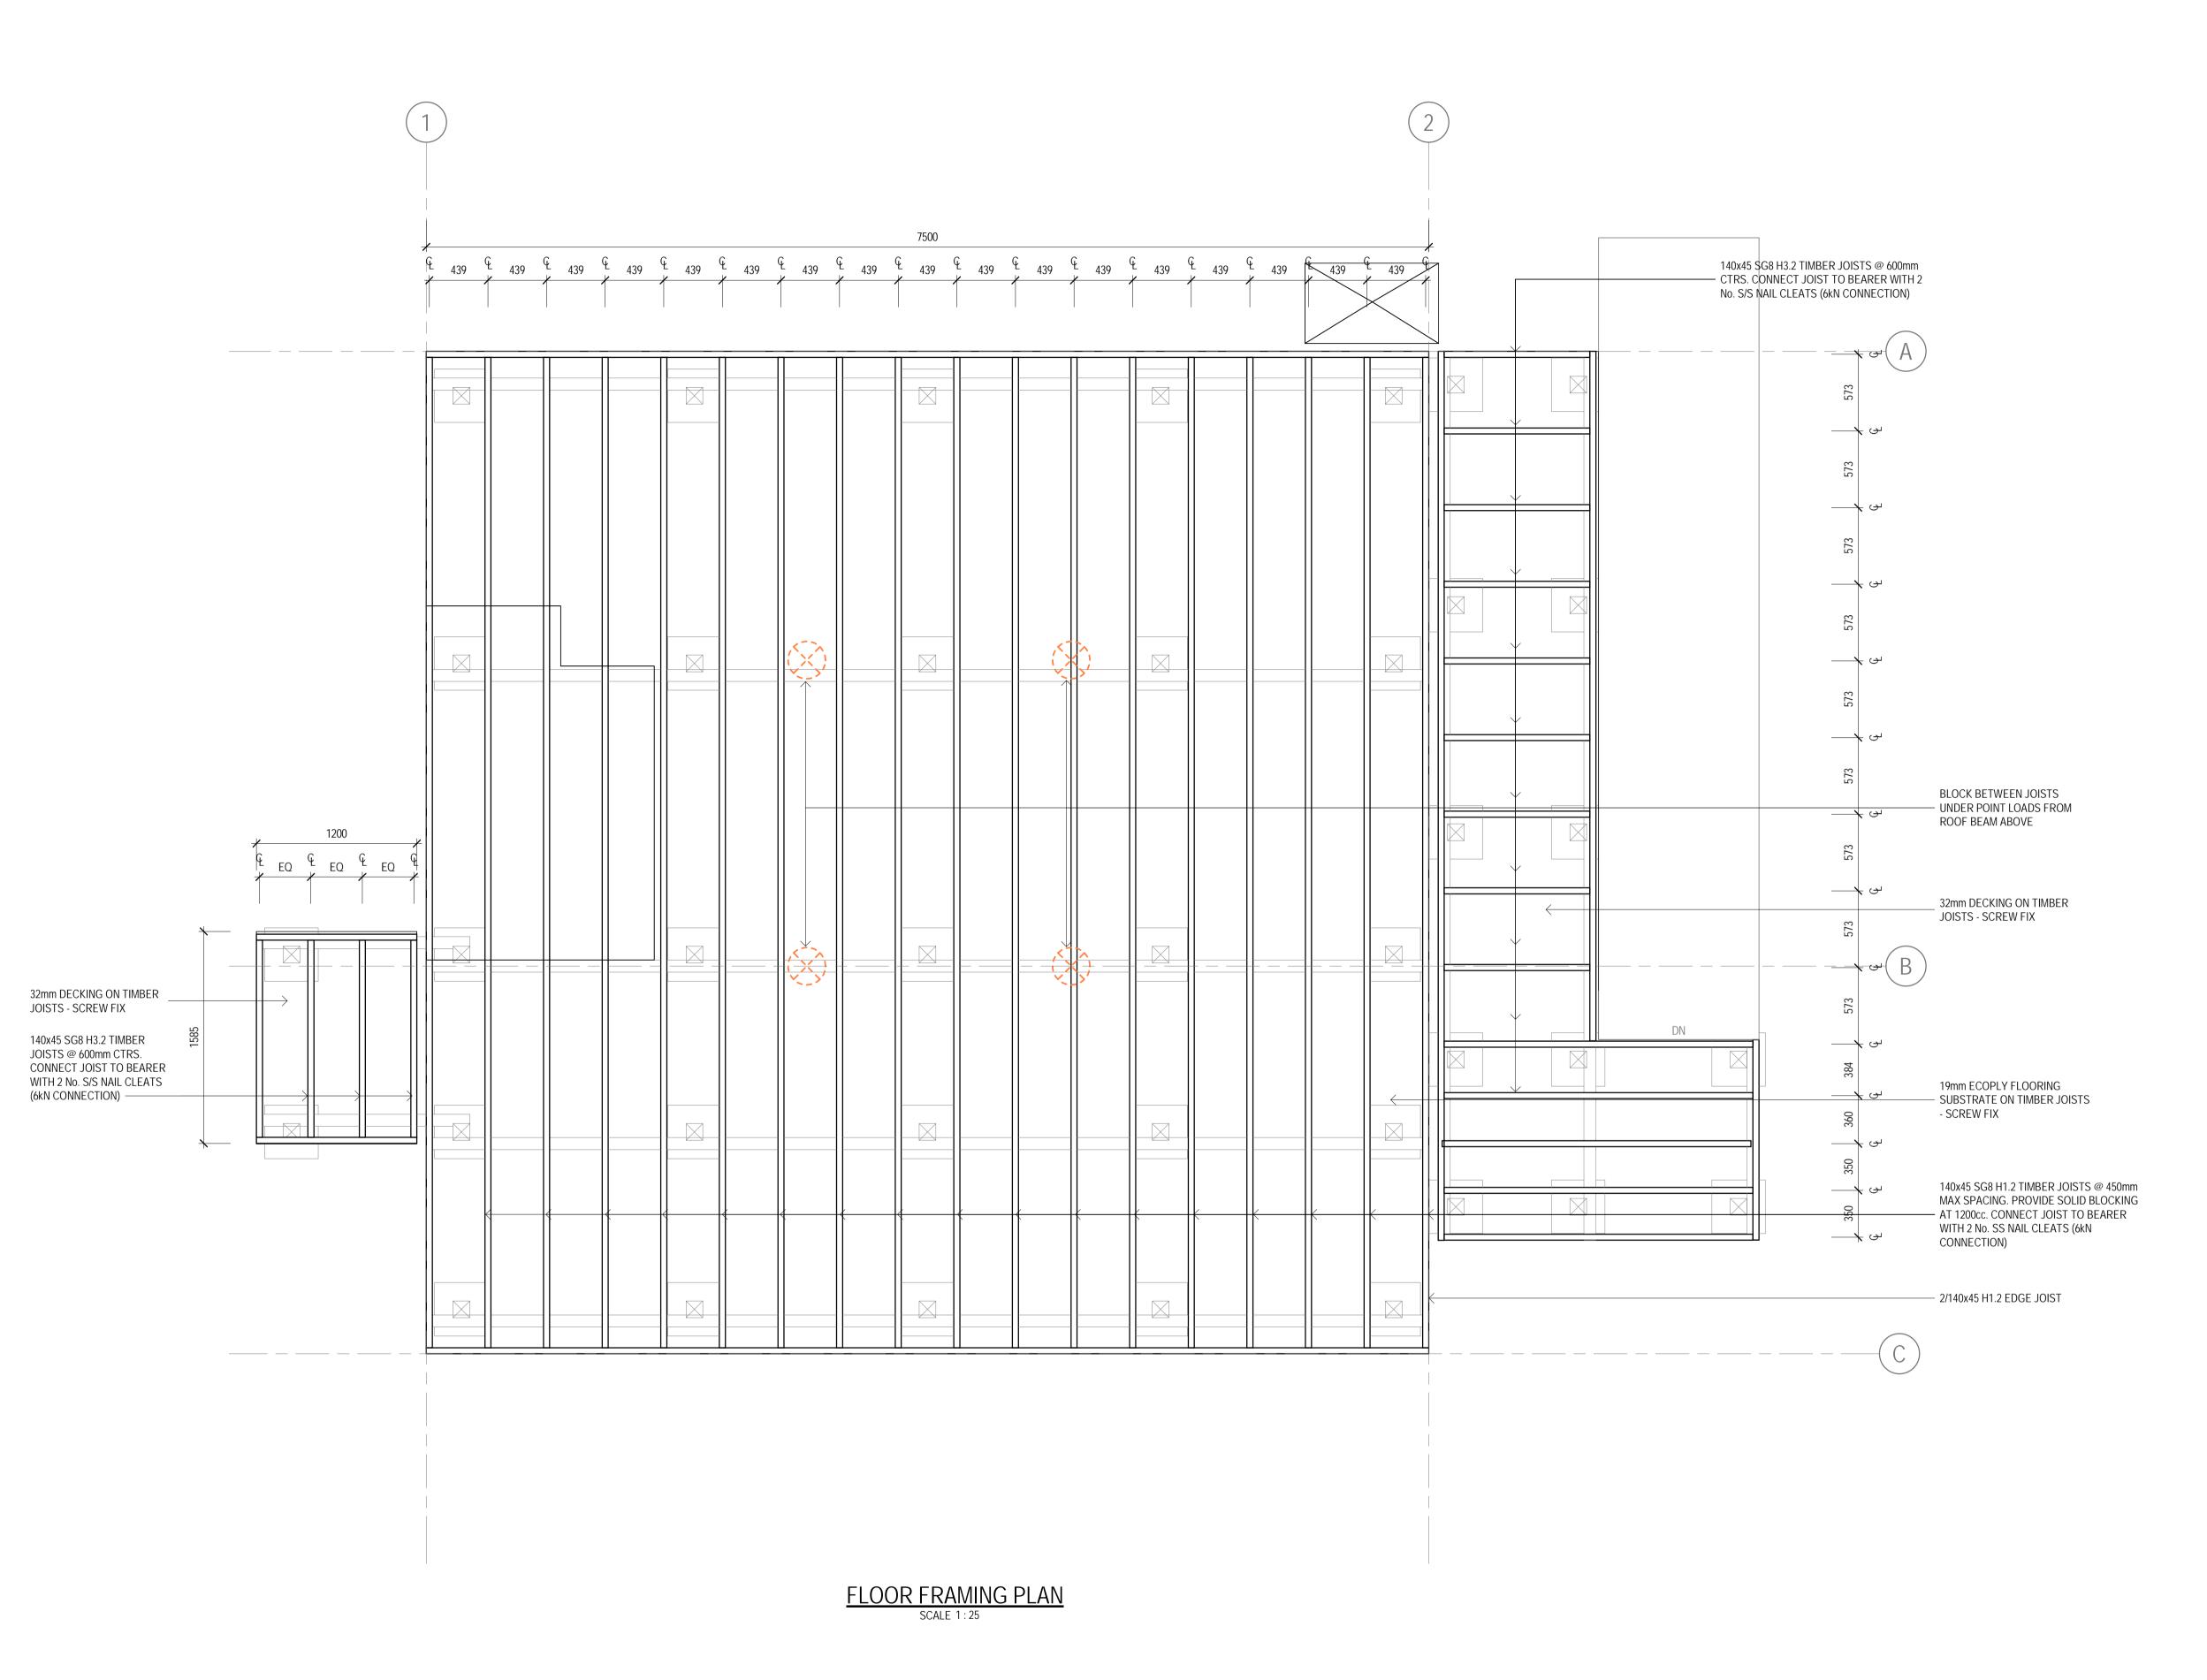

1 CONSENT ISSUE

0 250 500 750 1000 1250mm

SCALE 1: 25 AT ORIGINAL SIZE

1 CONSENT ISSUE

Drawn Date

GHDWOODHEAD creativespaces


Level 1, Grant Thornton House 215 Lambton Quay, Wellington New Zealand T 64 4 472 0799 F 64 4 472 0833 E wgtnmail@ghd.com W www.ghd.com Conditions of Use.
This document may only be used by
GHD's client (and any other person who
GHD has agreed can use this document)
for the purpose for which it was prepared
and must not be used by any other
person or for any other purpose.

DO NOT SCALE
Scale 1:25

Client NEW ZEALAND TRANSPORT AGENCY
Project TIER 1.5 - CONTROL BUILDING

ARCHITECTURAL WORKS FLOOR FRAMING PLAN

A1 Drawing No: 51-34037-A121

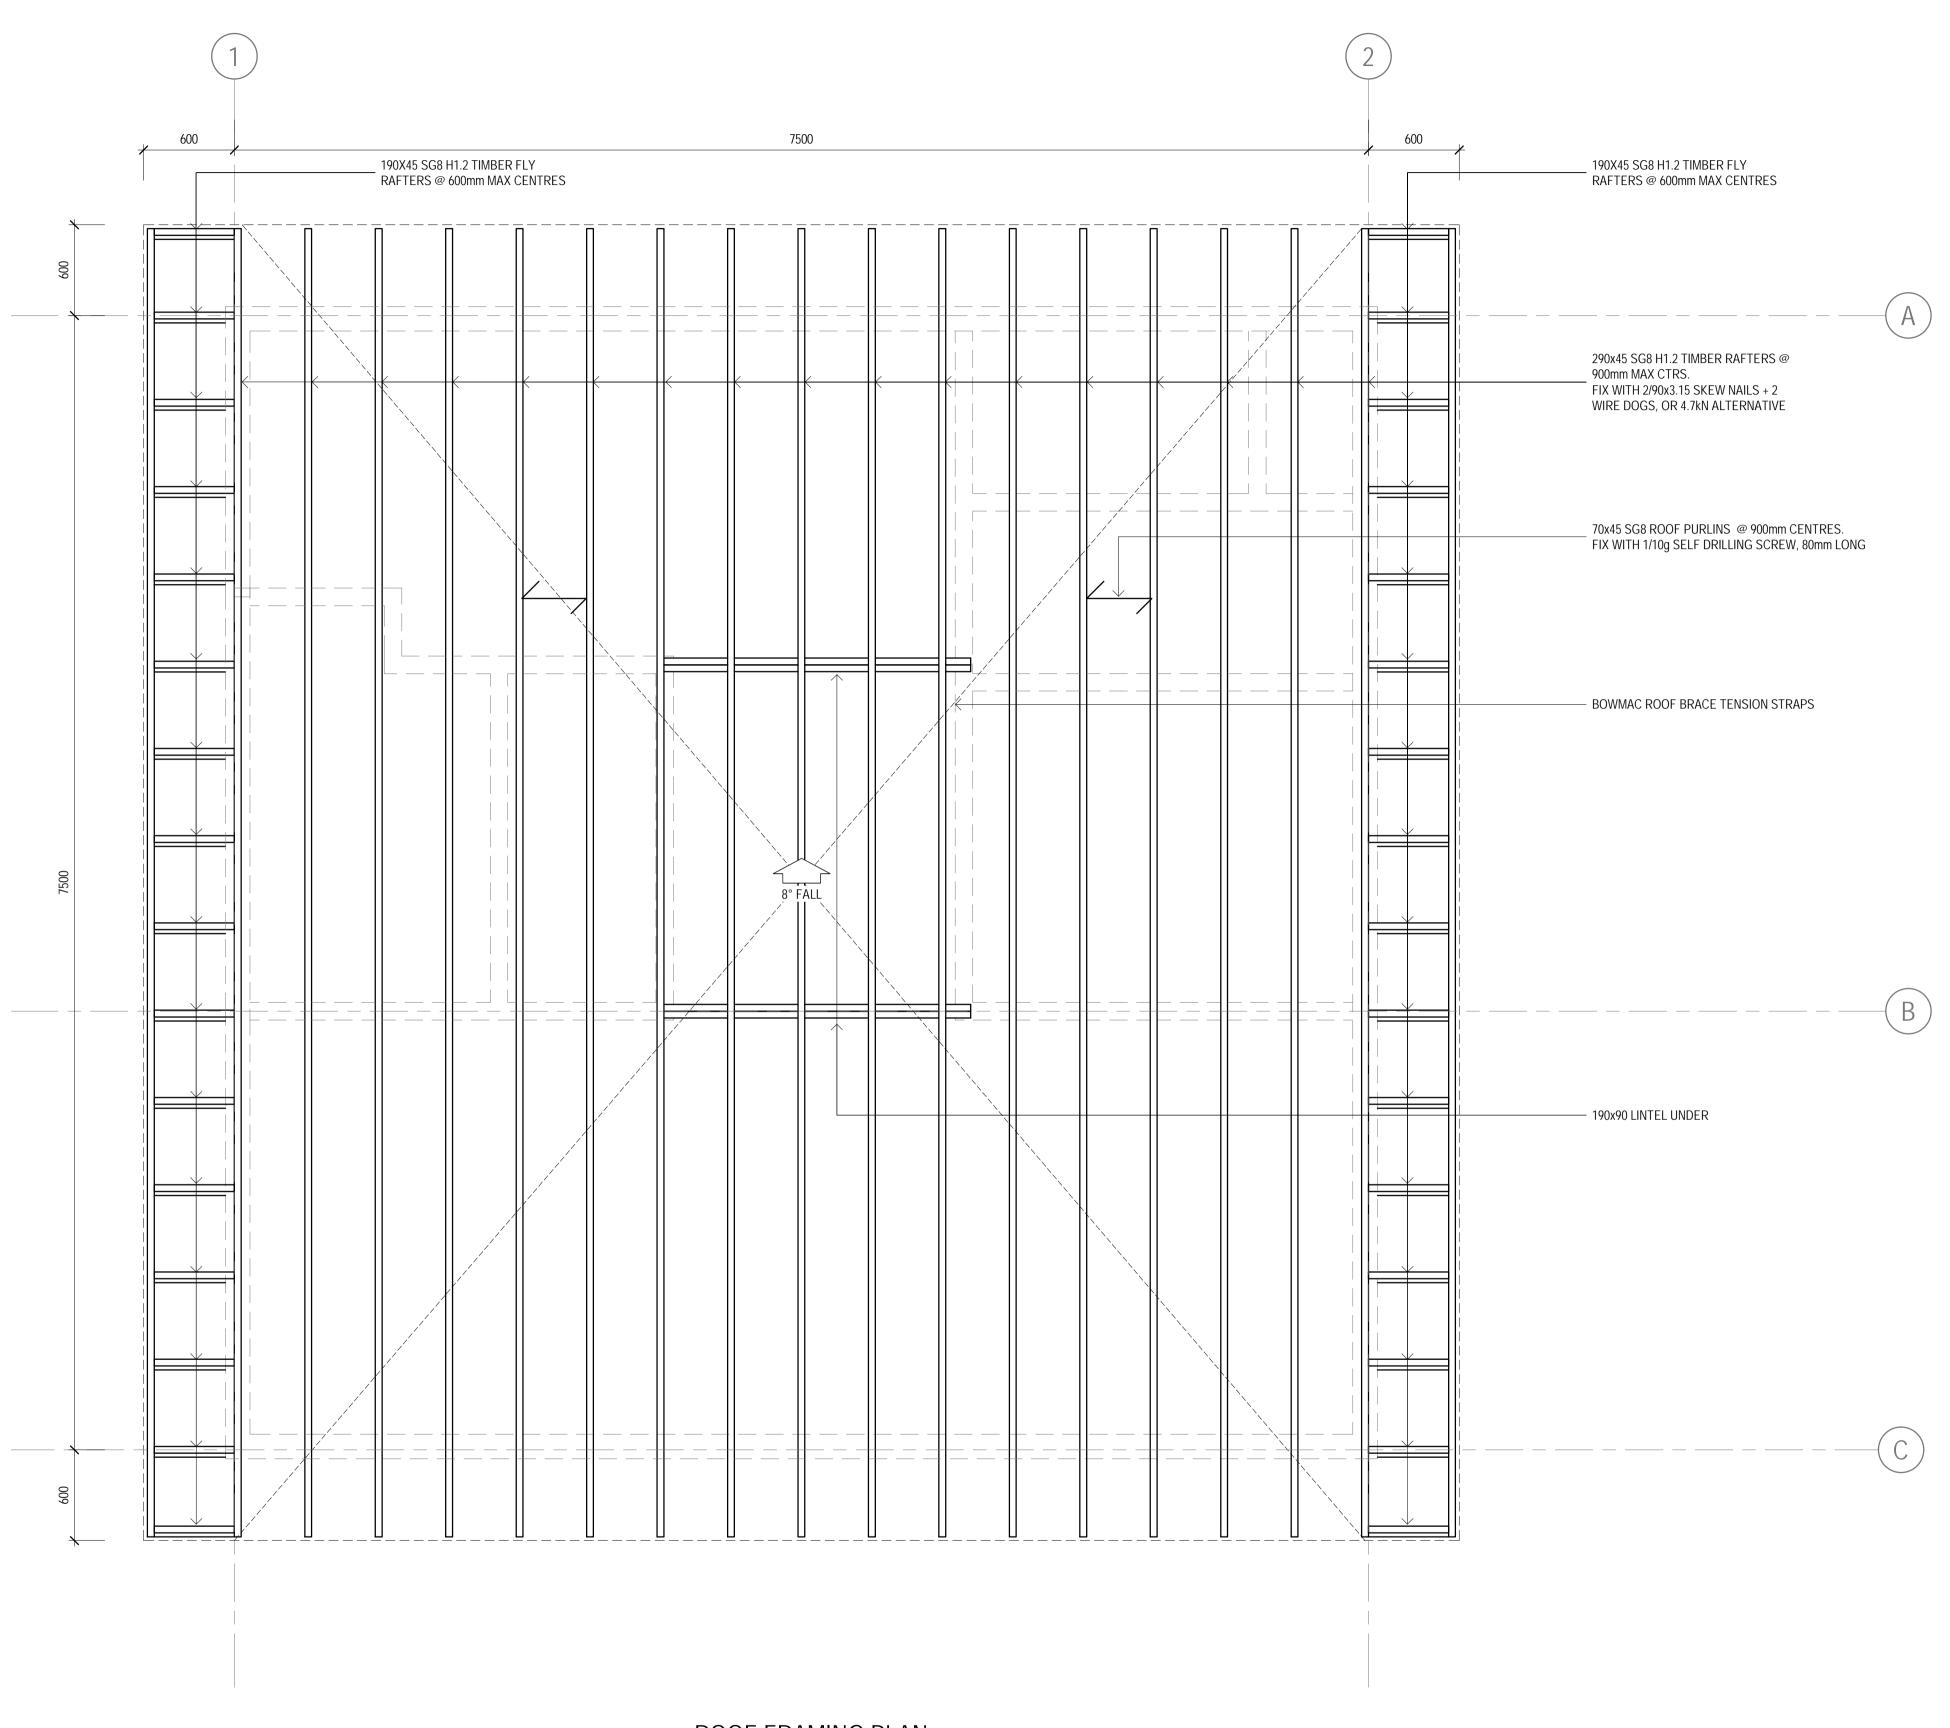

ROOF FRAMING PLAN
SCALE 1:25

TENDER / CONSENT

 1 CONSENT ISSUE
 05.07.19

 No Revision
 Drawn Date

250 500 750 1000 1250mm SCALE 1: 25 AT ORIGINAL SIZE

GHDWOODHEAD creativespaces


Level 1, Grant Thornton House 215 Lambton Quay, Wellington New Zealand T 64 4 472 0799 F 64 4 472 0833 E wgtnmail@ghd.com **W** www.ghd.com Conditions of Use.
This document may only be used by
GHD's client (and any other person who
GHD has agreed can use this document)
for the purpose for which it was prepared
and must not be used by any other
person or for any other purpose.

DO NOT SCALE
Scale 1:25

Client NEW ZEALAND TRANSPORT AGENCY
Project TIER 1.5 - CONTROL BUILDING

ARCHITECTURAL WORKS
ROOF FRAMING PLAN

Original Size
A1 Drawing No: 51-34037-A122

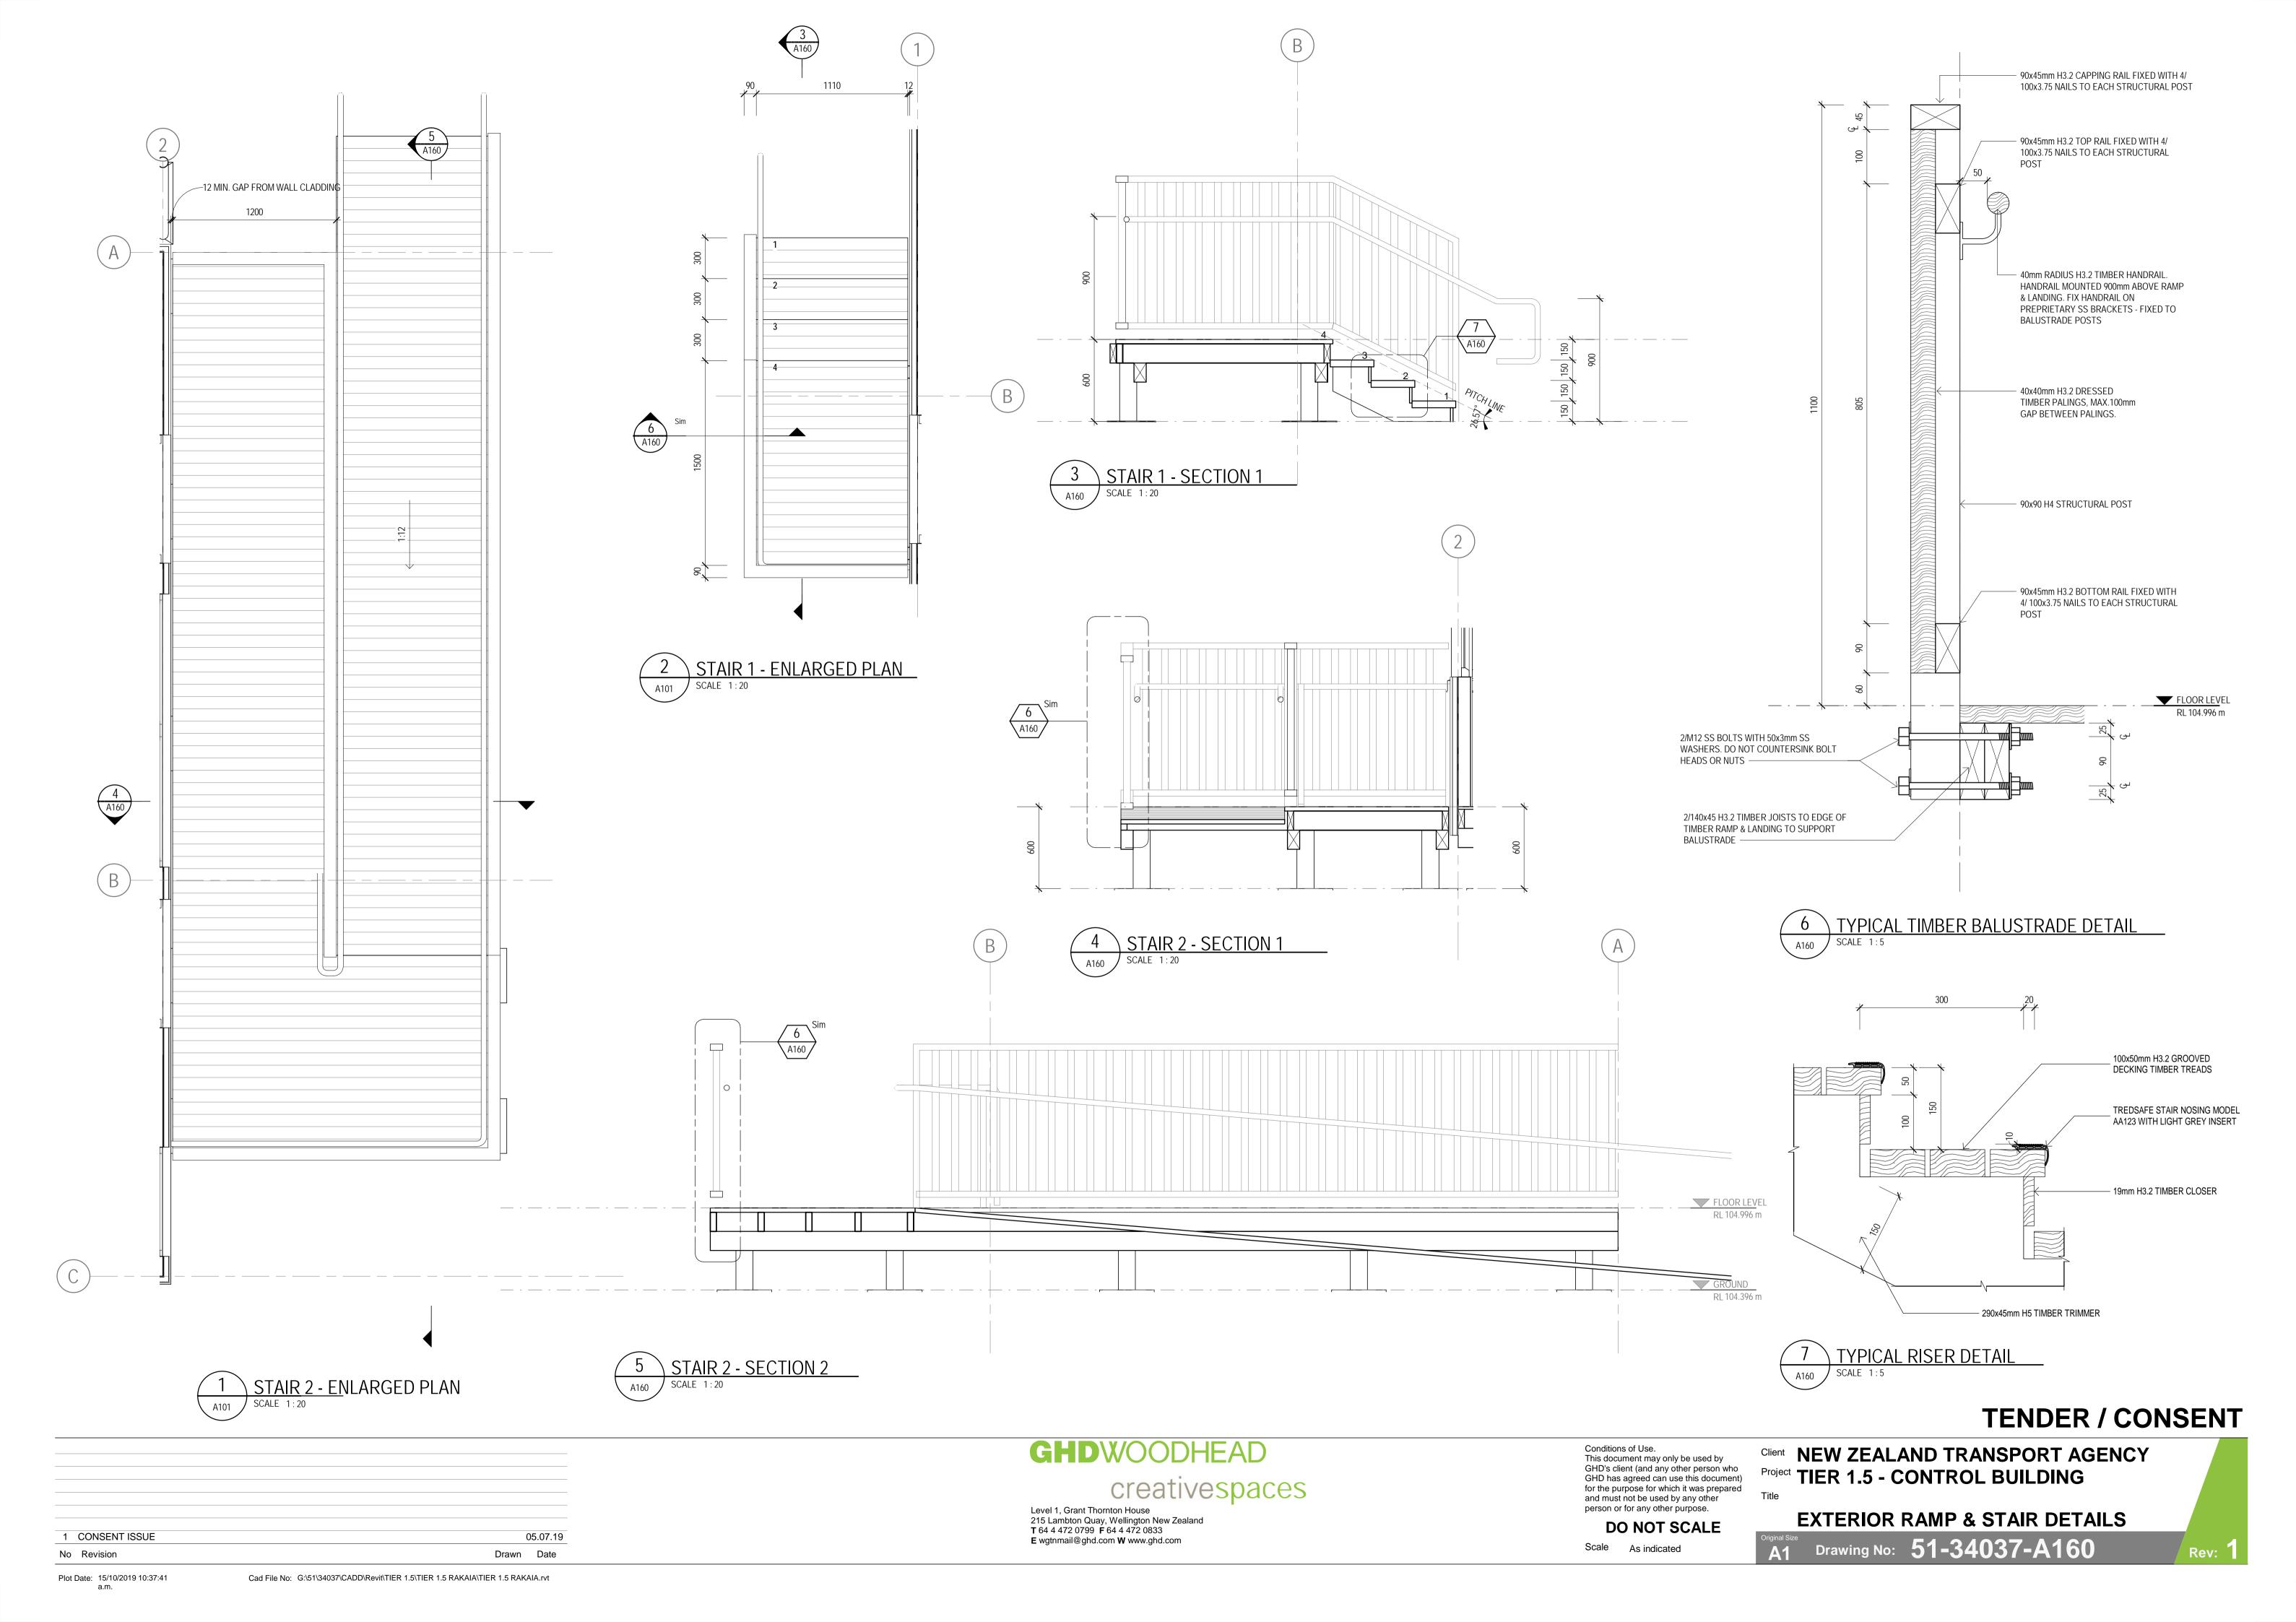





FRONT ELEVATION

15.10.19

05.07.19

18.01.19

NW WIP

250 500 750 1000 1250mm



GHDWOODHEAD creativespaces

Level 1, Grant Thornton House 215 Lambton Quay, Wellington New Zealand **T** 64 4 472 0799 **F** 64 4 472 0833 **E** wgtnmail@ghd.com **W** www.ghd.com

DO NOT SCALE GHDWOODHEAD is a trading name of GHD Pty Ltd. Conditions of Use. This document may only be used by

GHD's client (and any other person who GHD has agreed can use this document) Date for the purpose for which it was prepared and must not be used by any other person or for any other purpose.

Drawn R.WURSTER Designer D.ANGUS Drafting Check Approved (Project Director) This Drawing must not be As indicated used for Construction unless

signed as Approved

Client NEW ZEALAND TRANSPORT AGENCY Project TIER 1.5 - CONTROL BUILDING

Title ARCHITECTURAL WORKS **EXTERIOR ELEVATIONS**

Drawing No: 51-34037-A200

WALL TYPE LEGEND

CORRUGATED HORIZONTAL CLADDING

• 90mm TIMBER FRAMING - STUDS @

 7mm ECOPLY RAB - SCREW FIXED 45x21 H3.2 TIMBER CAVITY BATTENS CORRUGATED PROFILE CLADDING

CORRUGATED HORIZONTAL CLADDING 13mm STANDARD PLASTERBOARD INTERIOR LINING - L4 FINISH 90mm TIMBER FRAMING - STUDS @

 2mm GAUGED STEEL SHEET INSTALLED TO INSIDE FACE OF WALL FRAMING

 7mm ECOPLY RAB - SCREW FIXED 45x21 H3.2 TIMBER CAVITY BATTENS CORRUGATED PROFILE CLADDING JAMES HARDIE HARDIEFLEX PANEL 13mm STANDARD PLASTERBOARD

INTERIOR LINING - L4 FINISH 90mm TIMBER FRAMING - STUDS @

 7mm ECOPLY RAB - SCREW FIXED 45x21 H3.2 TIMBER CAVITY BATTENS JAMES HARDIE HARDIEFLEX SHEET

90mm TIMBER FRAMING - STUDS @

90mm TIMBER FRAMING - STUDS @

 2mm GAUGED STEEL SHEET INSTALLED TO NZP ICT ROOM FACE OF WALL

13mm GIB PLASTERBOARD BOTH SIDES

L4 FINISH - REFER TO BRACING PLAN

FOR LOCATION BRACING UNITS

 DIMOND CORRUGATE 0.55mm ROOFING COLORSTEEL MAXX FINISH - COLOUR

70x45mm H3.2 TIMBER PURLINS @ 900mm

 290x45mm H1.2 TIMBER RAFTERS AT 480mm CTRS NOTCHED AT SOFFIT

• DIMOND BOX 125 GUTTER PROFILE COLORSTEEL MAXX FINISH - COLOUR

 13mm GIB PLASTERBOARD BOTH SIDES L4 FINISH - REFER TO BRACING PLAN FOR LOCATION BRACING UNITS

400mm CENTRES R2.8 ULTRA WALL BATTS

INTERIOR TIMBER WALL

600mm CENTRES

INTERIOR TIMBER WALL

600mm CENTRES

FRAMING

ROOF LEGEND

RF01 DIMOND CORRUGATE

'GREY FRIARS' ROOF UNDERLAY

GU01 STEEL GUTTER - 125 BOX

DP01 100mmØ DOWN PIPE

SERVICE PENETRATIONS.

SPECIFICATION FOR DETAILS.

ROOF NOTES

DISCHARGE.

'GREY FRIARS'

1. ALL OTHER RAINWATER GOODS, FIXINGS AND

2. REFER TO SERVICES DRAWINGS FOR ALL ROOF

3. ALL ROOF PENETRATIONS TO BE APPROPRIATELY FLASHED/SEALED TO RIDGE LINE, REFER TO

4. CONNECT ALL NEW RAINWATER DOWNPIPES TO

TENDER / CONSENT

STORM WATER RETICULATION AND LEGAL POINT OF

SEALANTS TO MATCH ROOF SHEETING.

DIMOND 0.55mm STEEL
 FINISH TO MATCH ROOFING

CTRS FIXED ON FLAT

CLADDING

INTERIOR LINING - L4 FINISH

13mm STANDARD PLASTERBOARD

400mm CENTRES R2.8 ULTRA WALL BATTS

400mm CENTRES

R2.8 ULTRA WALL BATTS

WALL TYPES:

2 REVISED FOR CONSENT

1 CONSENT ISSUE

B CLIENT REVIEW


A CLIENT REVIEW



SIDE ELEVATION 2



REAR ELEVATION
SCALE 1:25

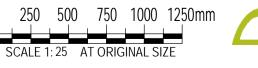



GHDWOODHEAD creativespaces

Level 1, Grant Thornton House 215 Lambton Quay, Wellington New Zealand **T** 64 4 472 0799 **F** 64 4 472 0833 E wgtnmail@ghd.com W www.ghd.com

DO NOT SCALE

GHDWOODHEAD is a trading name of GHD Pty Ltd.
Conditions of Use.
This document may only be used by

Drawn R.WURSTER Designer D.ANGUS Drafting Check Design Checker Check Approved Approver (Project Director)

Client NEW ZEALAND TRANSPORT AGENCY

Project TIER 1.5 - CONTROL BUILDING

Drawing No: 51-34037-A201

TENDER / CONSENT

05.07.19

1 CONSENT ISSUE

 45x21 H3.2 TIMBER CAVITY BATTENS CORRUGATED PROFILE CLADDING

WALL TYPE LEGEND

WALL TYPES:

INTERIOR LINING - L4 FINISH • 90mm TIMBER FRAMING - STUDS @ 400mm CENTRES

WT01 CORRUGATED HORIZONTAL CLADDING 13mm STANDARD PLASTERBOARD

> R2.8 ULTRA WALL BATTS 7mm ECOPLY RAB - SCREW FIXED

CORRUGATED HORIZONTAL CLADDING

 13mm STANDARD PLASTERBOARD INTERIOR LINING - L4 FINISH

90mm TIMBER FRAMING - STUDS @

400mm CENTRES 2mm GAUGED STEEL SHEET INSTALLED

TO INSIDE FACE OF WALL FRAMING

 R2.8 ULTRA WALL BATTS 7mm ECOPLY RAB - SCREW FIXED

 45x21 H3.2 TIMBER CAVITY BATTENS CORRUGATED PROFILE CLADDING

JAMES HARDIE HARDIEFLEX PANEL

WT03 13mm STANDARD PLASTERBOARD

INTERIOR LINING - L4 FINISH 90mm TIMBER FRAMING - STUDS @

400mm CENTRES

 R2.8 ULTRA WALL BATTS 7mm ECOPLY RAB - SCREW FIXED

 45x21 H3.2 TIMBER CAVITY BATTENS JAMES HARDIE HARDIEFLEX SHEET

INTERIOR TIMBER WALL

CLADDING

 90mm TIMBER FRAMING - STUDS @ 600mm CENTRES 13mm GIB PLASTERBOARD BOTH SIDES

L4 FINISH - REFER TO BRACING PLAN FOR LOCATION BRACING UNITS

INTERIOR TIMBER WALL 90mm TIMBER FRAMING - STUDS @

600mm CENTRES 2mm GAUGED STEEL SHEET INSTALLED

TO NZP ICT ROOM FACE OF WALL FRAMING

 13mm GIB PLASTERBOARD BOTH SIDES L4 FINISH - REFER TO BRACING PLAN FOR LOCATION BRACING UNITS

ROOF LEGEND

RF01 DIMOND CORRUGATE

 DIMOND CORRUGATE 0.55mm ROOFING COLORSTEEL MAXX FINISH - COLOUR

'GREY FRIARS' ROOF UNDERLAY

 70x45mm H3.2 TIMBER PURLINS @ 900mm CTRS FIXED ON FLAT

 290x45mm H1.2 TIMBER RAFTERS AT 480mm CTRS NOTCHED AT SOFFIT

GU01 STEEL GUTTER - 125 BOX
DIMOND BOX 125 GUTTER PROFILE

 COLORSTEEL MAXX FINISH - COLOUR 'GREY FRIARS'

DP01 100mmØ DOWN PIPE DIMOND 0.55mm STEEL

 FINISH TO MATCH ROOFING **ROOF NOTES**

1. ALL OTHER RAINWATER GOODS, FIXINGS AND


SEALANTS TO MATCH ROOF SHEETING. 2. REFER TO SERVICES DRAWINGS FOR ALL ROOF


SERVICE PENETRATIONS.

3. ALL ROOF PENETRATIONS TO BE APPROPRIATELY FLASHED/SEALED TO RIDGE LINE, REFER TO SPECIFICATION FOR DETAILS.

4. CONNECT ALL NEW RAINWATER DOWNPIPES TO STORM WATER RETICULATION AND LEGAL POINT OF

EXTERIOR ELEVATIONS GHD's client (and any other person who GHD has agreed can use this document) Date for the purpose for which it was prepared This Drawing must not be As indicated used for Construction unless and must not be used by any other person or for any other purpose. signed as Approved

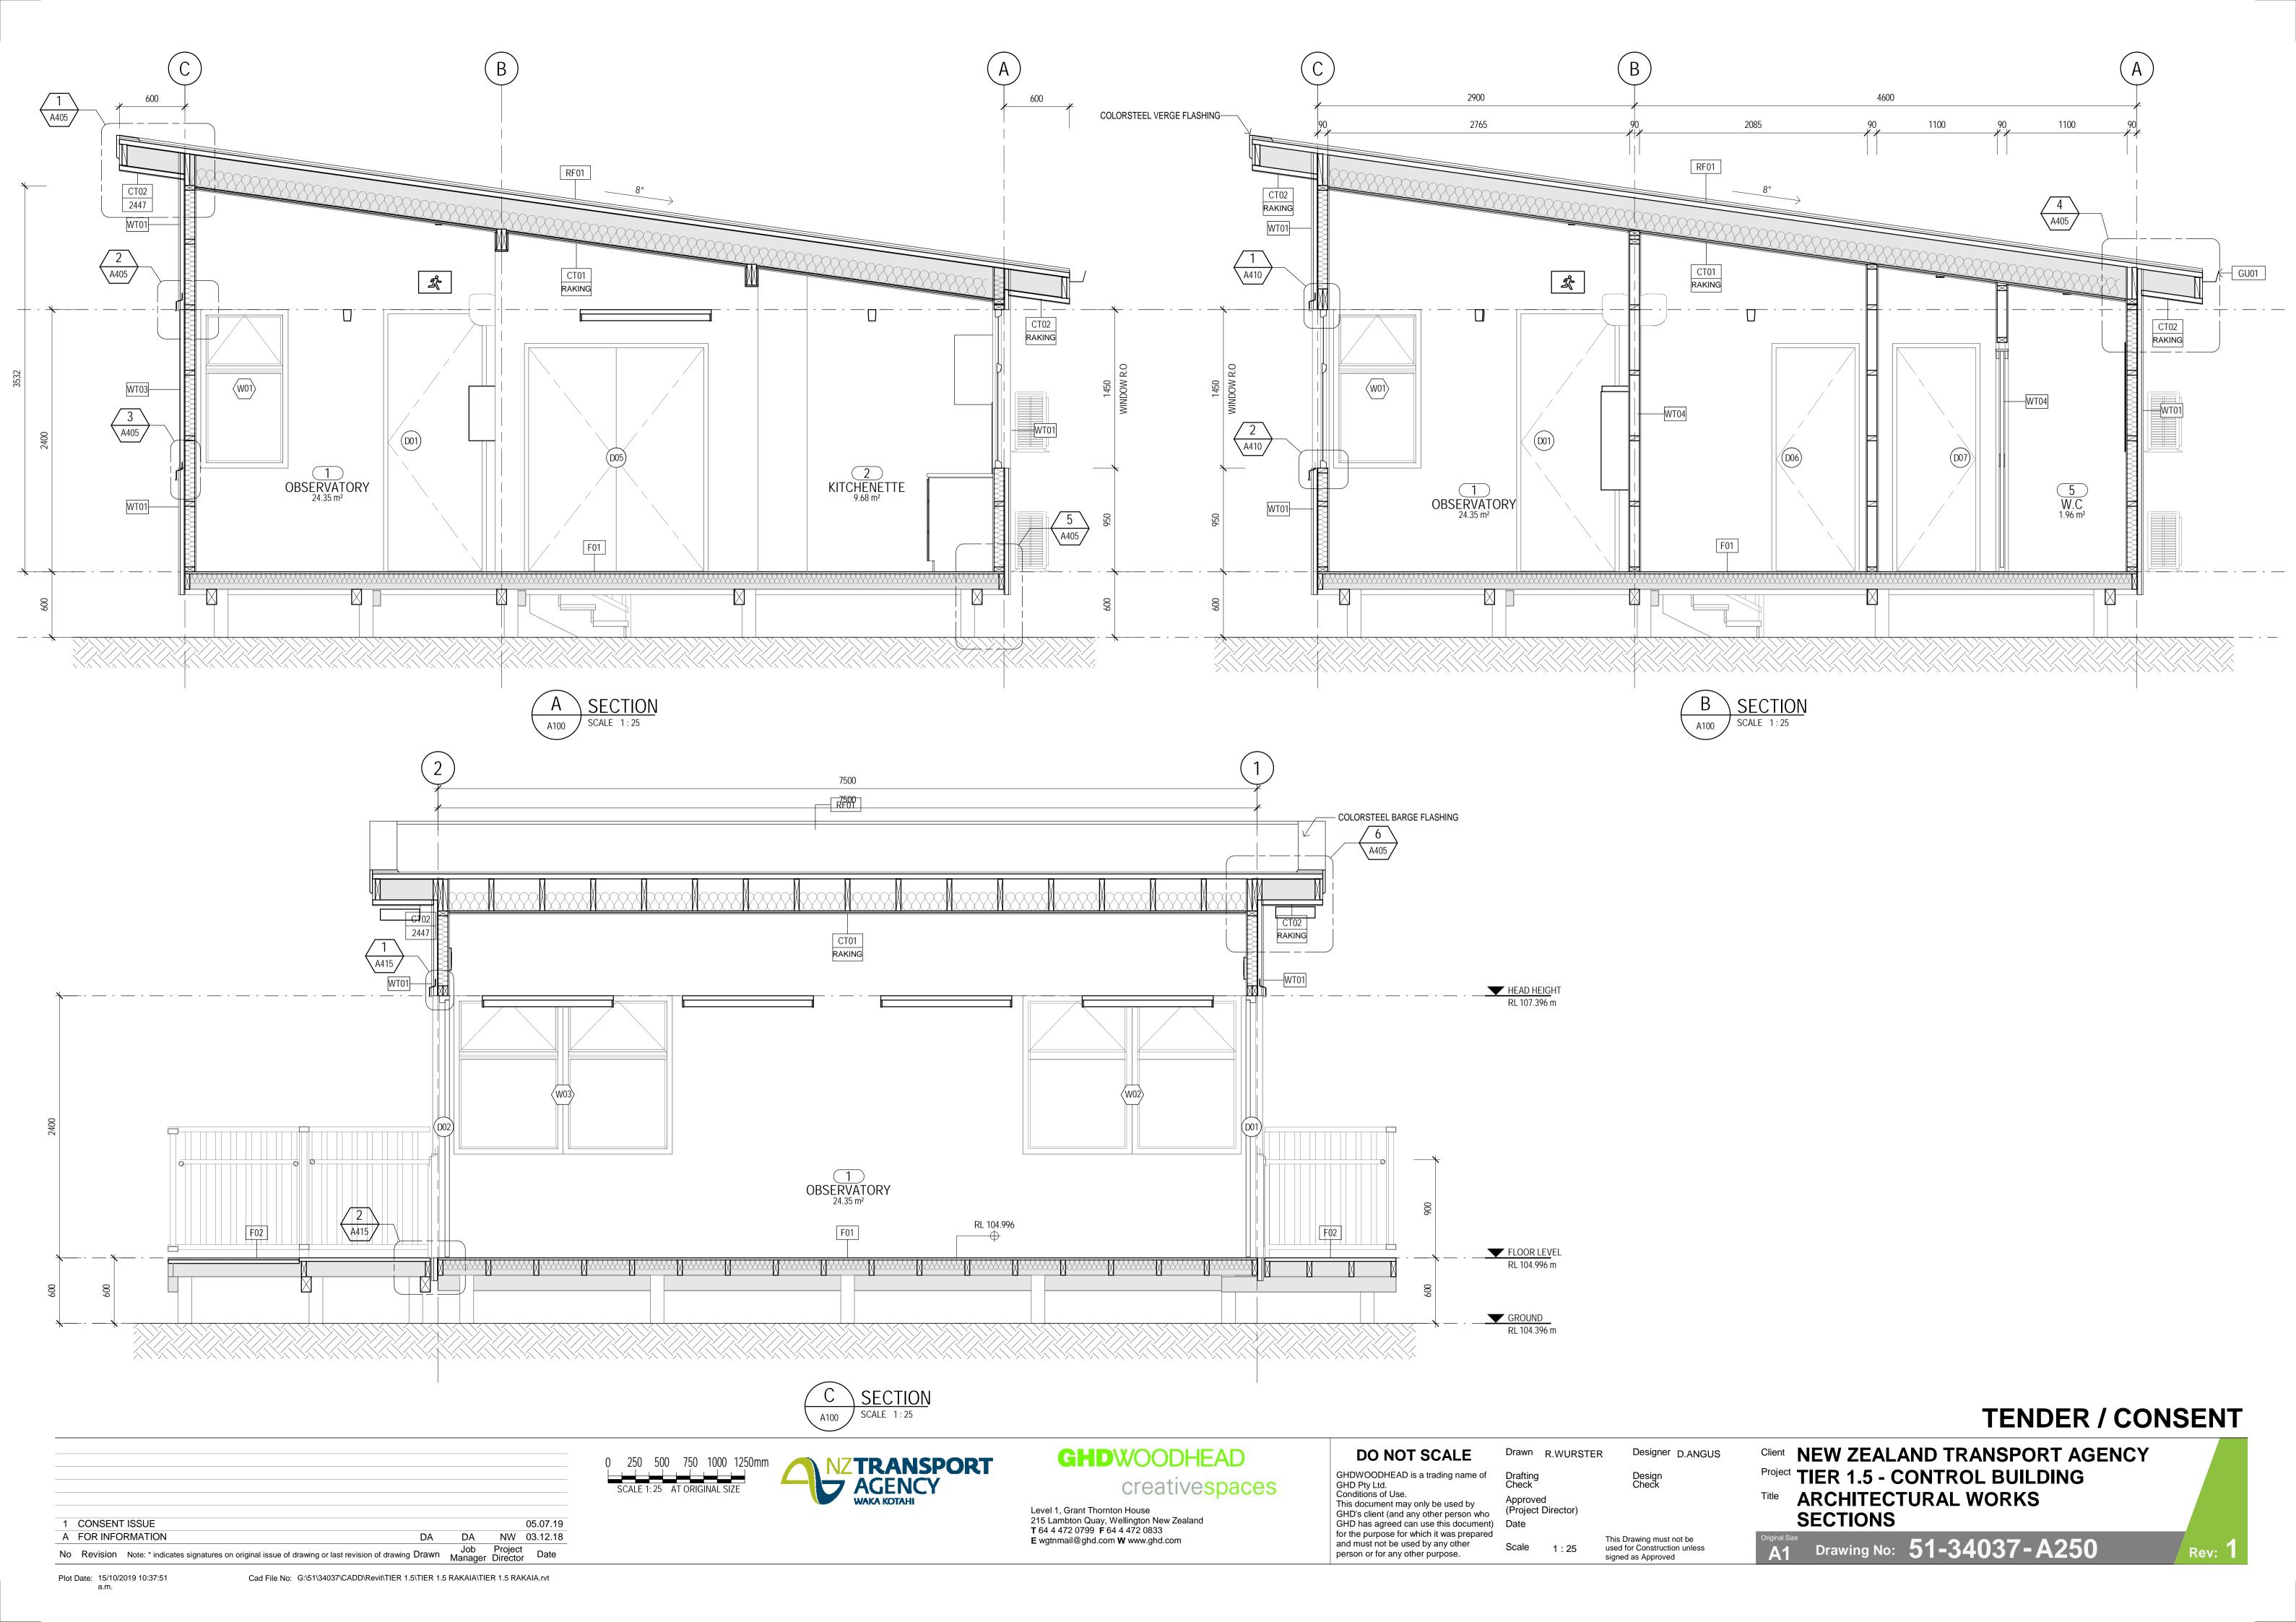

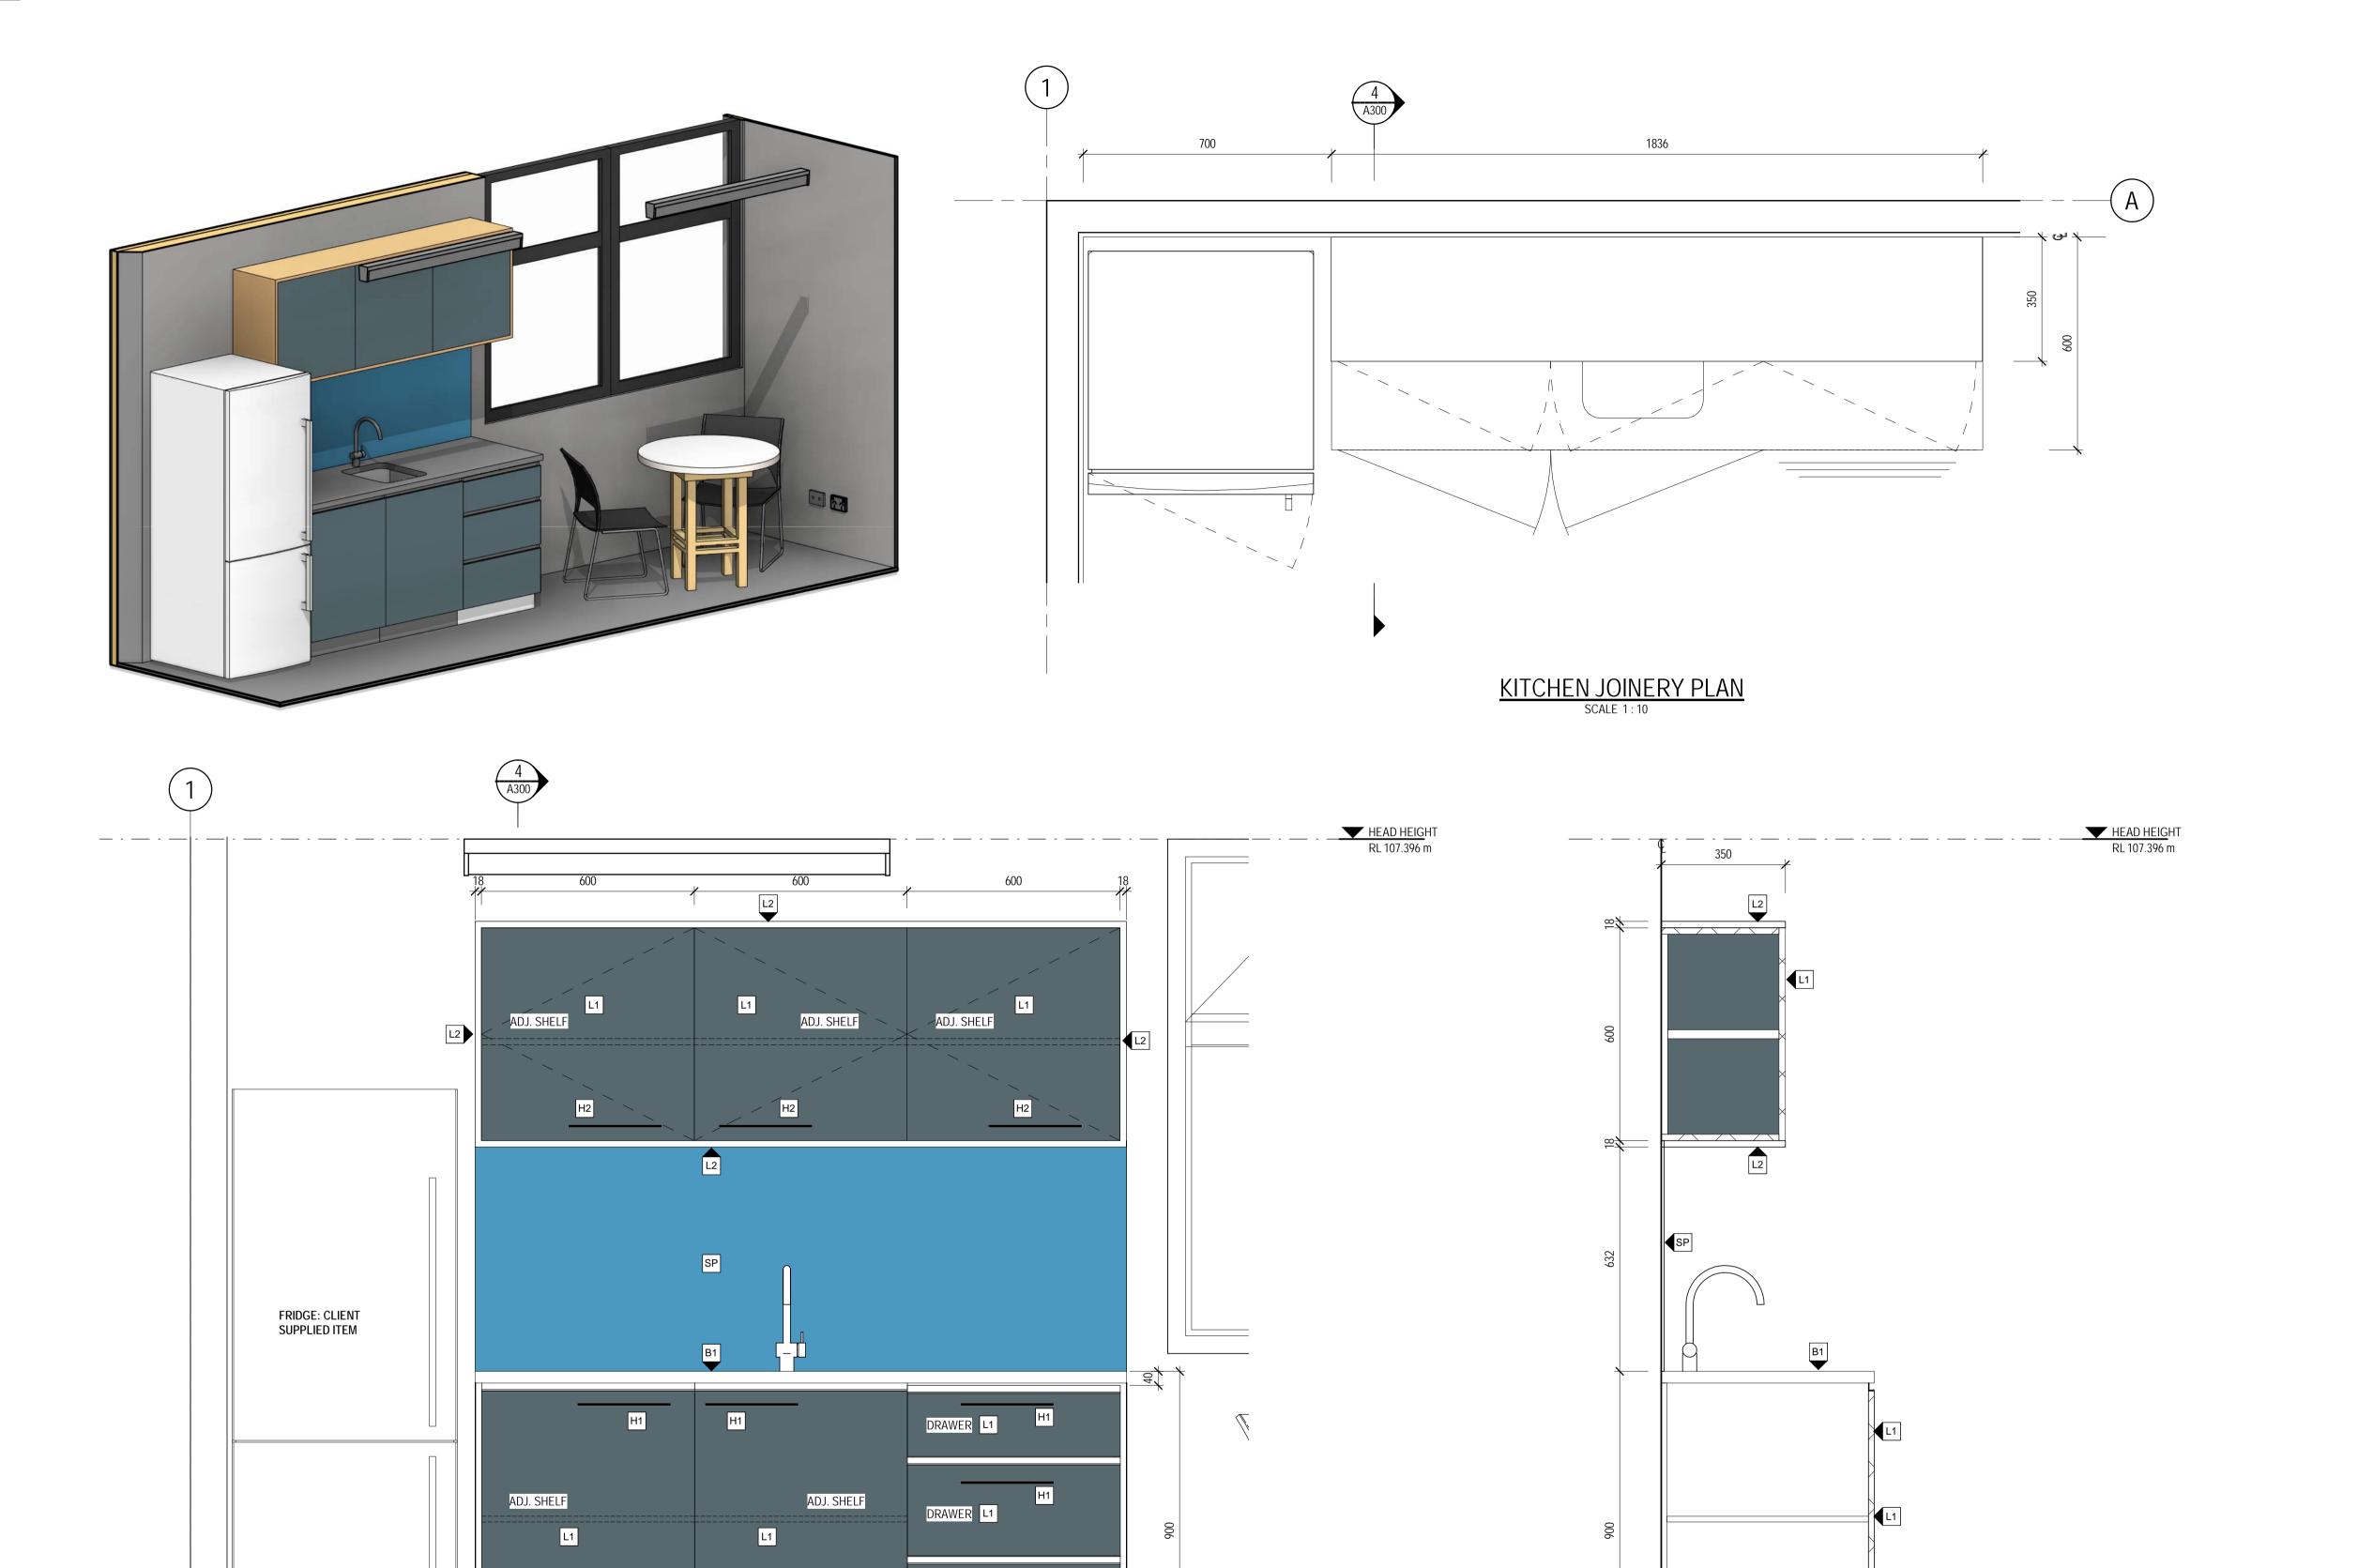

KITCHEN JOINERY - SECTION

TENDER / CONSENT

1 CONSENT ISSUE NW 05.07.19 No Revision Note: * indicates signatures on original issue of drawing or last revision of drawing Drawn Job Project Date

NZTRANSPORT AGENCY WAKA KOTAHI 100 200 300 400 500 mm

600

DRAWER L1

K1

600

1836

GHDWOODHEAD creativespaces

Level 1, Grant Thornton House 215 Lambton Quay, Wellington New Zealand **T** 64 4 472 0799 **F** 64 4 472 0833 E wgtnmail@ghd.com W www.ghd.com

DO NOT SCALE

600

GHDWOODHEAD is a trading name of GHD Pty Ltd.
Conditions of Use.
This document may only be used by GHD's client (and any other person who GHD has agreed can use this document) Date for the purpose for which it was prepared and must not be used by any other person or for any other purpose.

Drawn R.WURSTER Designer D.ANGUS Drafting Check Approved (Project Director)

This Drawing must not be
As indicated used for Construction unless signed as Approved

FLOOR LEVEL RL 104.996 m

Client NEW ZEALAND TRANSPORT AGENCY Project TIER 1.5 - CONTROL BUILDING

NOTES

GENERAL:

clearances etc.

commencing.

width/weight

accurate fit.

CARCASES:

DRAWER RUNNERS

It is the joiners responsibility to setout and build in all kitchen

appliances. Appliances are to be fitted in accordance with the manufacturers recommendations with all venting spaces,

All appliances shall be supplied by owner. Owner to confirm appliance models prior to kitchen joinery fabrication

All drawers to have full height sides and backs with soft closing system. Drawer slider tracks to be sized to suit drawer

Generally concealed HETTICH, Sensy or similar approved 130 degree throw out to standard carcass doors, with soft closing system. Full or half overlay as required to conceal carcass

Site measure prior to manufacturing of joinery, coordinate joinery with the setout of new and relocated appliances

All dimensions are to be checked on site, any discepencies are to be brought to designers attention. Units and tops are to be a neat fit between walls. Allow to template bench top to ensure an

Carcases are to be 18mm standard white Melteca in general. All carcases are to be clashed with 3mm PVC where not visible. Concealed shelves are to be 18mm white Melteca with 3mm pvc

JOINERY FINISH - TYPE 1
18mm MDF(MR) Bestwood Melamine, colour CARBON EMBOSSED

KP KICKPLATE - TYPE 1
Brushed stainless steel sheet mounted on 18mm MDF(MR)

integrate into Stainless Steel benchtop

H1 HANDLES - BASE CABINETS & DRAWERS
Mardecco Arezzo 4030, 264mm x 8.5mm Black

HANDLES - OVER HEAD CABINETS
Mardecco Arezzo 4030, 264mm x 8.5mm Black

MIXER TAP
Methven Minimalist goose neck sink mixer tap

SPLASHBACK

SP 10mm Tempered glass splashback Coloured -Resene Blumine

B1 KITCHEN BENCHTOPS - TYPE 1
Brushed Stainless steel benchtop on 36mm Meranti Plywood substrate

Burns & Ferrall BFD380R15 Single Bowl sink (Bowl size 380x400x200) allow to

JOINERY FINISH - TYPE 2
18mm MDF (MR) Bestwood Melamine - colour RANFURLY OAK, WILDERNESS

all sides except where noted otherwise.


CABINETRY FINISHES


Title ARCHITECTURAL WORKS **KITCHEN JOINERY SETOUT**

Drawing No: 51-34037-A300

KITCHEN JOINERY - FRONT ELEVATION

600

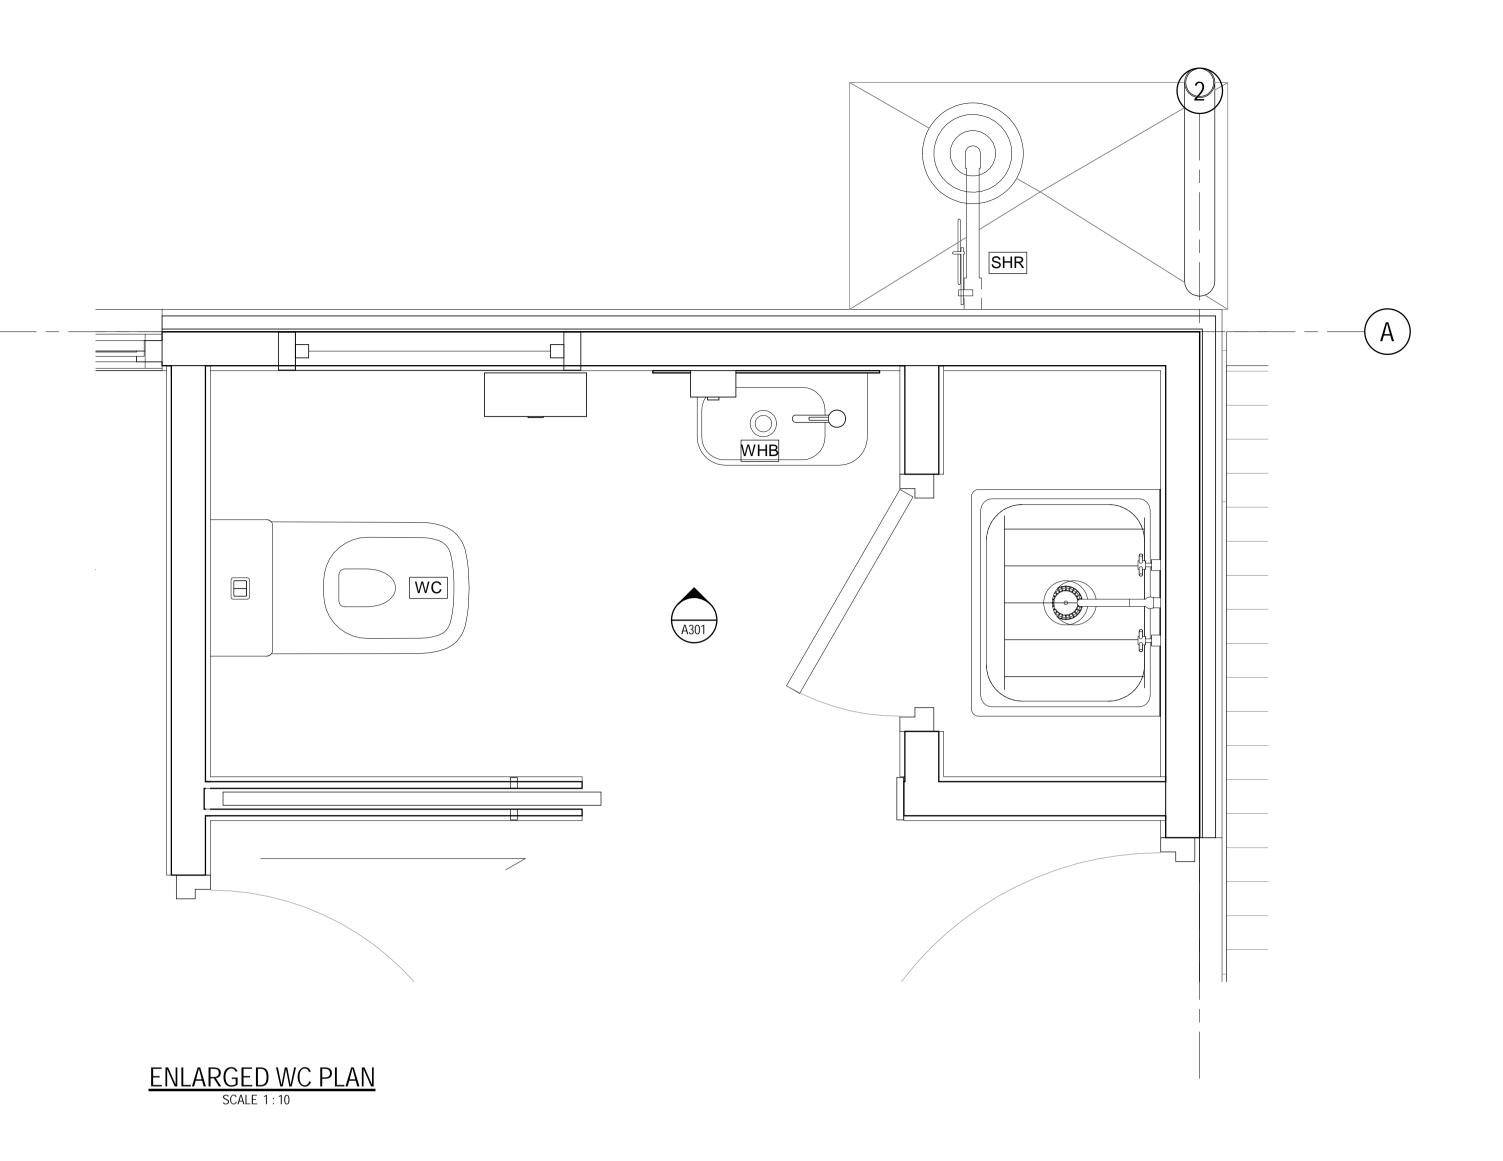

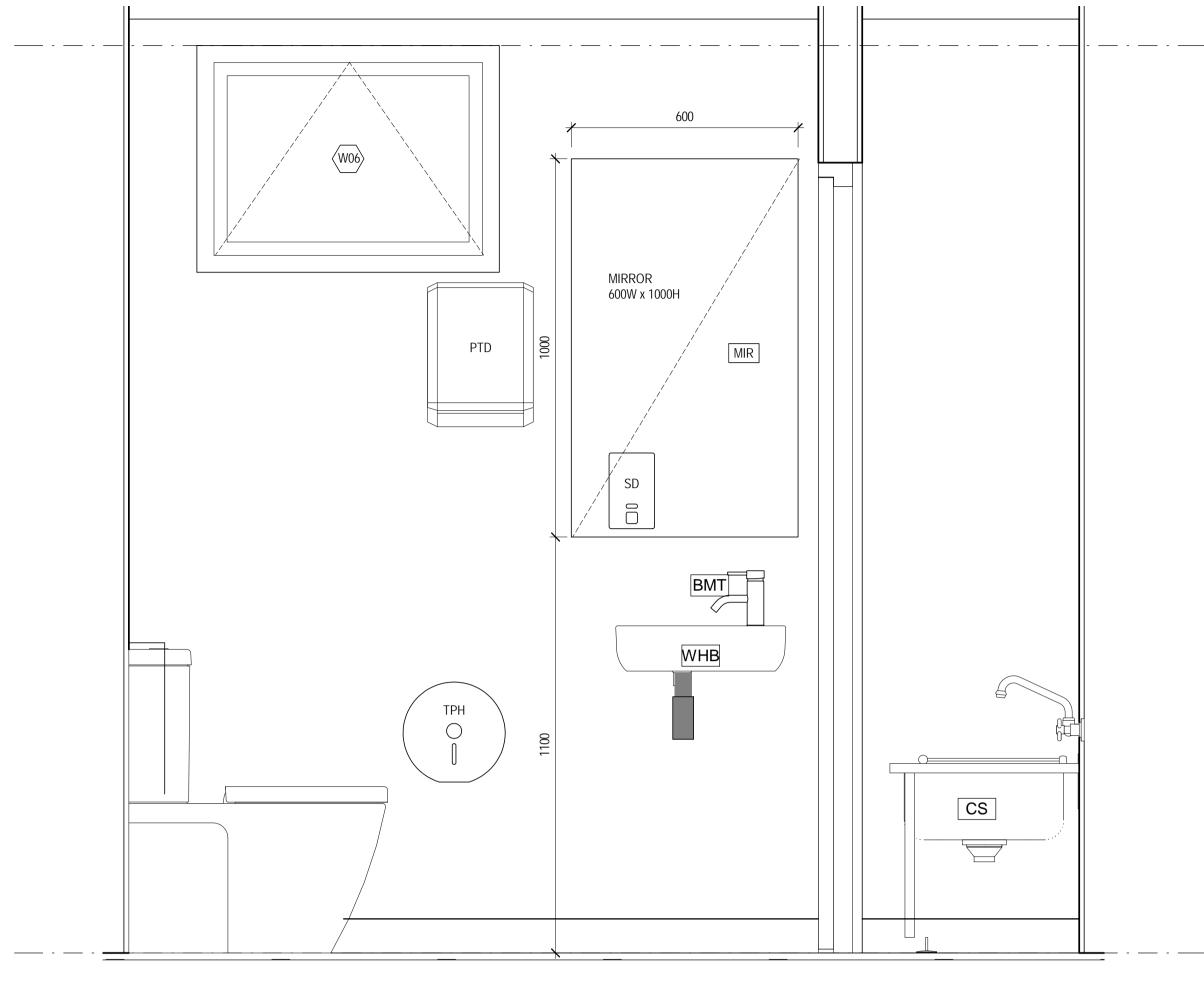

WC ELEVATION SCALE 1:10


BATHROOM FIXTURES:

- WC PAN: CAROMA CUBE WALL FACED TOILET SUITE WITH SOFT CLOSE SEAT, PRODUCT CODE: 824615W
- WHB BASIN: CAROMA LUNA HAND WALL BASIN, BLACK BOTTLE TRAP
- BMT BASIN MIXER: CAROMA LIANO BASIN MIXER
- CS CLEANERS SINK: FRANKE SS CLEANERS SINK WITH SPLASHBACK AND BUCKET GRID. CODE: FRCS **CLEANERS SINK TAPWARE**: ZURN SINK FAUCET FOR CLEANERS SINK, MODEL: ZURN Z-SF
- SHR EXTERIOR SHOWER: SPEAKMAN LIFESAVER WALL MOUNTED EXTERIOR EMERGENCY SHOWER HEAD WITH PULL DOWN ARM

BATHROOM ACCESSORIES

- MIRROR: 1000mmH x 600mmW FRAMLESS MIRROR GLUE FIXED TO WALL SURFACE
- **TOILET ROLL HOLDER**: SINGLE JUMBO DISPENSER RESERVE, LIVI-COTTONSOFT
- SOAP DISPENSER: ASI SURFACE MOUNTED VERTICAL SOAP DISPENSER
- PTD PAPER TOWEL DISPENSER: AS1 SURFACE MOUNTED PAPER TOWEL DISPENSER

TENDER / CONSENT

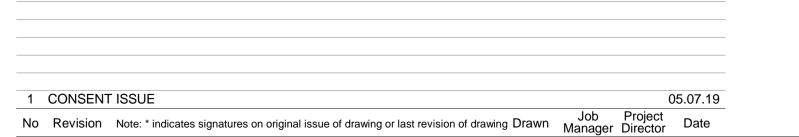



GHDWOODHEAD creativespaces

Level 1, Grant Thornton House 215 Lambton Quay, Wellington New Zealand **T** 64 4 472 0799 **F** 64 4 472 0833 E wgtnmail@ghd.com W www.ghd.com

DO NOT SCALE

GHDWOODHEAD is a trading name of GHD Pty Ltd.
Conditions of Use.
This document may only be used by GHD's client (and any other person who GHD has agreed can use this document)

for the purpose for which it was prepared. for the purpose for which it was prepared and must not be used by any other


person or for any other purpose.

Designer Designer Drawn Author Drafting Check Design Checker Check Approved (Project Director) Approver


This Drawing must not be As indicated used for Construction unless signed as Approved

Client NEW ZEALAND TRANSPORT AGENCY Project TIER 1.5 - CONTROL BUILDING

WC ELEVATIONS

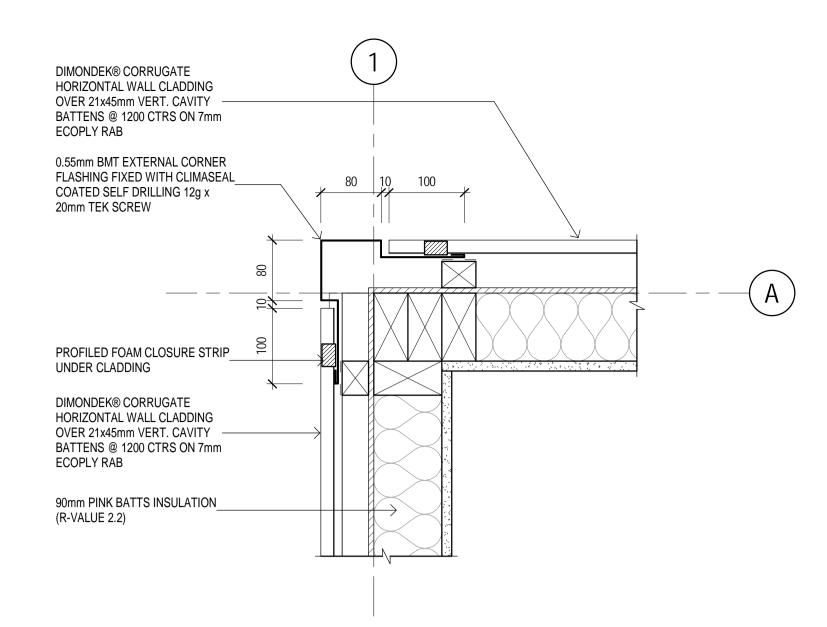


CORRUGATE CLADDING EXTERNAL CORNER

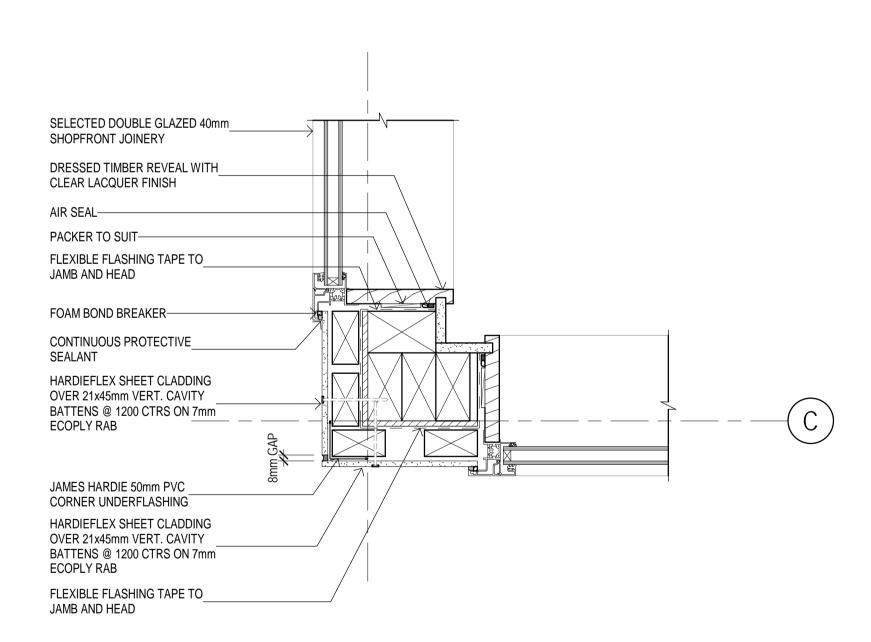



TENDER / CONSENT

1 CONSENT ISSUE NW 05.07.19 No Revision Note: * indicates signatures on original issue of drawing or last revision of drawing Drawn Job Project Manager Director Date

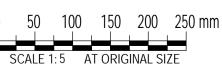



GHDWOODHEAD creativespaces

Level 1, Grant Thornton House 215 Lambton Quay, Wellington New Zealand **T** 64 4 472 0799 **F** 64 4 472 0833 E wgtnmail@ghd.com W www.ghd.com


DO NOT SCALE GHDWOODHEAD is a trading name of GHD Pty Ltd. Conditions of Use. This document may only be used by


GHD's client (and any other person who GHD has agreed can use this document) Date for the purpose for which it was prepared and must not be used by any other person or for any other purpose.


Designer D.ANGUS Drawn R.WURSTER Drafting Check Approved (Project Director)

This Drawing must not be used for Construction unless signed as Approved

Client NEW ZEALAND TRANSPORT AGENCY Project TIER 1.5 - CONTROL BUILDING Title ARCHITECTURAL WORKS

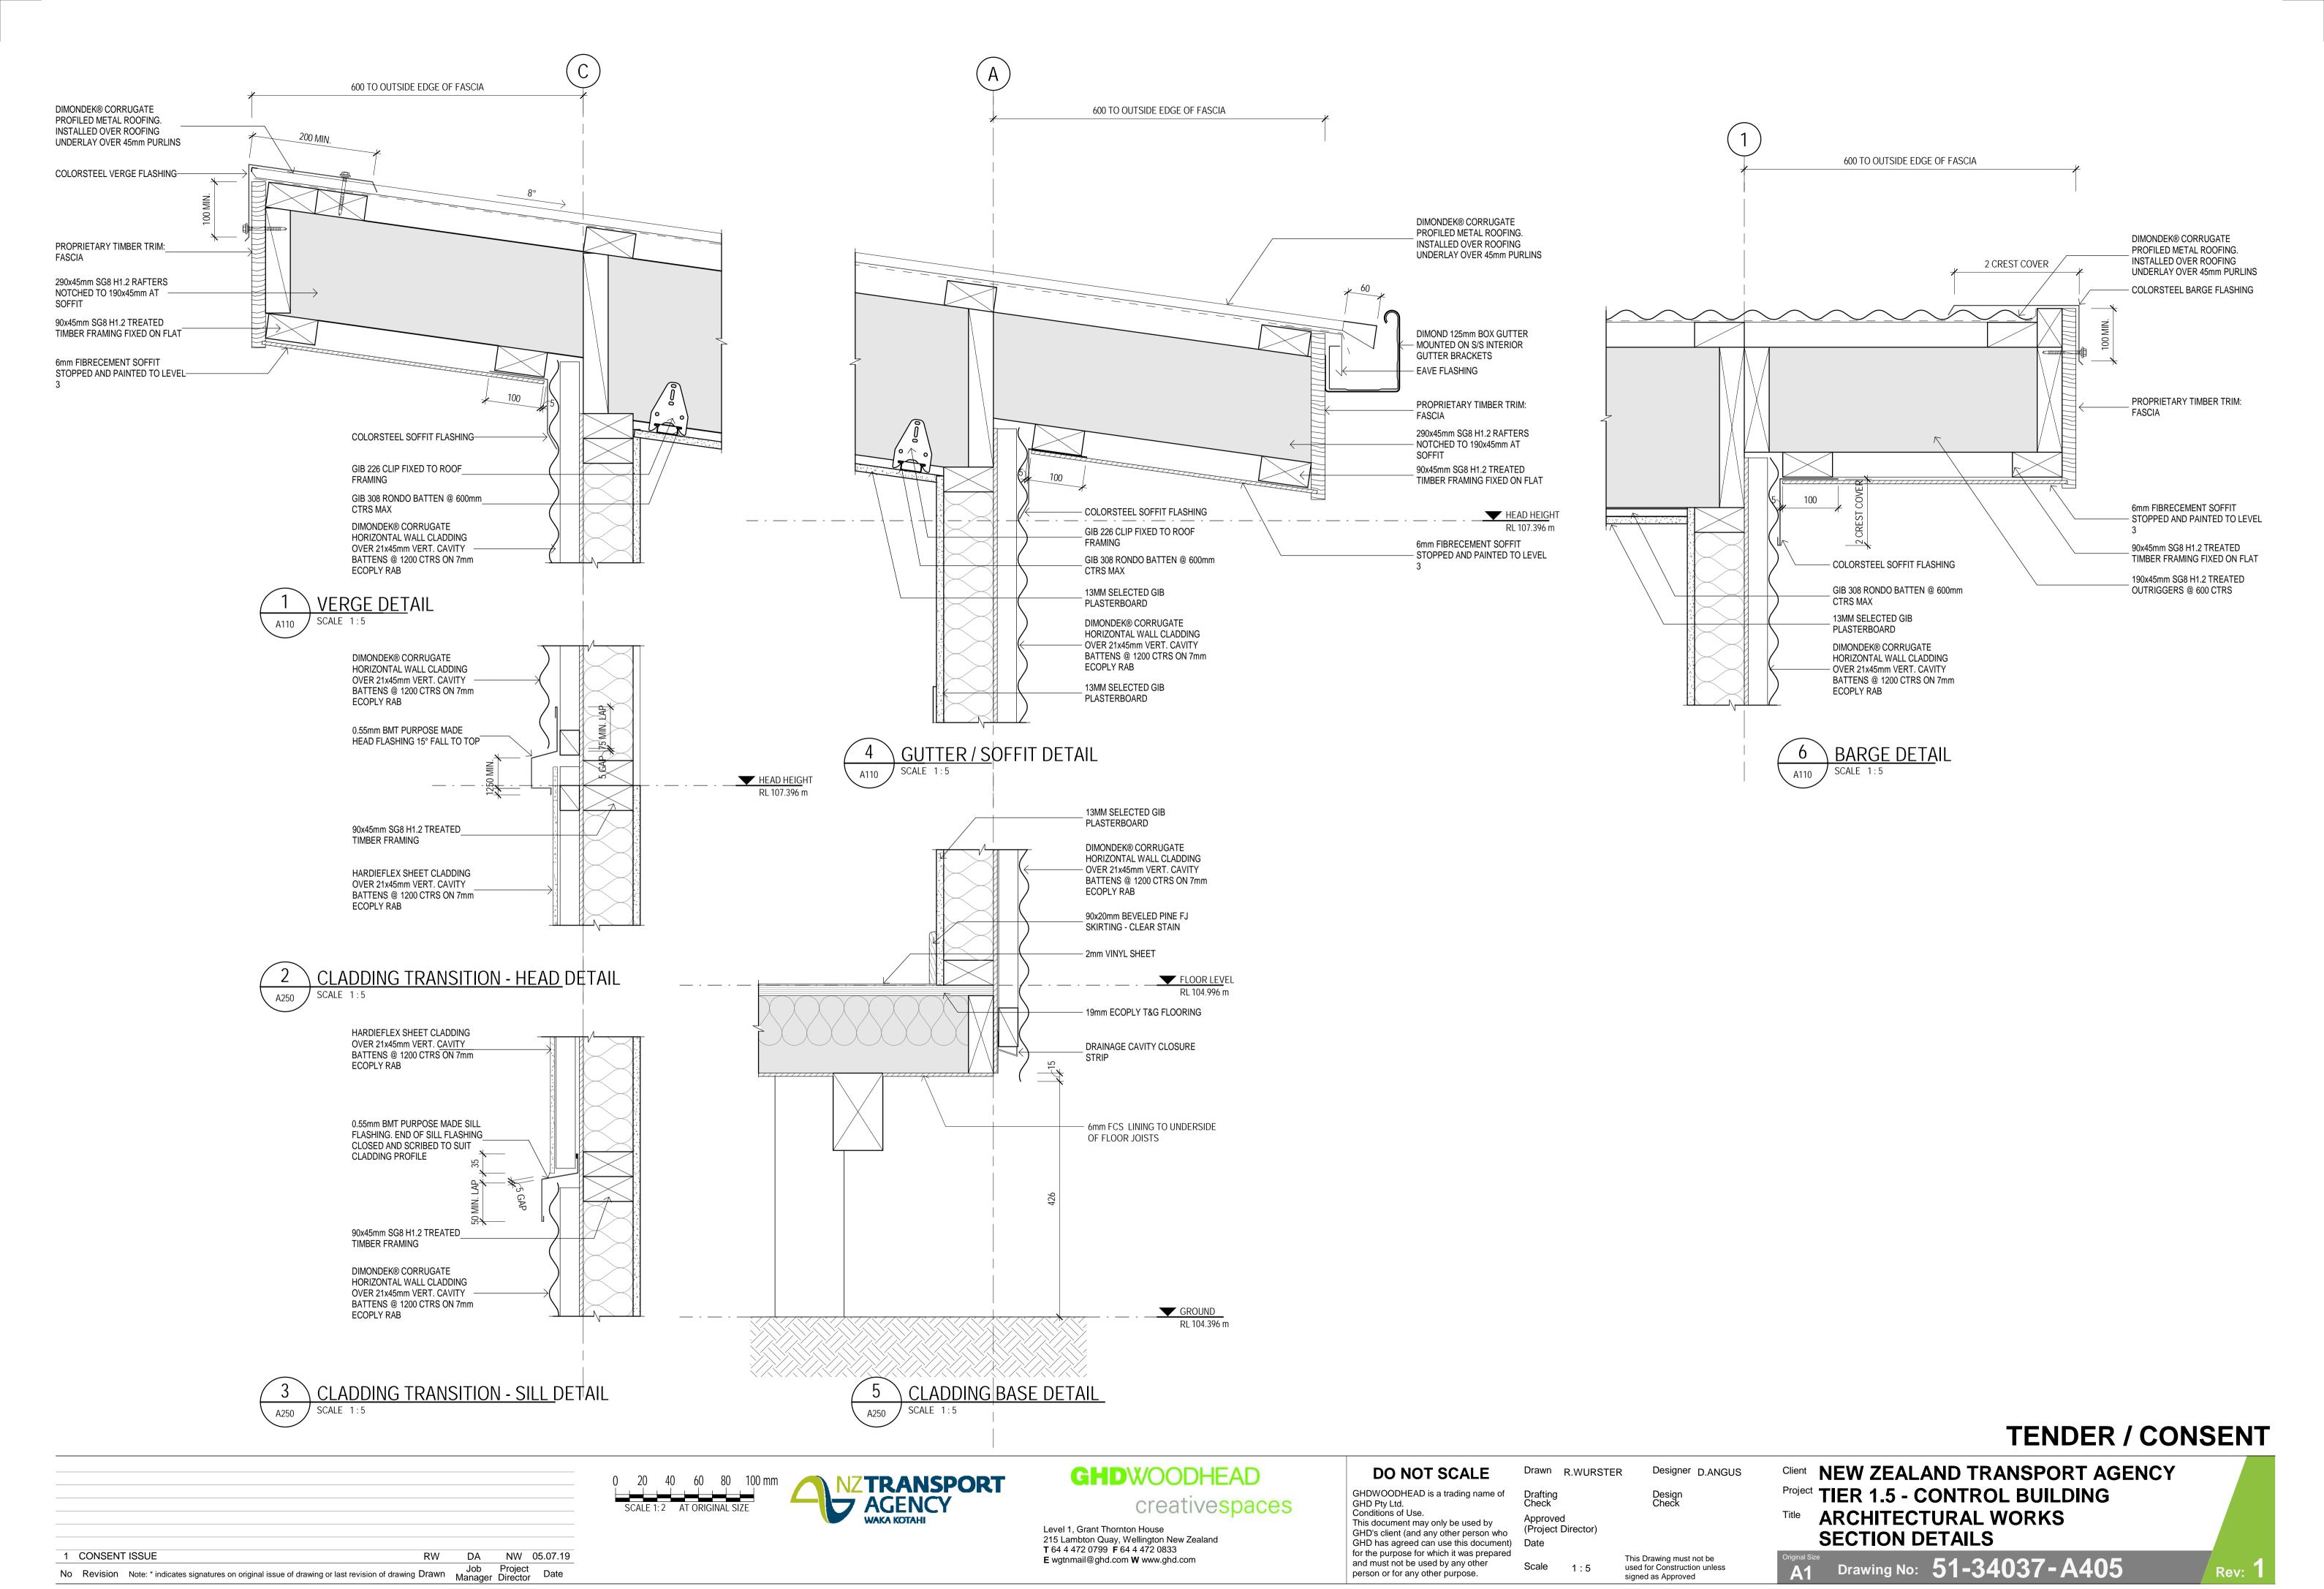

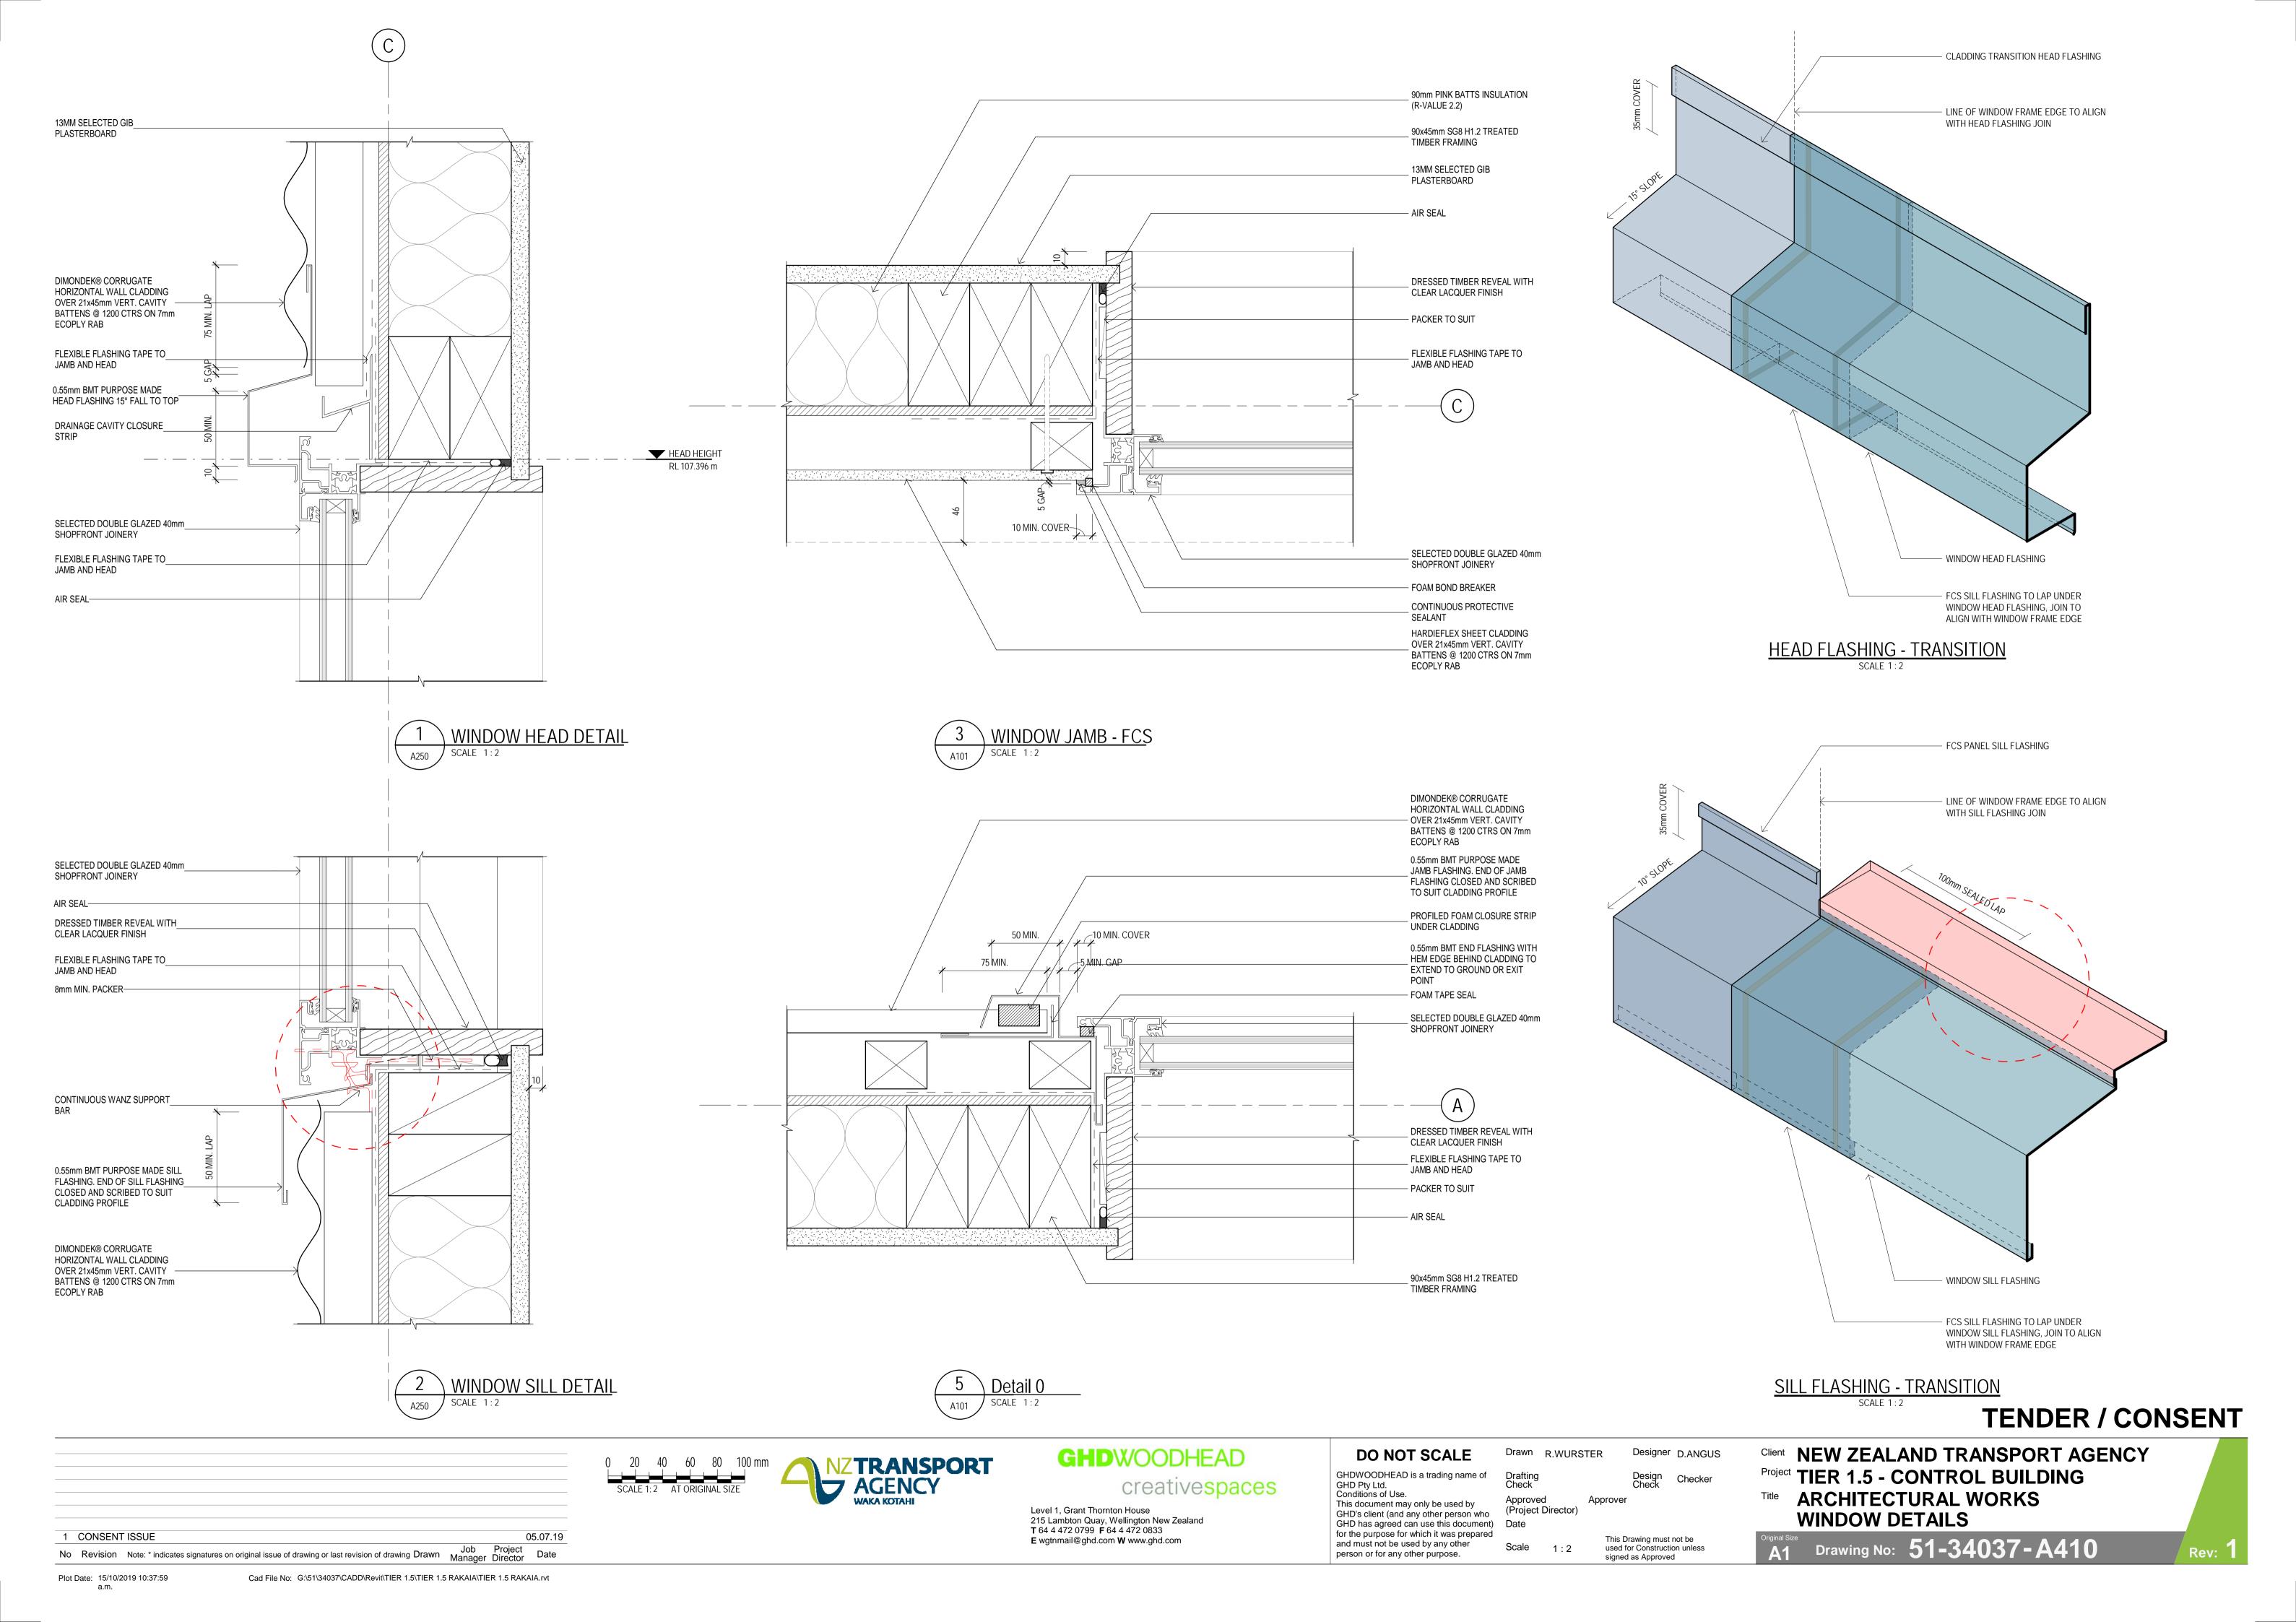

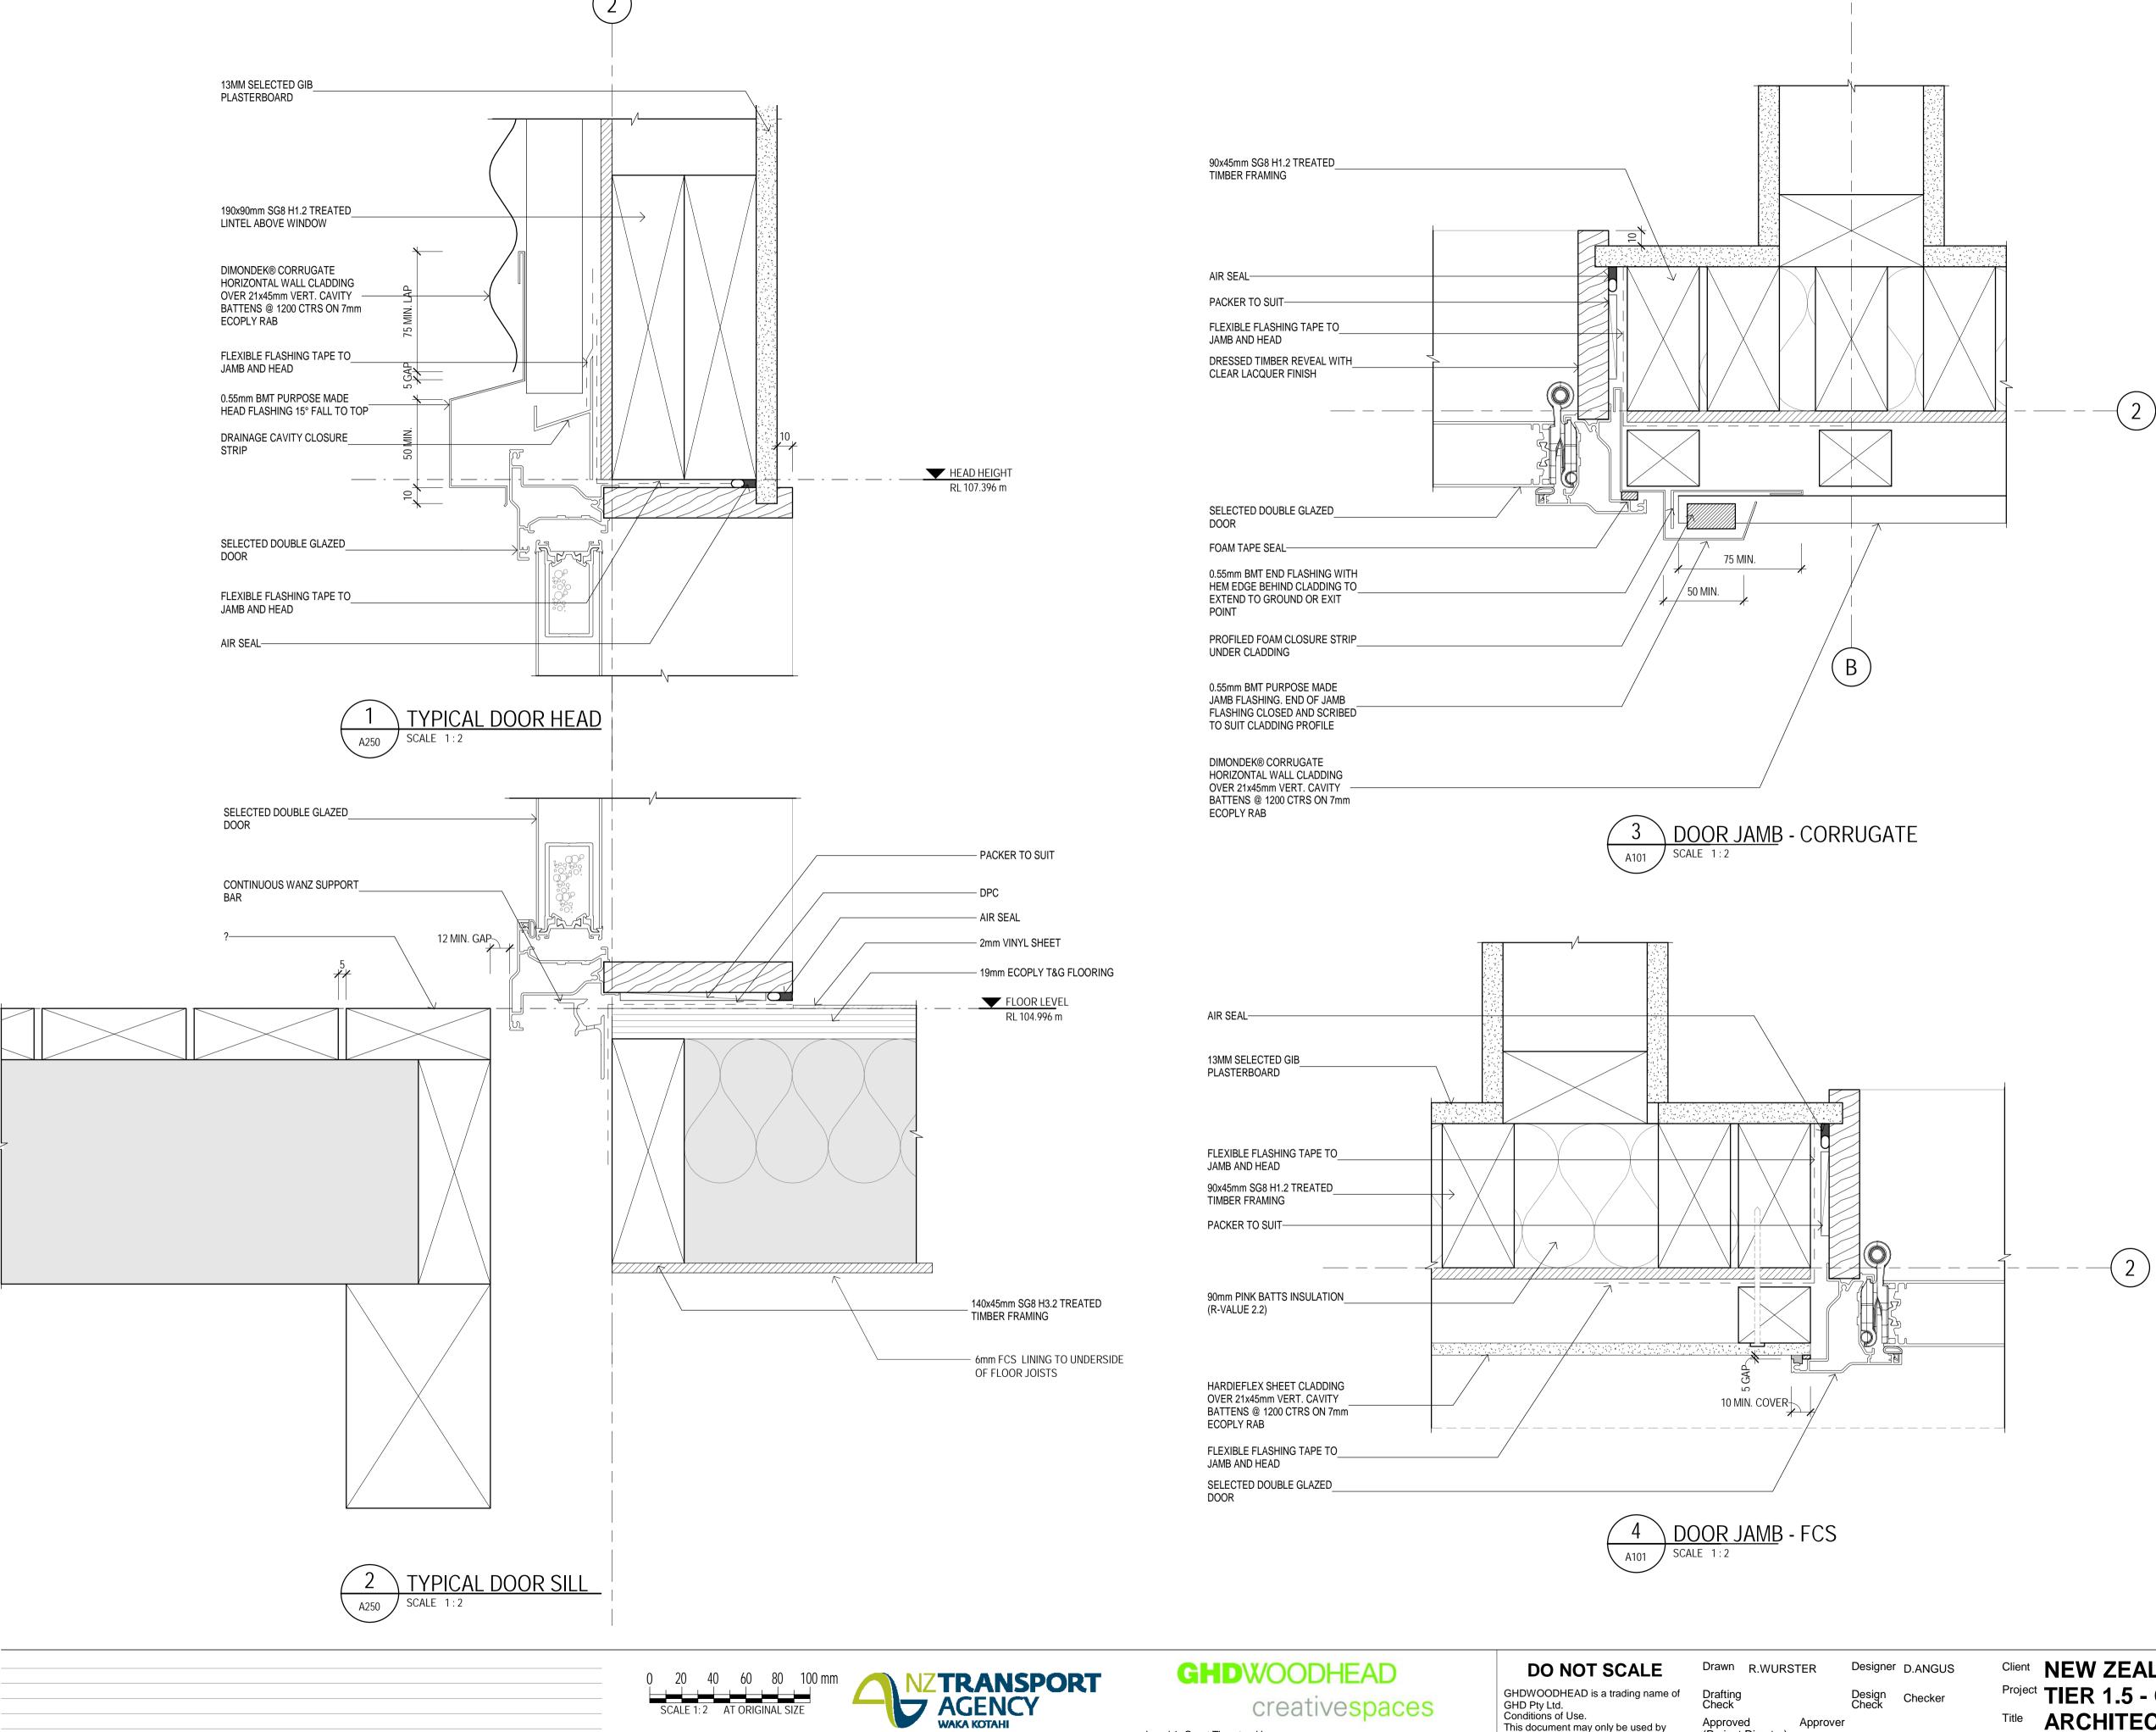

05.07.19 1 CONSENT ISSUE

creativespaces

Level 1, Grant Thornton House 215 Lambton Quay, Wellington New Zealand **T** 64 4 472 0799 **F** 64 4 472 0833 E wgtnmail@ghd.com W www.ghd.com


GHD Pty Ltd.
Conditions of Use.
This document may only be used by GHD's client (and any other person who


Approved GHD has agreed can use this document) Date for the purpose for which it was prepared and must not be used by any other person or for any other purpose.

Approver (Project Director) This Drawing must not be used for Construction unless signed as Approved Client NEW ZEALAND TRANSPORT AGENCY Project TIER 1.5 - CONTROL BUILDING

Title ARCHITECTURAL WORKS **DOOR DETAILS**

Drawing No: 51-34037-A415

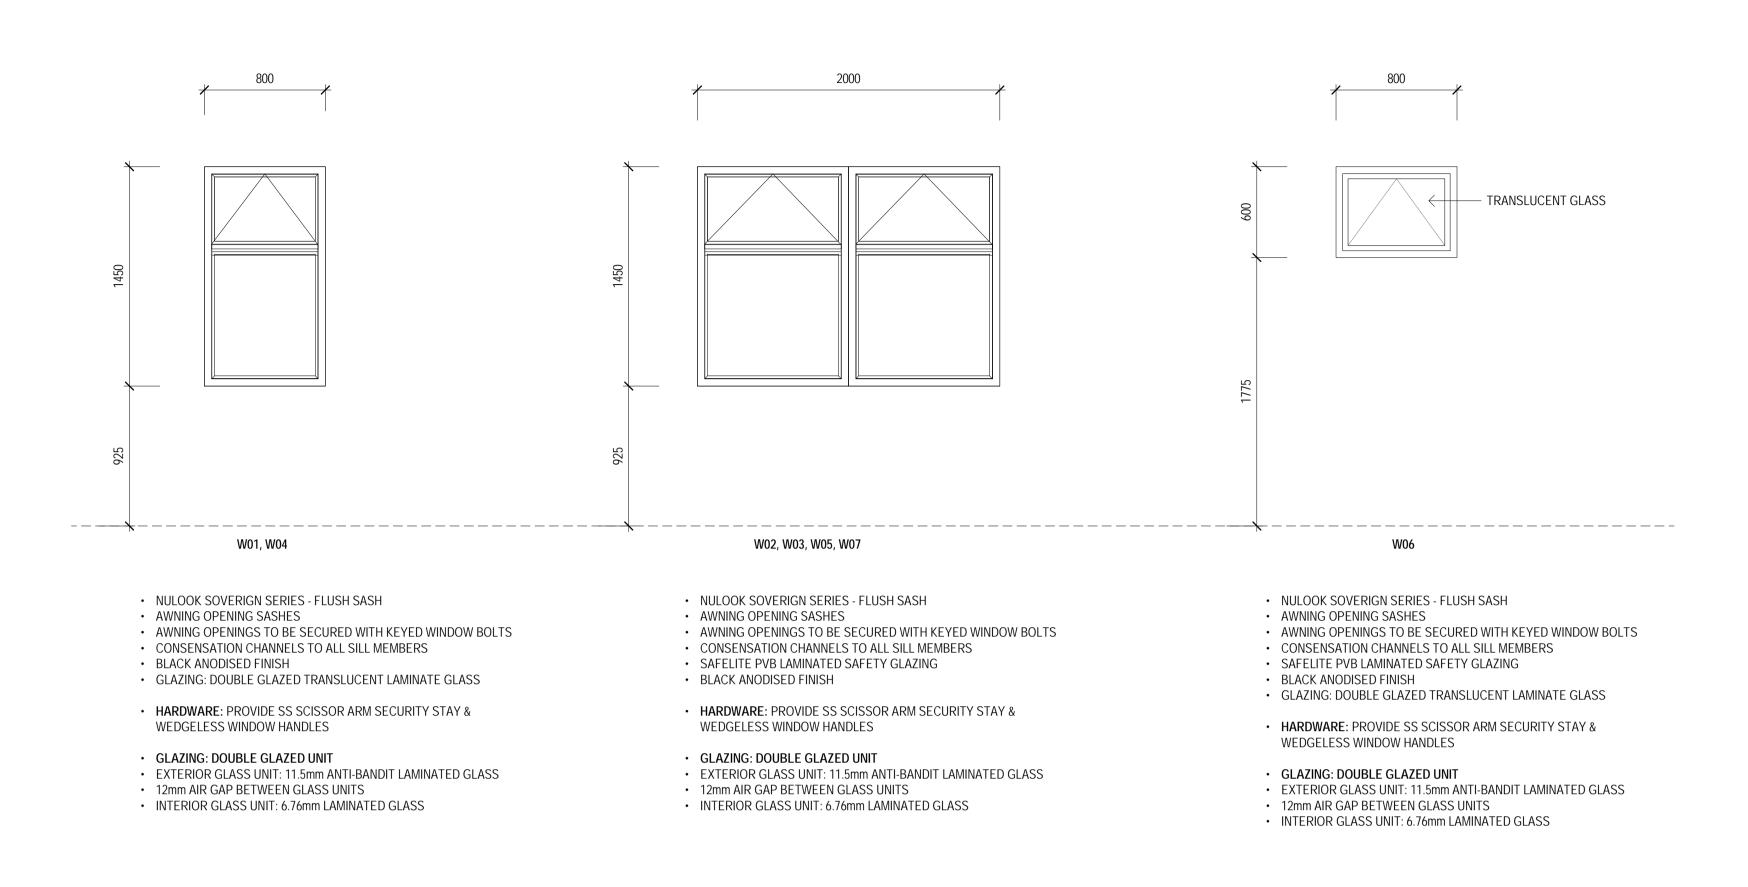

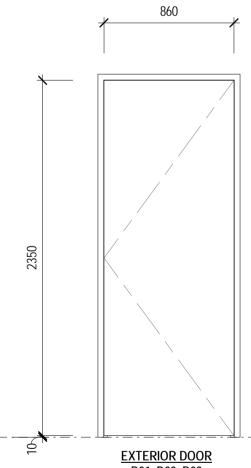

SOLID CORE 44mm THICK

ALUMINIUM, PC1 FINISH

LEGGE 12821 DOOR STOP

PAINT FINISH IN 'GREY FRIARS'

MILD STEEL FACING (SUITABLE FOR EXTERIOR USE)

LCN 1461P SIZE 1-6 REGULAR FC DOOR CLOSER

LEGGE LATCH FURNITURE TO MATCH EXISTING

PROXY CARD SECURITY INSTALLED TO DOOR

LEGGE 990 C57 60mm BACKSET MORTICE PASSAGE LATCH

N/A

N/A

FIRE RATING

VISION PANEL

FACING FINISH

FRAME

FACING

HINGES

LATCH

CLOSER

HANDLE


STOP

Plot Date: 15/10/2019 10:38:01 a.m.


PUSHPLATE

KICKPLATE

COMMENTS

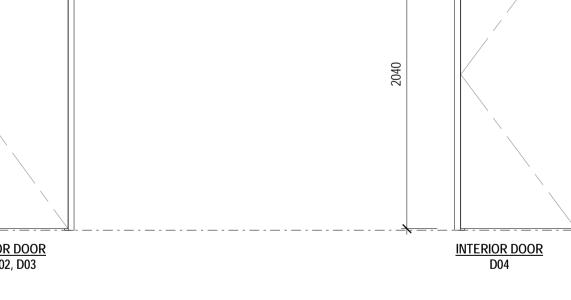

KICKPLATE

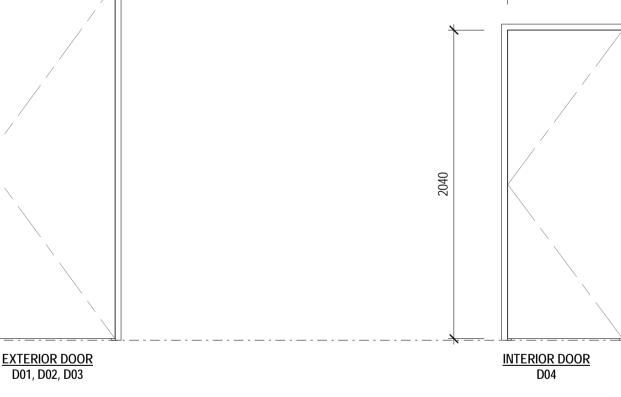

PACIFIC DOORS 3UE HINGED DOOR FIRE RATING **VISION PANEL** FRAME **FACING** GALV MILD STEEL FACING (SUITABLE FOR EXTERIOR USE) FACING FINISH PAINT FINISH IN 'GREY FRIARS' HINGES LATCH MOTTURA MULTIPOINT LOCKING SYSTEM INBUILT **CLOSER** LCN 1461P SIZE 1-6 REGULAR FC DOOR CLOSER HANDLE N/A MOTTURA LOCKING SYSTEM ONLY PUSHPLATE

LEGGE 12821 DOOR STOP

 HARDWARE: REFER TO SPECIFICATION INTERIOR DOOR D05

 INTERIOR SOLID CORE DOOR PAINT FINISH - RESENE 'ALABASTER'

 HOLYOAKE 400w x 200h SERIES DG-52 DOOR GRILLES INSTALLED TO DOOR

LEAFS, SATIN ANODISED FINISH

INTERIOR SOLID CORE FIRE RATING VISION PANEL N/A FRAME TIMBER **FACING** TIMBER FACING FINISH PAINT FINISH IN 'GREY FRIARS' HINGES LATCH CLOSER HANDLE LEGGE 990 C57 60mm BACKSET MORTICE PASSAGE LATCH LCN 1461P SIZE 1-6 REGULAR FC DOOR CLOSER LEGGE LATCH FURNITURE TO MATCH EXISTING LOCK COMBINATION PUSH PIN PAD PUSHPLATE KICKPLATE STOP LEGGE 12821 DOOR STOP COMMENTS DOOR GRILLE INSTALLED TO DOOR LEAFS

 200mm HIGH SS KICKPLATES EITHER SIDE 760 LEAF INTERIOR DOOR D06, D07

 INTERIOR SOLID CORE DOOR CLEAR GLASS VISION PANEL

PAINT FINISH - RESENE 'ALABASTER'

HARDWARE: REFER TO SPECIFICATION

INTERIOR SOLID CORE FIRE RATING VISION PANEL YES FRAME TIMBER **FACING** TIMBER PAINT FINISH IN 'GREY FRIARS' FACING FINISH HINGES LATCH LEGGE 990 C57 60mm BACKSET MORTICE PASSAGE LATCH CLOSER LCN 1461P SIZE 1-6 REGULAR FC DOOR CLOSER HANDLE LEGGE LATCH FURNITURE TO MATCH EXISTING PUSHPLATE

LEGGE 12821 DOOR STOP

KICKPLATE


COMMENTS

STOP

TOILET INTERIOR DOOR D08

 CS FOR DOORS POWDERSEAL EASI-OPEN CAVITY SLIDER PAINT FINISH - RESENE 'GREY FRIARS' HARDWARE: CL100 LAVLOCK WITH TURN AND **EMERGENCY RELEASE** • 200mm HIGH SS KICKPLATES EITHER SIDE UNISEX TOILET SIGNAGE TO BE INSTALLED TO


OUTSIDE DOOR LEAF

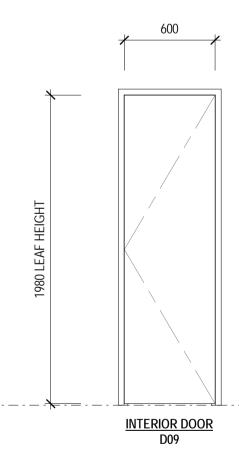

 INTERIOR SOLID CORE DOOR • PAINT FINISH - RESENE 'GREY FRIARS' HARDWARE: REFER TO SPECIFICATION

20mm UNDERCUT TO DOOR LEAF

TENDER / CONSENT

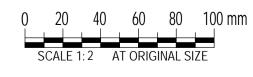



GHDWOODHEAD

creativespaces

Level 1, Grant Thornton House 215 Lambton Quay, Wellington New Zealand T 64 4 472 0799 F 64 4 472 0833 E wgtnmail@ghd.com W www.ghd.com

DO NOT SCALE GHDWOODHEAD is a trading name of GHD Pty Ltd. Conditions of Use.

person or for any other purpose.

PROXY CARD SECURITY REQUIRED TO DOOR D07

Drafting Check Approved This document may only be used by GHD's client (and any other person who GHD has agreed can use this document) Date for the purpose for which it was prepared and must not be used by any other

Drawn R.WURSTER Designer D.ANGUS (Project Director)

used for Construction unless

signed as Approved

Client NEW ZEALAND TRANSPORT AGENCY


ARCHITECTURAL WORKS DOOR & WINDOW SCHEDULE

Drawing No: 51-34037-A500

1 CONSENT ISSUE NW 05.07.19 No Revision Note: * indicates signatures on original issue of drawing or last revision of drawing Drawn Manager Director

Cad File No: G:\51\34037\CADD\Revit\TIER 1.5\TIER 1.5 RAKAIA\TIER 1.5 RAKAIA.rvt

Project TIER 1.5 - CONTROL BUILDING

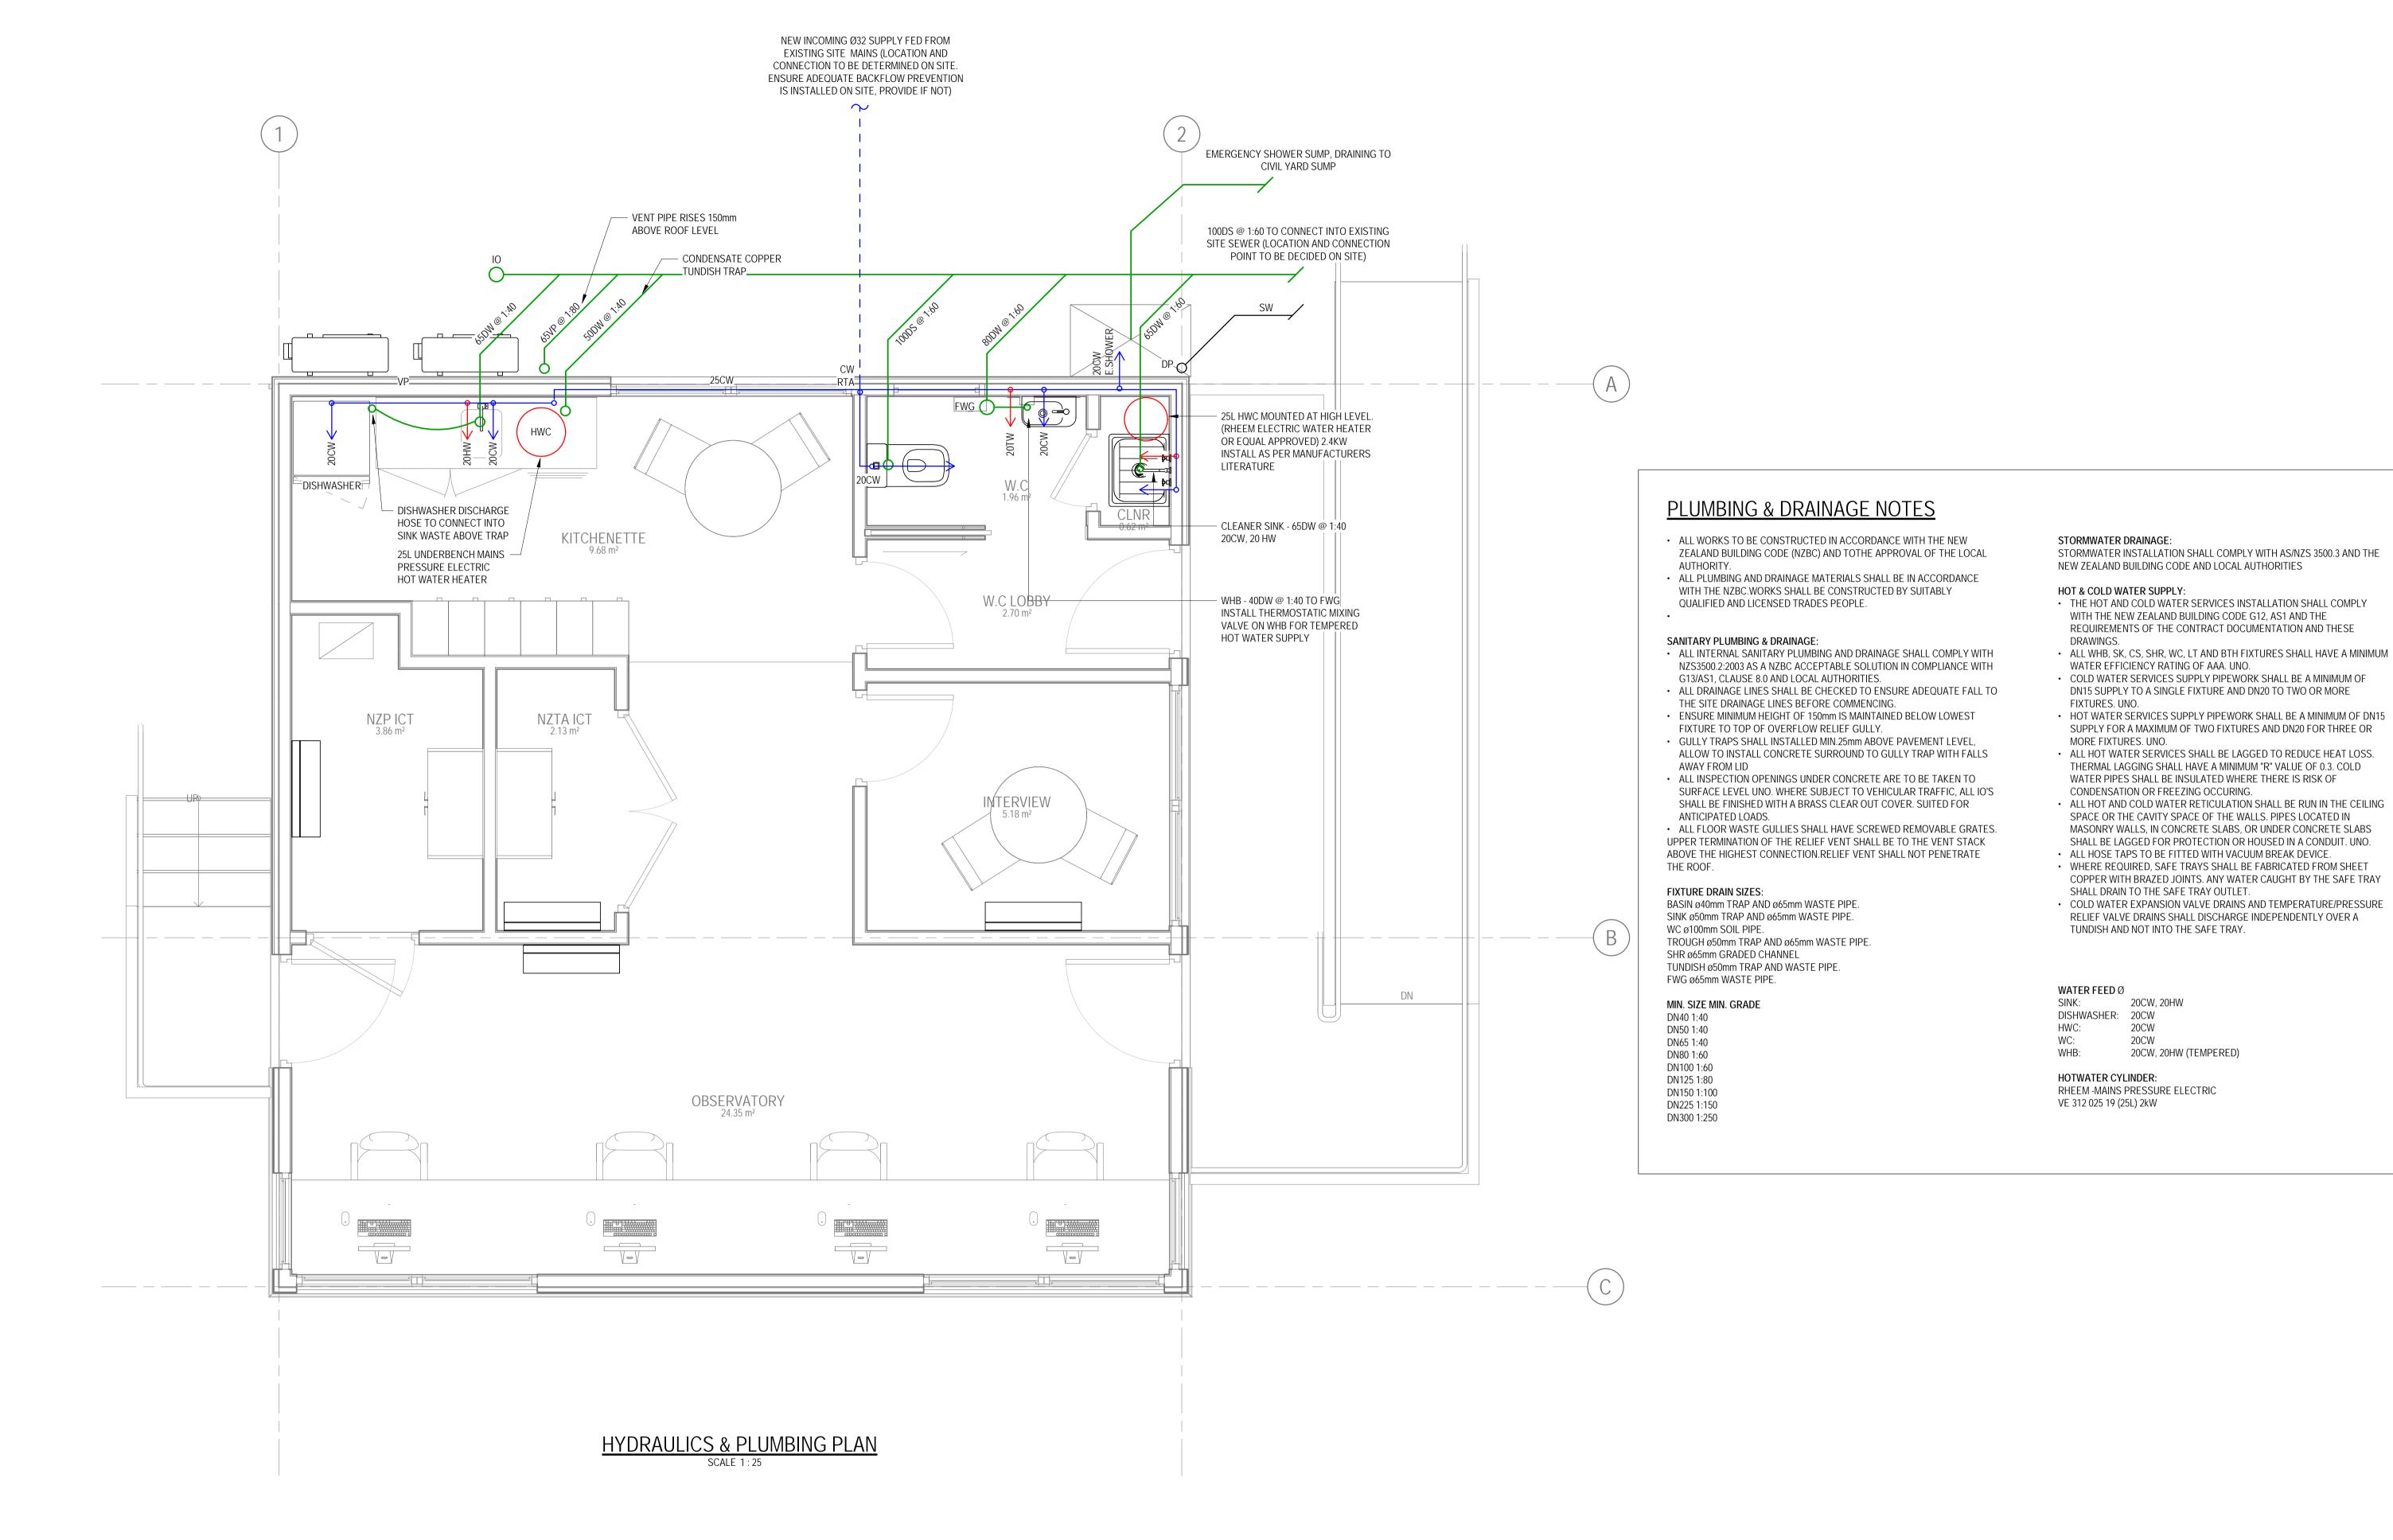

250 500 750 1000 1250mm 1 CONSENT ISSUE EB 05.07.19 No Revision Drawn Date

GHDWOODHEAD creativespaces


Level 1, Grant Thornton House 215 Lambton Quay, Wellington New Zealand **T** 64 4 472 0799 **F** 64 4 472 0833 **E** wgtnmail@ghd.com **W** www.ghd.com


Conditions of Use.
This document may only be used by GHD's client (and any other person who GHD has agreed can use this document) for the purpose for which it was prepared and must not be used by any other person or for any other purpose.

DO NOT SCALE Scale As indicated

Client NEW ZEALAND TRANSPORT AGENCY Project TIER 1.5 - CONTROL BUILDING

HYDRAULICS & PLUMBING PLAN

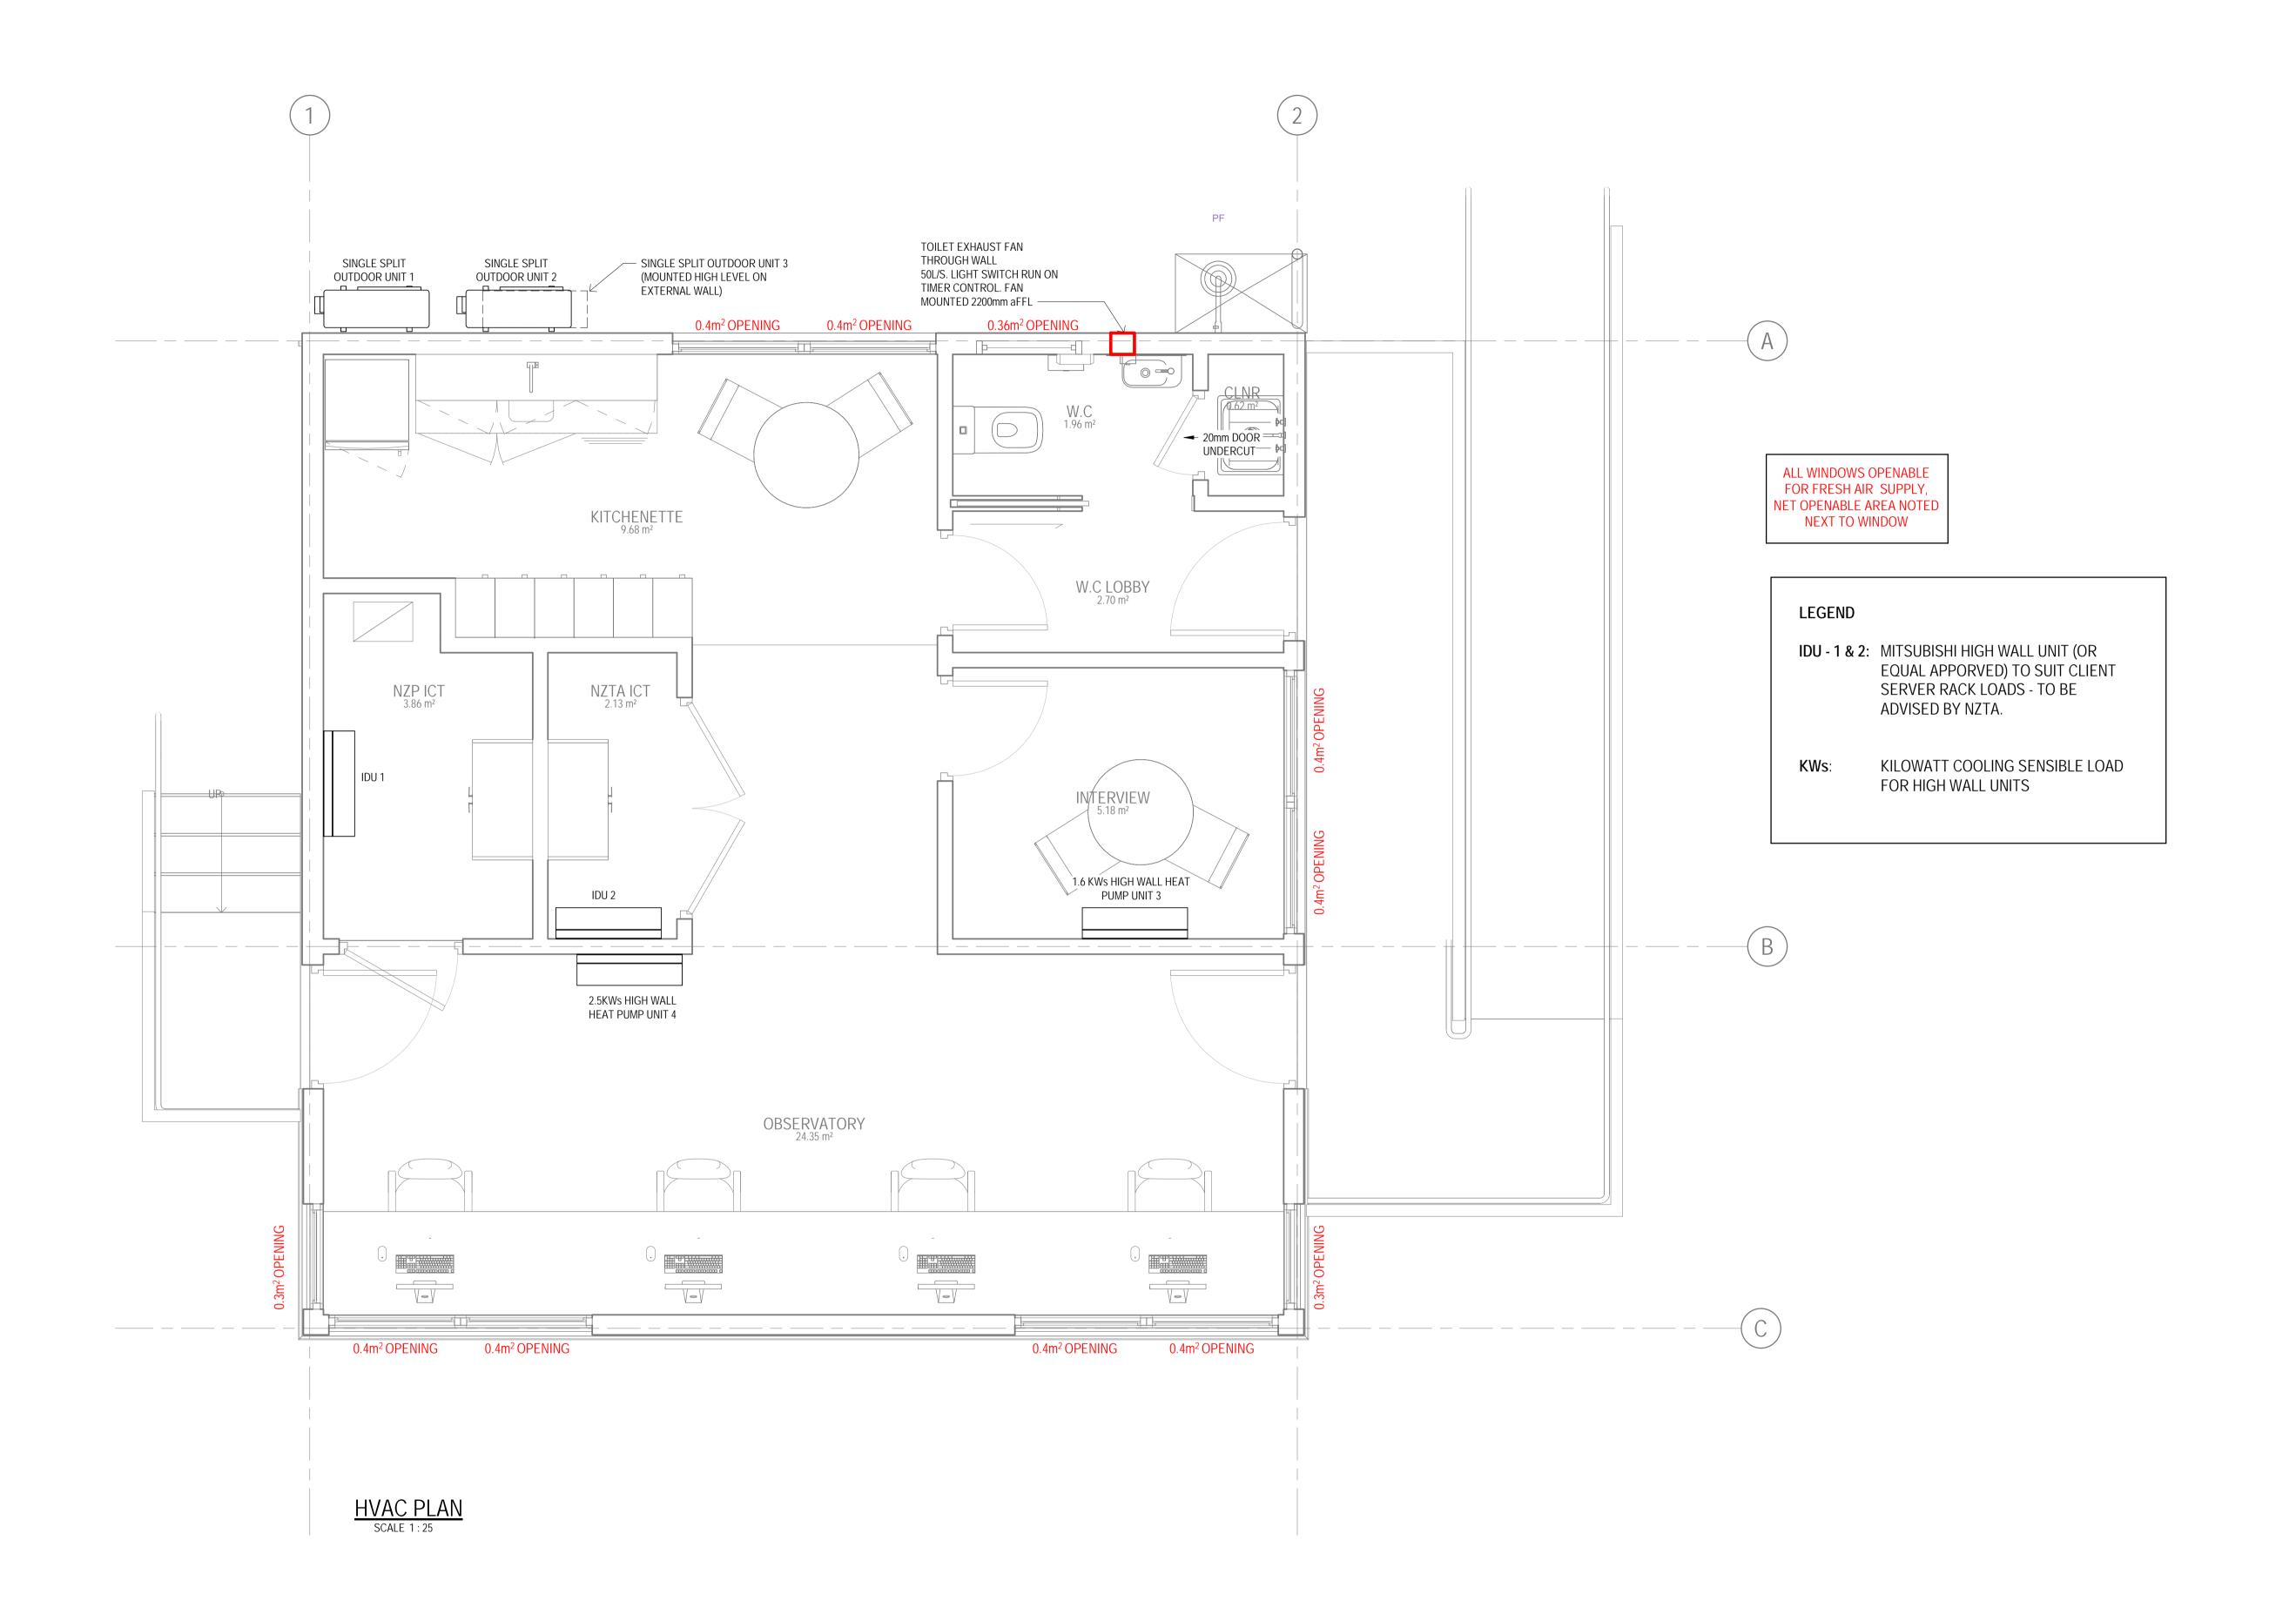

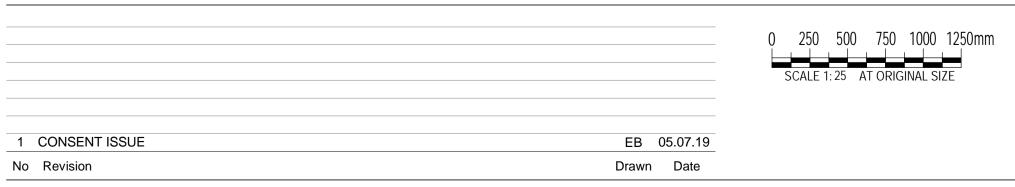

GHDWOODHEAD creativespaces


Level 1, Grant Thornton House 215 Lambton Quay, Wellington New Zealand T 64 4 472 0799 F 64 4 472 0833 E wgtnmail@ghd.com W www.ghd.com Conditions of Use.
This document may only be used by
GHD's client (and any other person who
GHD has agreed can use this document)
for the purpose for which it was prepared
and must not be used by any other
person or for any other purpose.

DO NOT SCALE
Scale 1:25

Client NEW ZEALAND TRANSPORT AGENCY
Project TIER 1.5 - CONTROL BUILDING

MECHANICAL LAYOUT PLAN

Original Size
A1 Drawing No: 51-34037-A801

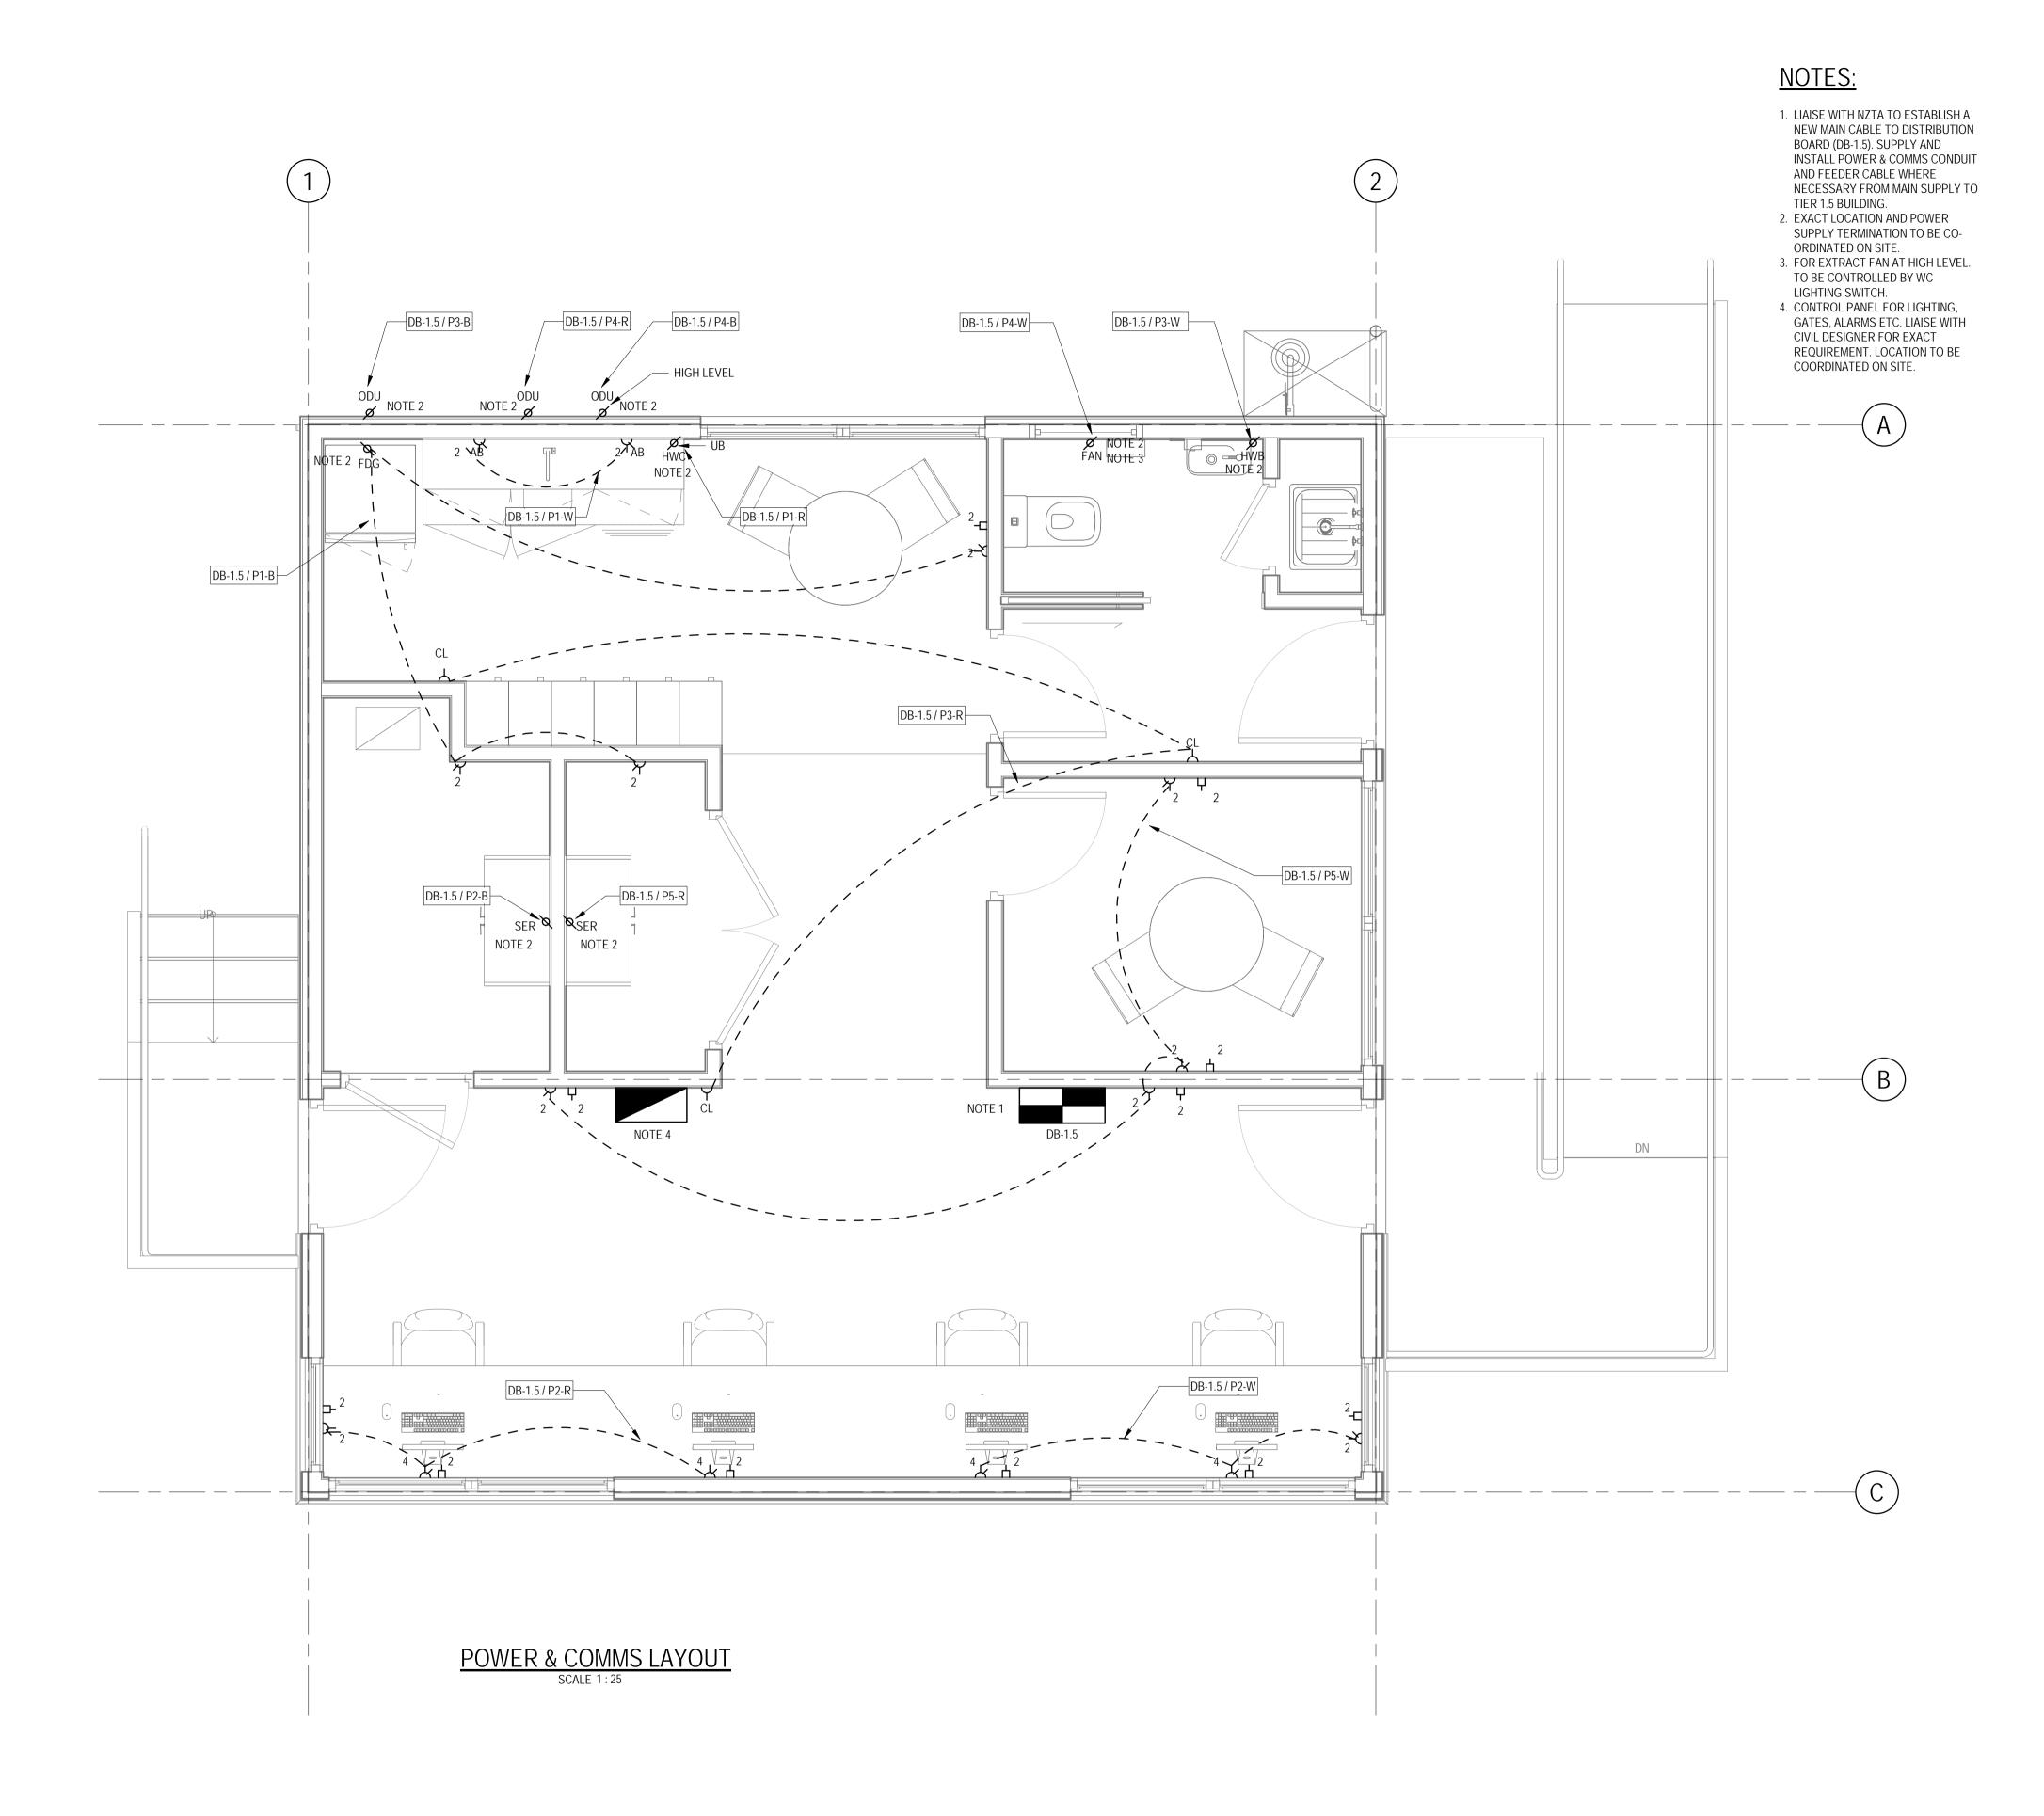

POWER

DISTRIBUTION BOARD (DB) CONTROL PANEL SWITCHED SOCKET OUTLET. NO. INDICATES QUANTITY. (2 SHOWN) SWITCHED SOCKET OUTLET. NO. INDICATES QUANTITY. (4 SHOWN) CLEANER OUTLET CIRCUIT LINE POWER SUPPLY FOR EXTRACT FAN POWER SUPPLY FOR FRIDGE

Ø FDG

POWER SUPPLY FOR HOT WATER BOILER

POWER SUPPLY FOR HEAT PUMP OUTDOOR UNIT

POWER SUPPLY FOR SERVER

COMMUNICATIONS

COMMUNICATIONS OUTLET FOR DATA. PROVIDE SINGLE MOUNTING PLATE WITH NUMBER OF OUTLETS AS INDICATED (2

COMMUNICATIONS SERVICES SHOWN FOR INFORMATION & CO-ORDINATION ONLY. SUPPLY AND INSTALLATION OF SERVICES BY OTHERS

POWER SUPPLY FOR HOT WATER CYLINDER

ABBREVIATIONS

AB ABOVE BENCH AFFL ABOVE FINISHED FLOOR LEVEL

CL CLEANERS' SOCKET C/W COMPLETE WITH

FDG FRIDGE HWB HOT WATER BOILER HWC HOT WATER CYNLINDER NTS NOT TO SCALE

ODU HEAT PUMP OUTDOOR UNIT

UB UNDER BENCH

GENERAL NOTES

1. ALL ELECTRICAL INSTALLATION SHALL COMPLY WITH AS/NZS 3000.

2. LOCATION OF ALL DOORS AND DOOR SWINGS TO BE CONFIRMED WITH THE ARCHITECT PRIOR TO LIGHT SWITCH AND WIRING INSTALLATION.

3. UNLESS STATED OTHERWISE ALL LIGHT

SWITCHES TO BE MOUNTED AT 1200mm AFFL AND POWER OUTLETS AT 300mm AFFL. 4. RUN AN UNSWITCHED ACTIVE TO EACH EMERGENCY LIGHT FITTING AND PROVIDE

EMERGENCY TEST FACILITIES. 5. ALL CONDUITS SHALL BE INSTALLED C/W PLASTIC DRAW WIRES.

6. LIAISE WITH ALL TRADES. 7. WHERE REQUIRED FOR SUPPORT AND FOR SEISMIC REQUIREMENTS ALLOW TO PROVIDE AND INSTALL UNISTRUT C/W BRACKETS AND FIXINGS BETWEEN PURLINS

AND STRUCTURAL MEMBERS AS REQUIRED. 8. CABLES SHALL BE RUN IN TREFOIL FORMATION UNLESS STATED OTHERWISE.

9. ALL DISTRIBUTION BOARDS SHALL BE TPN CONFIGURATION UNLESS STATED OTHERWISE. 10. ALL CIRCUITS LABELED AS SPARE ON THE

SINGLE LINE DIAGRAM AND IN THE DISTRIBUTION BOARD SCHEDULES SHALL BE PROVIDED C/W CIRCUIT BREAKERS. 11. ALL SURFACE CONDUITS SHALL BE GRAY.

12. ALL LUMINARIES SHALL BE SEISMIC RESTRAINT WITH GRIPPLE SEISMIC KIT. 13. THE SUB CONTRACTOR IS TO COORDINATE

WITH ALL RELEVANT ARCHITECTURAL

DRAWINGS, DETAILS, ELEVATIONS, JOINERY DETAILS AND WITH JOINERY INSTALLER. 14. EMERGENCY LIGHT FITTING AND EXIT SIGNS SHALL BE SUPPLIED BY LOCAL LIGHTING CIRCUIT.

15. LIAISE WITH MECHANICAL TRADE FOR **EXACT LOCATION OF MECHANICAL** EQUIPMENT AND FINAL TERMINATION OF CABLINGS.

TENDER / CONSENT

1 CONSENT ISSUE NW 05.07.19 No Revision Note: * indicates signatures on original issue of drawing or last revision of drawing Drawn Job Manager Director Date

NZTRANSPORT AGENCY WAKA KOTAHI 250 500 750 1000 1250mm

GHDWOODHEAD creativespaces

Level 1, Grant Thornton House 215 Lambton Quay, Wellington New Zealand **T** 64 4 472 0799 **F** 64 4 472 0833 **E** wgtnmail@ghd.com **W** www.ghd.com

DO NOT SCALE

GHDWOODHEAD is a trading name of GHD Pty Ltd.
Conditions of Use.
This document may only be used by GHD's client (and any other person who GHD has agreed can use this document) Date

for the purpose for which it was prepared

and must not be used by any other

person or for any other purpose.

Drafting Check Design Check Approved (Project Director) This Drawing must not be

Designer

As indicated used for Construction unless


signed as Approved

Drawn

Client NEW ZEALAND TRANSPORT AGENCY Project TIER 1.5 - CONTROL BUILDING

POWER, & COMMS LAYOUT

Drawing No: 51-34037-A900

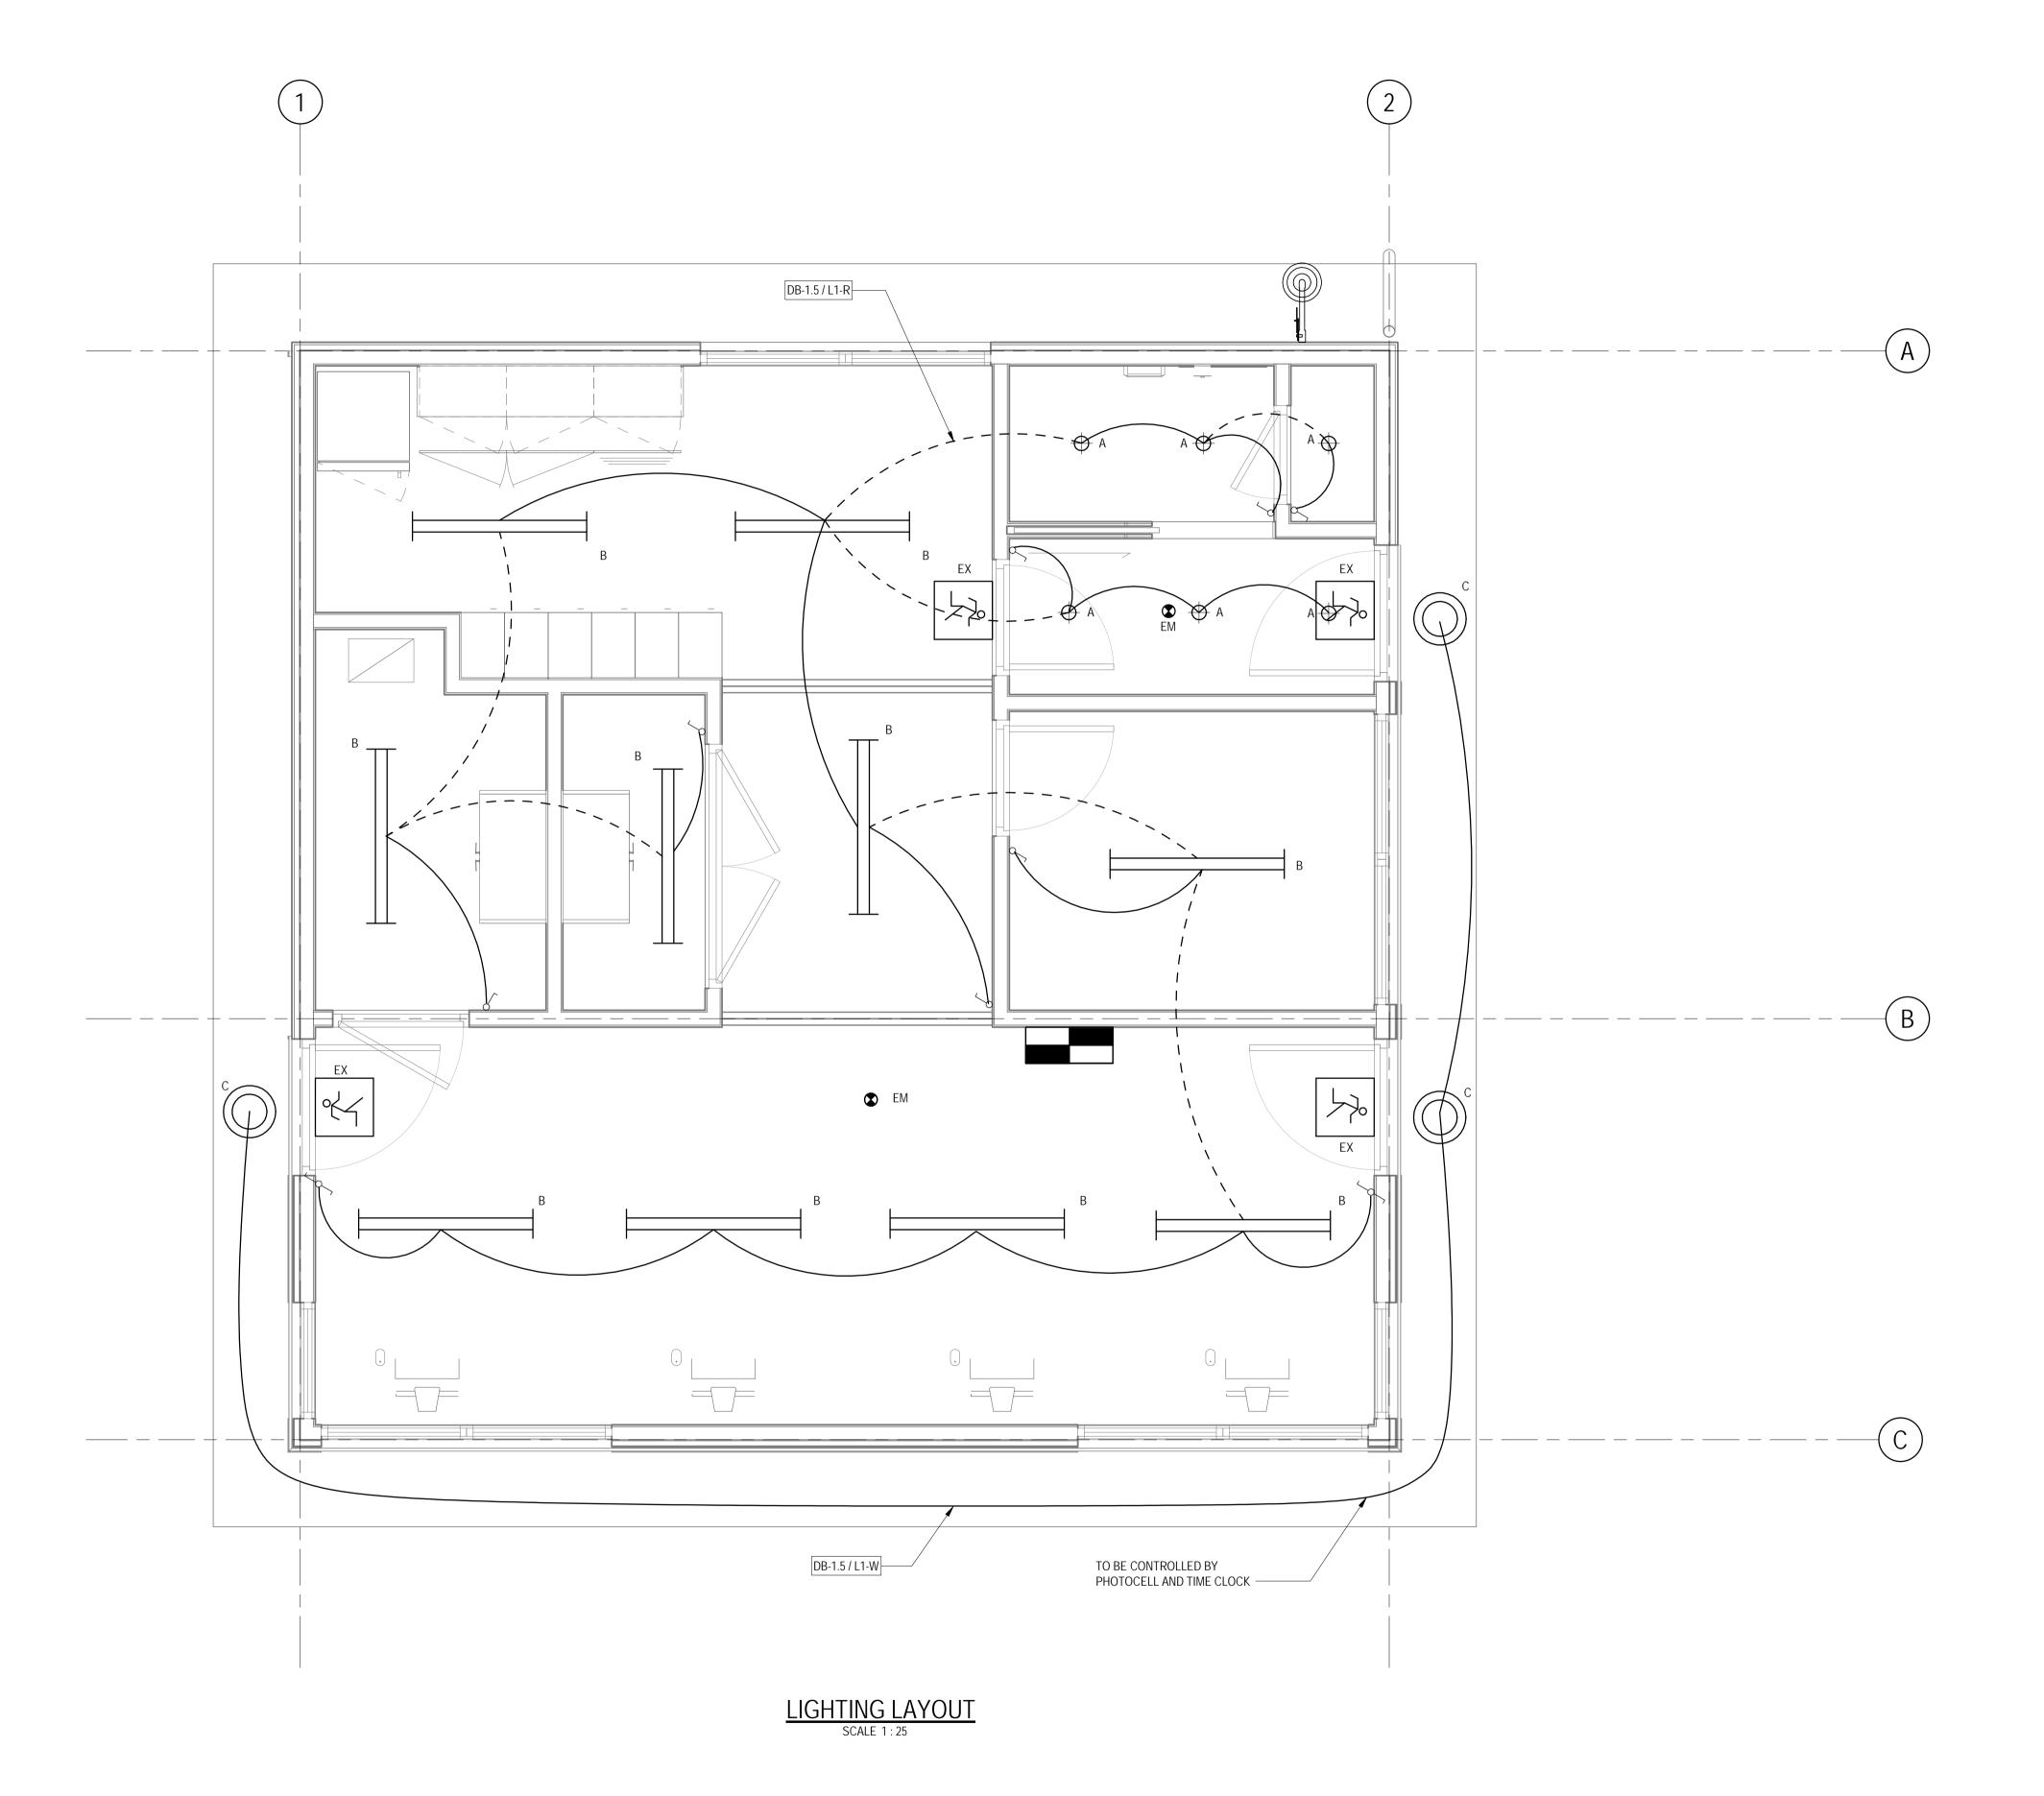

<u>LIGHTING</u>

SWITCHING LINE

CIRCUIT LINE

ONE WAY LIGHT SWITCH

TWO WAY LIGHT SWITCH

SURFACE MOUNTED LUMINAIRE

→ DOWNLIGHT

BULKHEAD TYPE LUMINAIRE

S1 RECESSED OCCUPANCY SENSOR

S2> SURFACE MOUNTED IP55 PIR SENSOR

EMERGENCY LIGHTING

☼ INTERNALLY ILLUMINATED EXIT SIGN

RECESSED EMERGENCY LUMINAIRE

LUMIN	LUMINAIRE SCHEDULE							
LABEL	IMAGE	DESCRIPTION						
А		VERSALUX COMO MINI, 11W LED AND 775Im OUTPUT. IP44 RATED, FACETED CLEAR REFLECTOR, C/W HF NON-DIM DRIVER, 4000K COLOUR TEMPERATURE. LUMINAIRE TO BE RECESSED INTO CEILING						
В		VERSALUX AXIUM LINEAR EXTRUDED LUMINAIRE, 34W LED WITH 4100lm OUTPUT, IP20 RATED, C/W INTERGRAL ELECTRONIC GEAR. 4000K COLOUR TEMPERATURE. LUMINAIRE TO BE SUSPENDED AT 2400mm AFFL.						
D	0	LEGRAND BULKHEAD R 360 PLAIN LED LUMINAIRE WITH EMERGENCY LIGHTING FUNCTION, 18W LED WITH 2700lm OUTPUT, IP65 AND IK10 RATED, CW INTERGRAL FIXED OUTPUT ELECTRONIC GEAR. 4000K COLOUR TEMPERATURE. C/W BATTERY PACK WITH MINIMUM 90 MINUTES DISCHARGE TIME. LUMINAIRE TO BE SURFACE MOUNTED TO UNDERSIDE OF SOFFIT.						
EM	•	LEGRAND SATELLITE CORRIDOR NON-MAINTAINED SPU EMERGENCY LUMINAIRE 685204/LI, C/W 0.95W LED, Li-ion BATTERY PACK, D50 CLASSIFICATION, MINIMUM 90 MINUTES DISCHARGE TIME. LUMINIAIRE TO BE RECESSED INTO CEILING.						
EX	₹	LEGRAND G2 LED EMERGENCY MAINTAINED SPU RUNNING MAN DECAL EXIT SIGN,WHITE BODY, C/W Li-ion BATTERY PACK AND WALL/SURFACE MOUNTING KIT, MINIMUM 90 MINUTES DISCHARGE TIME. LUMINAIRE TO BE SURFACE MOUNTED TO WALL ABOVE DOOR.						

TENDER / CONSENT

1 CONSENT ISSUE

SZ 05.07.19

No Revision

Drawn Date

GHDWOODHEAD creativespaces

Level 1, Grant Thornton House 215 Lambton Quay, Wellington New Zealand T 64 4 472 0799 F 64 4 472 0833 E wgtnmail@ghd.com W www.ghd.com Conditions of Use.
This document may only be used by
GHD's client (and any other person who
GHD has agreed can use this document)
for the purpose for which it was prepared
and must not be used by any other
person or for any other purpose.

DO NOT SCALE


Scale As indicated

Client NEW ZEALAND TRANSPORT AGENCY
Project TIER 1.5 - CONTROL BUILDING

LIGHTING LAYOUT


Original Size
A1 Drawing No: 51-34037-A901

Appendix B

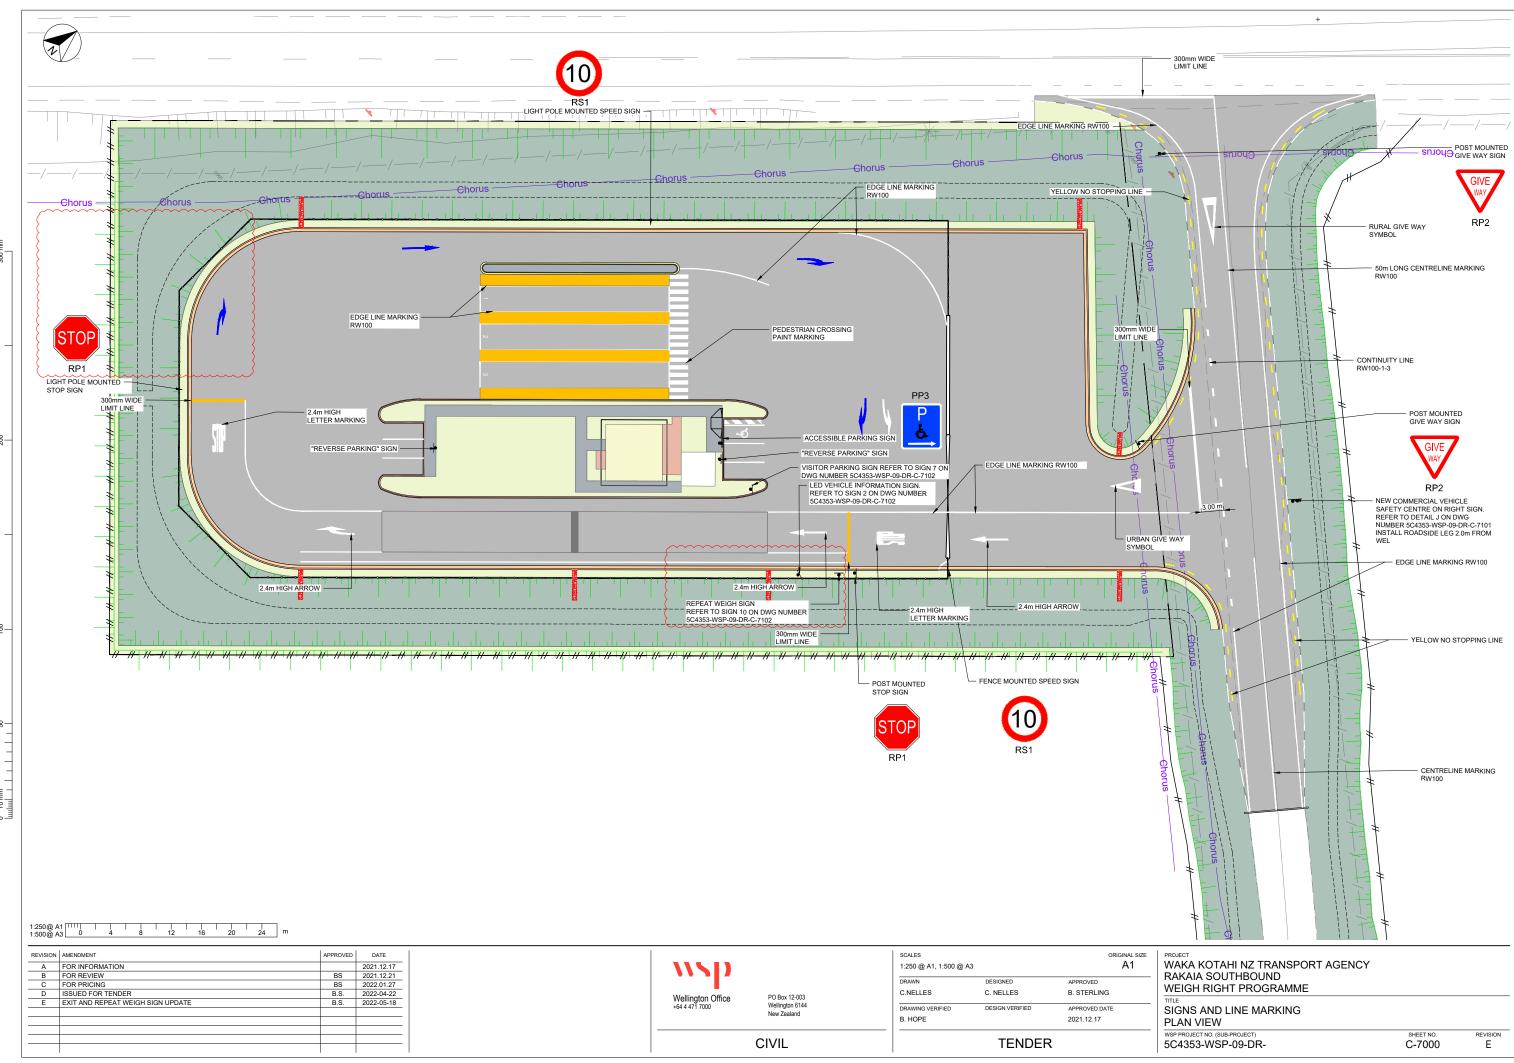

Appendix C

- LEGEND IS SERIES E 125.
 CONTRACTOR TO ORGANISE FOR SHOP DRAWINGS OF TRAFFIC SIGNS. SIGNS TO BE IN ACCORDANCE WITH THE TRAFFIC CONTROL DEVICES MANUAL AND MANUAL OF TRAFFIC SIGNS AND ROAD MARKINGS.
 TRAFFIC SIGN POSTS TO BE IN ACCORDANCE WITH RSMA.

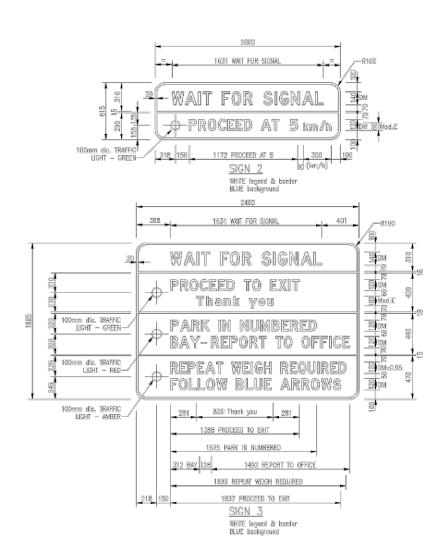

i i i i i i i i i i i i i i i i i i i
SIGN_7
WHITE legend, barder & orraw BLUE background
1129
177 210 100 465 - 177
Par Dedeat . 14 1
St - 458 WEIGH - 85
100 579 REPEAL 250 160
100 -11
SIGN 10
WHITE legend, border & proves BLUE, background

VISITOR

			COLOURS	5		SIGN SUPPOR	TS		-CONCRETE				COLOURS	i		SIGN SUPPOR	TS		CONCRETE
SIGN	SIGN			BACK-	Á	TIMBER SUPPORT	B	C CONC.	WEEDBAND	SIGN	SIGN			BACK-	Á IGL TO	TIMBER	B	15	WEEDBAND
NO.	TYPE	LEGEND	BORDER	GROUND	GL TO UNDERSIDE	SIZE	PILE		REQUIRED	NO.	TYPE	LEGEND	BORDER	GROUND	GL TO UNDERSIDE	SUPPORT SIZE		499643.59	REQUIRED
					OF SIGN (m)	(mm)	(m)	(m)							OF SIGN (m)	(mm)	(m)	(m)	
SIGN 2	INFO.	White	White	Blue	1.5	2/100x100	0.70	0.40	NO.	SIGN 7	INFO.	White	White	Blue	1.5	2/100x100	0.70	0.40	NO
SIGN 3	INFO.	White	White	Blue	1.5	2/150x150*	1,10	0.50	NO	SIGN 8	MS	White	White	Green	1.5	2/75x125	0.70	0.40	NO

REVISION	AMENDMENT	APPROVED	DATE
Α	FOR INFORMATION		2021.12.17
В	FOR REVIEW	BS	2021.12.21
С	FOR PRICING	BS	2022.01.27
D	ISSUED FOR TENDER	B.S.	2022-04-22
Е	EXIT AND REPEAT WEIGH SIGN UPDATE	B.S.	2022-05-18






SCALES AS SHOWN		ORIGINAL SIZE A1
DRAWN	DESIGNED	APPROVED
C.NELLES	C. NELLES	B. STERLING
DRAWING VERIFIED	DESIGN VERIFIED	APPROVED DATE
P. FIEREK		2021.12.17

- 1	PROJECT		
	WAKA KOTAHI NZ TRANSPORT AGENCY		
-	RAKAIA SOUTHBOUND		
	WEIGH RIGHT PROGRAMME		
_	TITLE		
	STANDARD DETAILS		
	STATIC SIGNAGE - SHEET 3		
_	WSP PROJECT NO. (SUB-PROJECT)	SHEET NO.	REVISION
	5C4353-WSP-09-DR-	C-7102	D

Appendix D

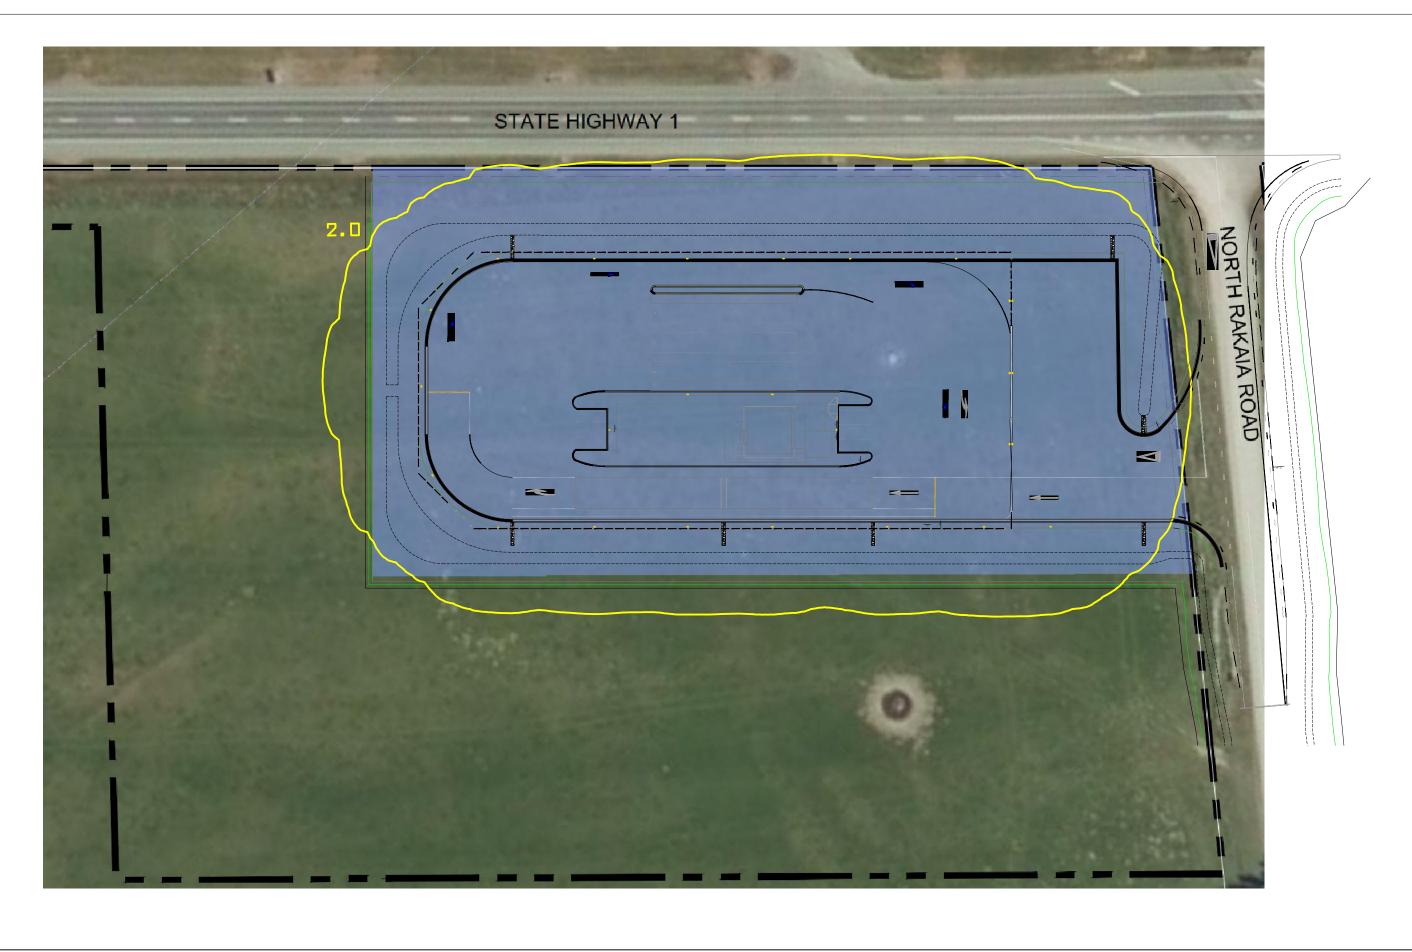

REVISION	AMENDMENT	APPROVED	DATE
Α	FOR TENDER	BS	2022.07.20

Original sheet size A1 (841x594) Plot Date 2022-07-20 at 4:31:18 PM





PO Box 1482 Christchurch 81

ELECTRICAL

 SCALES
 ORIGINAL SIZE

 NTS
 A1

 DRAWN
 DESIGNED
 APPROVED

 F. DEL MORAL
 F. DEL MORAL
 B. STERLING


 DRAWING VERIFIED
 DESIGN VERIFIED
 APPROVED DATE

 N. GRAHAM
 N. GRAHAM
 2022.07.20


TENDER

	WSP PROJECT NO. (SUB-PROJECT)	5C4353 WSD 01 DD	SHEET NO.	REVISION A
	2LX ISOLINE PLOT			
	SITE			
ı	TITI F			
	WEIGH RIGHT PRO	GRAMME		
	RAKAIA SOUTHBOI	JND		
	WAKA KOTAHI NZ 1	FRANSPORT AGENCY		
ı	PROJECT			

Appendix E

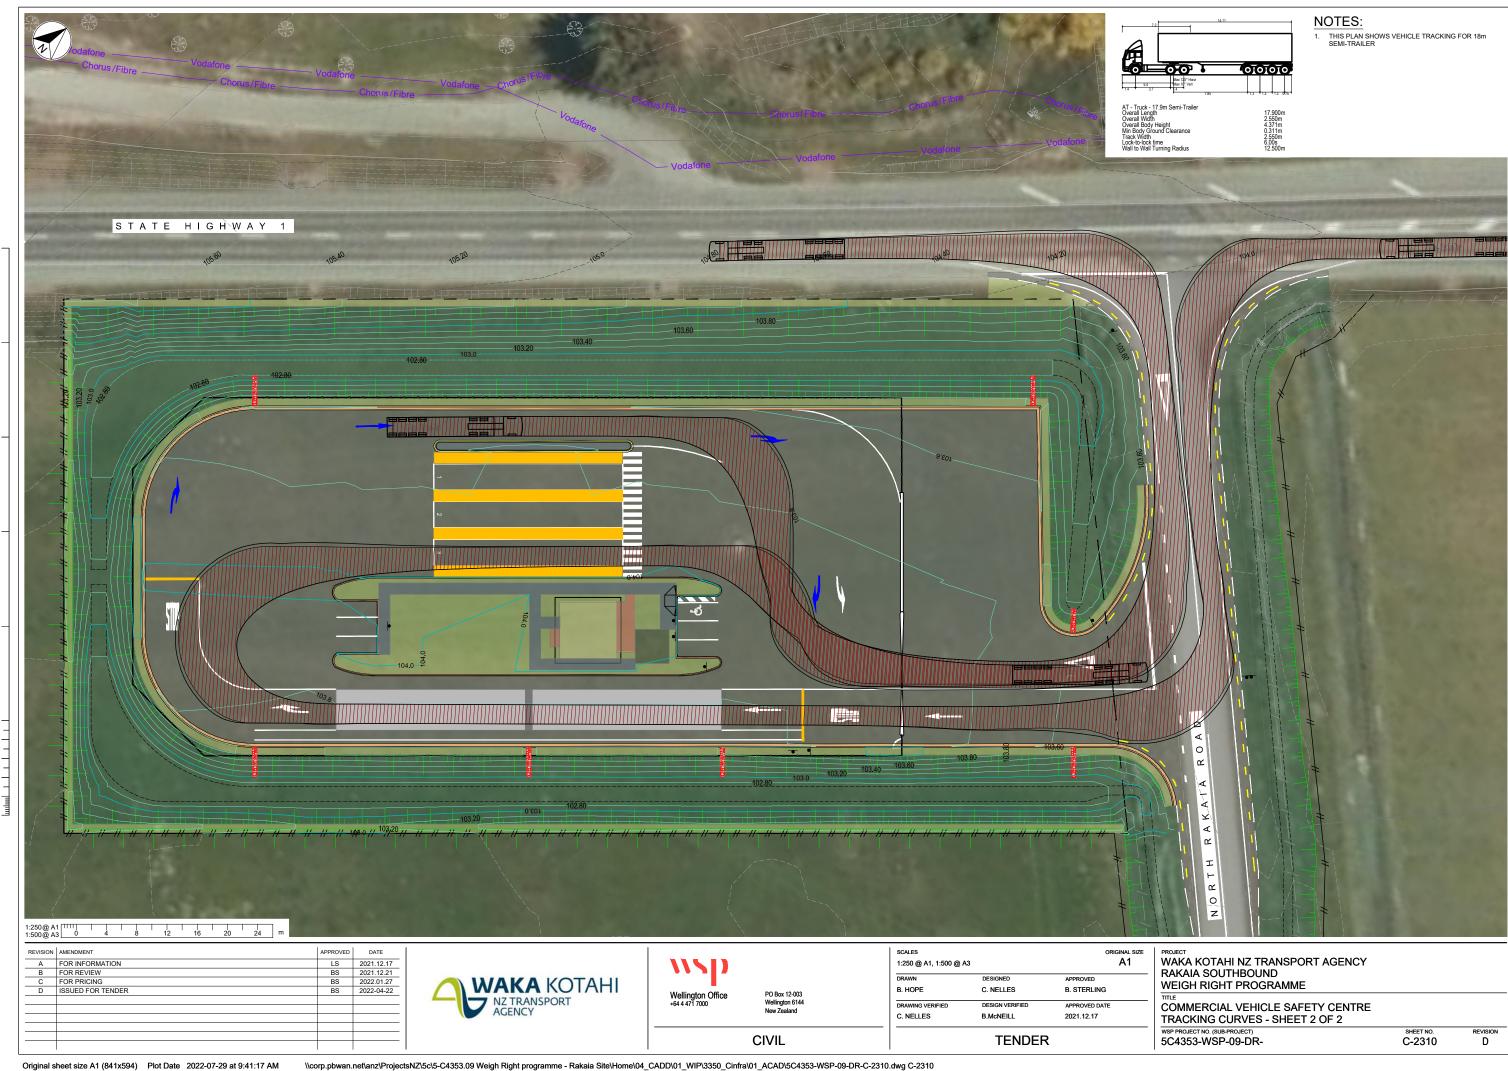

Appendix F

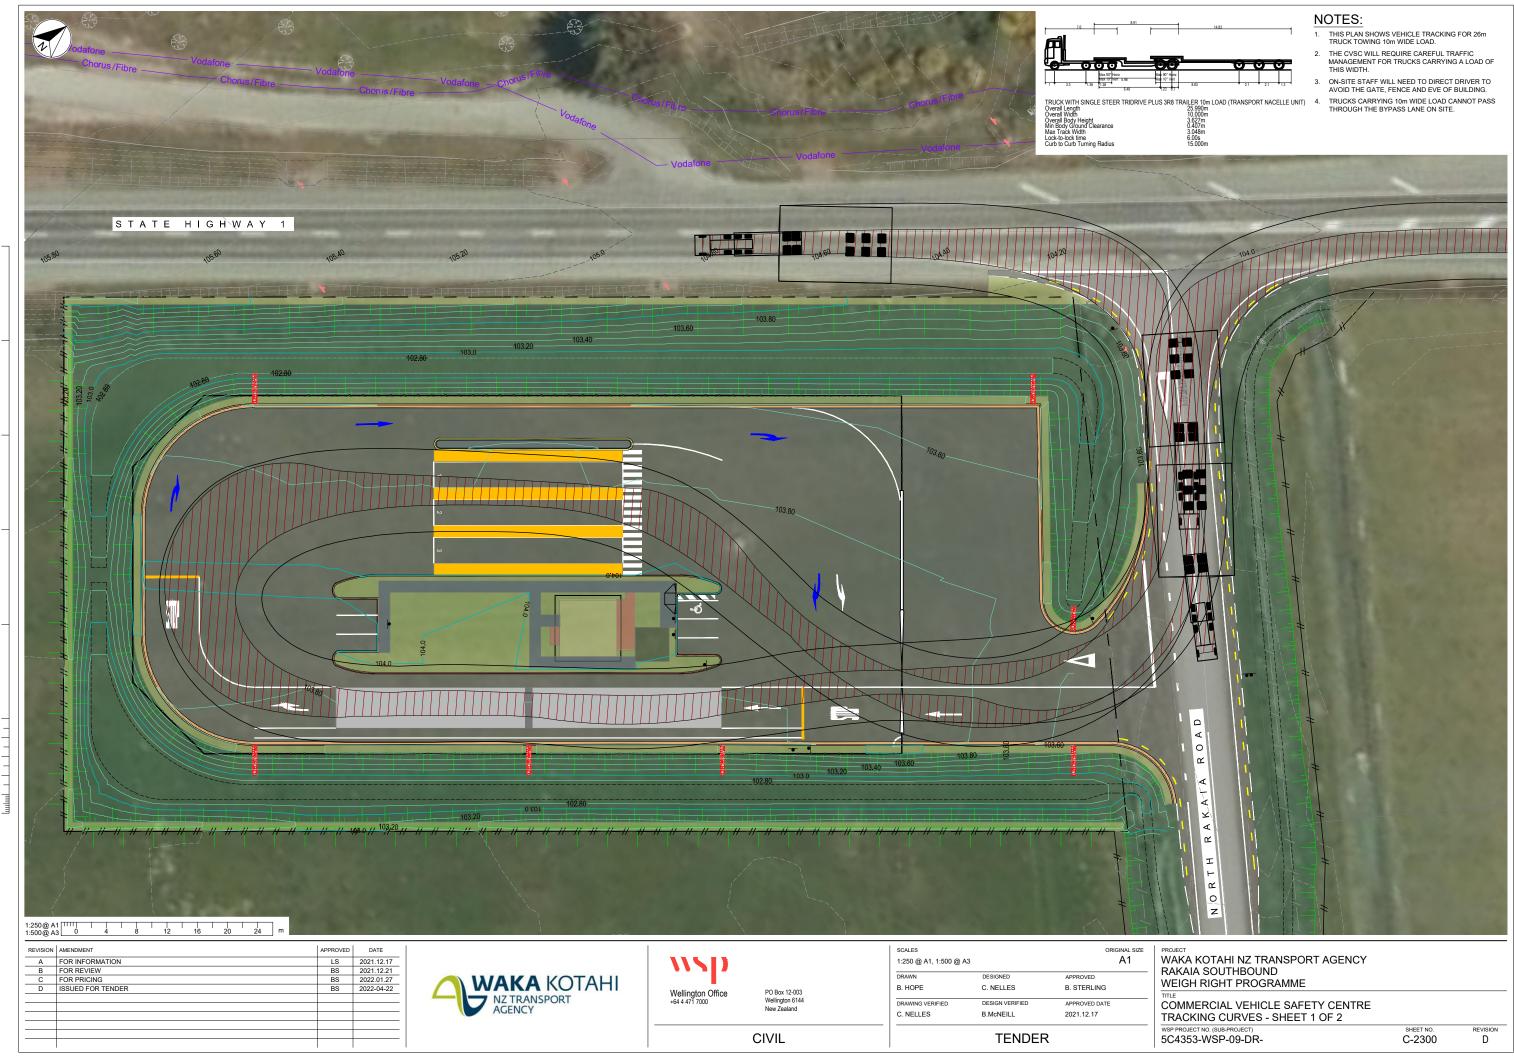

Appendix G

Hammond, Sam

From: Hammond, Sam

Sent: Monday, 9 May 2022 9:57 am

To: Andrew Mazey

Cc:Sterling, Brendan; Nelles, Cindy; Charlotte.Scotchbrook@selwyn.govt.nzSubject:RE: North Rakaia Road Design for Waka Kotahi Weigh Right Programme

Attachments: D190066 - s171 - Council Recommendation.pdf

Importance: High

Hi Andrew,

Waka Kotahi have agreed to the use of a de-acceleration lane for commercial vehicles traveling south and turning left onto North Rakaia Road. WSP are currently in the process of preparing plans which show this. These plans will be provided as soon as they become available.

On the basis that a de-acceleration lane will be provided which allows commercial vehicles to safety separate from the main traffic on SH1, can you **please confirm**:

- a. SDC transport have no other concerns with the proposal; and
- b. SDC will provide written approval of the upgrade works occurring to North Rakaia Road.

For context: Condition 8 of SDC's previous s171 recommendation (see attached – page 11) required the following:

8. That prior to the undertaking of construction works, the engineering plans and specifications relating to the upgrades to the local road shall be reviewed and approved by the Council's Asset Manager, Transportation.

Please give me a call or send me an email if you have any question.

Thanks,



Samuel Hammond

Graduate Planner – Resource Management BRP (Hons) - NZPI

T: +64 3 367 0058

From: Hammond, Sam

Sent: Friday, 25 March 2022 10:30 am

To: Andrew Mazey < Andrew. Mazey@selwyn.govt.nz>

Cc: Charlotte.Scotchbrook@selwyn.govt.nz; Nelles, Cindy Cindy.Nelles@wsp.com

Subject: North Rakaia Road Design for Waka Kotahi Weigh Right Programme

Hi Andrew,

Thanks for your response. We'll continue to speak to our client regarding the potential use of a de-acceleration zone. An update will be provided when we have one.

Waka Kotahi has agreed to amend the State Highway Maintenance Agreement <u>if required</u>. However, we've realised the purpose of the initial Notice of Requirement is

"to undertake maintenance, operation and use of, and improvements to the State Highway Network"

As North Rakaia Road is located within Designation TR7/NZTA-7, the maintenance of this 95m section of North Rakaia Road is covered by the designation. Can you please confirm this existing maintenance requirement is sufficient.

I have attached a copy of the initial Notice of Requirement document. Please refer to Page 10.

If you require clarification on this, please give me a call. Alternatively, Charlotte (SDC) may be able to assist.

Thanks,



Samuel Hammond

Graduate Planner – Resource Management BRP (Hons) - NZPI

T: +64 3 367 0058

From: Andrew Mazey < Andrew. Mazey@selwyn.govt.nz >

Sent: Thursday, 24 March 2022 6:07 PM

To: Hammond, Sam <Samuel.Hammond@wsp.com>

Cc: Nelles, Cindy <Cindy.Nelles@wsp.com>; Charlotte Scotchbrook <Charlotte.Scotchbrook@selwyn.govt.nz>

Subject: RE: North Rakaia Road Design for Waka Kotahi Weigh Right Programme

Hi Sam thanks – one last thing to clear up as you acknowledged below from my earlier points to follow up on. I am concerned how a unit can safely separate from the main traffic lane and de-accelerate from SH1 100km/hr environment and get itself turned into North Rakaia Rd (and proximity to main Rakaia Intersection etc)

Otherwise everything else OK

Thanks

Andrew

From: Hammond, Sam [mailto:Samuel.Hammond@wsp.com]

Sent: Monday, 21 March 2022 9:40 AM

To: Andrew Mazey < Andrew. Mazey@selwyn.govt.nz>

Cc: Nelles, Cindy <Cindy.Nelles@wsp.com>; Charlotte Scotchbrook <Charlotte.Scotchbrook@selwyn.govt.nz>

Subject: North Rakaia Road Design for Waka Kotahi Weigh Right Programme

Hi Andrew,

Please see the attached plan which shows tracking lines of vehicles making a left turn off SH1 onto North Rakaia Road. This plan will be included as an appendix to our Notice of Requirement and Outline Plan Application.

At this time, what further information does SDC require before providing transport approval?

Thanks,



Samuel Hammond

Graduate Planner – Resource Management BRP (Hons) - NZPI

T: +64 3 367 0058

From: Hammond, Sam

Sent: Wednesday, 16 March 2022 2:50 PM

To: Andrew Mazey <Andrew.Mazey@selwyn.govt.nz>

Cc: Nelles, Cindy < <u>Cindy.Nelles@wsp.com</u>>; <u>Charlotte.Scotchbrook@selwyn.govt.nz</u> **Subject:** RE: North Rakaia Road Design for Waka Kotahi Weigh Right Programme Hi Andrew,

Thanks for the quick response. Great to hear that most matters have been addressed.

I will make contact with our transport team and see if we can get some additional vehicle tracking plans which show a left turn off SH1. I will also follow up on the potential use of slip lanes (or lack thereof) in proximity to Main Rakaia Road.

Regarding the north bound site, I've had limited involvement. Last I heard it was on either the northern <u>or</u> southern side of Weavers Road. See below.



Thanks,



Samuel Hammond

Graduate Planner – Resource Management BRP (Hons) - NZPI

T: +64 3 367 0058

From: Andrew Mazey < Andrew. Mazey@selwyn.govt.nz >

Sent: Wednesday, 16 March 2022 2:38 PM


To: Hammond, Sam <Samuel.Hammond@wsp.com>

Cc: Nelles, Cindy < Cindy.Nelles@wsp.com; Charlotte Scotchbrook < Charlotte.Scotchbrook@selwyn.govt.nz>

Subject: RE: North Rakaia Road Design for Waka Kotahi Weigh Right Programme

Hi Sam thanks for the reply, that clears up nearly everything from my perspective, and yes 4 (i-ii) initial document will be fine.

The only thing still wondering about is that highlighted below in your return email. The tracking curves also seem a little strange that the don't represent the LH turn in from SH1 either. I would have thought they should have?

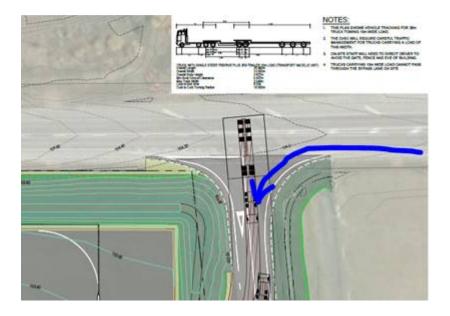

Also where is the northern approach CVSC site – south of the Rakaia Bridge I presume?

Thanks

Andrew

From: Hammond, Sam [mailto:Samuel.Hammond@wsp.com]

Sent: Wednesday, 16 March 2022 1:47 PM

To: Andrew Mazey < Andrew. Mazey@selwyn.govt.nz >

Cc: Nelles, Cindy <Cindy.Nelles@wsp.com>

Subject: North Rakaia Road Design for Waka Kotahi Weigh Right Programme

Hi Andrew,

As Cindy is on annual leave until Tuesday 22 March, I have responded as best I can.

Please see the sections in red as they relate to your queries:

1. Am I correct in understanding that this station only caters for southbound traffic along SH1? Yes, that is correct. A separate site is currently being designed to service northbound traffic along SH1. Is this indicated by the fact there is no upgrades of the highway to allow northbound vehicles to turn right into North Rakaia Rd from the highway that would typically be catered for by a marked right hand turn bay and localised widening of SH1? As above. This site will service southbound traffic only. Independent of that, equally there does not appear to be a dedicated left hand turn slip/deceleration lane for vehicles to turn left off SH1 into North Rakaia Rd to access the site and how this may work appropriately considering the proximity of the Main Rakaia Rd intersection. Below is an extract from our draft 'Notice of Requirement and Outline Plan Application'. This provides some information on the history of change of the project. Please note, this information is currently undergoing client review.

"Project Change

Since obtaining the approvals listed above, Traffic Planning Consultants Ltd (TPC) was consulted by Waka Kotahi to carry out a road safety audit to identify safety concerns that may affect the safety and performance of the proposed commercial vehicle safety centre. The audit found that commercial vehicles crossing State Highway 1 posed an unacceptable safety risk. As a result, separate north and southbound CVSC sites are proposed which do not require commercial vehicles to cross over lanes of oncoming traffic."

As with the previous design, WSP on behalf of Waka Kotahi is currently reviewing an independent road safety audit which identified and assessed site safety and performance. This audit will be provided to SDC when it becomes available.

- 2. I have subsequently been sent the emails showing the proposed North Rakaia Rd upgrade cross-sections etc. I don't believe the "rehabilitation" of the existing section of North Rakaia Rd as shown below is sufficient, in particular, the lack of upgraded/replaced basecourse and subbase layers to cater for the heavy vehicle loadings expected. We would expect a more thorough geotechnical and design assessment to accompany any engineering approvals. The rehabilitation of North Rakaia Road is proposed to be upgraded to a standard Waka Kotahi consider acceptable. As Waka Kotahi seeks to take over the operation and maintenance of this section of North Rakaia Road (see point 4 below), we believe the rehabilitation should be to a standard deemed appropriate by the operator. Any maintenance requirements will be the responsibility of Waka Kotahi.
- 3. Council would expect an independent road safety design audit of the scheme to be provided See point 1 above, plus heavy vehicle tracking curves etc to demonstrate heavy vehicles can safely enter/exit the site from both the highway and North Rakaia Rd as part of the engineering approval process See attached plans showing heavy vehicle tracking. These plans will be included as an appendix to the 'Notice of Requirement and Outline Plan Application'. Please confirm these plans are sufficient. If further plans are required, please advise.
- 4. From that indicated you are seeking to include a 95m section of North Rakaia Rd to be included in your designation as below. Correct. On that basis, in particular from a maintenance and operational perspective it would then be appropriate that Waka Kotahi are responsible for the ongoing maintenance of this section of North Rakaia Rd as really the predominate use is related to state highway purposes for vehicles access the station. Yes, we agree this is appropriate. This can be recorded in the State Highway Maintenance Agreement that Council has with Waka Kotahi which details the demarcation between the two road controlling authorities across the district. We have requested Waka Kotahi make contact with SDC directly to amend the existing State Highway Maintenance Agreement. In the meantime, we have requested that Waka Kotahi provides a document which:
 - i. States Waka Kotahi will be responsible for the ongoing maintenance of the relevant 95m long section of North Rakaia Road.
 - ii. States Waka Kotahi's intent to amend the State Highway Maintenance Agreement.

Will a document that states the above matters (i-ii) be sufficient to obtain conditional approval from SDC? This conditional approval will apply only while Waka Kotahi and SDC amend their existing State Highway Maintenance Agreement.

If you have any queries, please make contact.

Thanks,



Samuel Hammond

Graduate Planner – Resource Management BRP (Hons) - NZPI

T: +64 3 367 0058

From: Andrew Mazey < Andrew. Mazey@selwyn.govt.nz>

Sent: Monday, 14 March 2022 5:48 PM **To:** Nelles, Cindy < Cindy. Nelles@wsp.com>


Cc: Charlotte Scotchbrook < Charlotte. Scotchbrook@selwyn.govt.nz >

Subject: RE: North Rakaia Road Design for Waka Kotahi Weigh Right Programme

Hi Cindy, well it has been more than a few days but better late than never! Some questions and comments for you.

- 1. Am I correct in understanding that this station only caters for south bound traffic along SH1? Is this indicated by the fact there is no upgrades of the highway to allow north bound vehicles to turn right into North Rakaia Rd from the highway that would typically be catered for by a marked right hand turn bay and localised widening of SH1? Independent of that, equally there does not appear to be a dedicated left hand turn slip/deceleration lane for vehicles to turn left off SH1 into North Rakaia Rd to access the site and how this may work appropriately considering the proximity of the Main Rakaia Rd intersection.
- 2. I have subsequently been sent the emails showing the proposed North Rakaia Rd upgrade cross sections etc. I don't believe the "rehabilitation" of the existing section of North Rakaia Rd as shown below is sufficient, in particular the lack of upgraded/replaced basecourse and subbase layers to cater for the heavy vehicle

loadings expected. We would expect a more thorough geotechnical and design assessment to accompany any engineering approvals

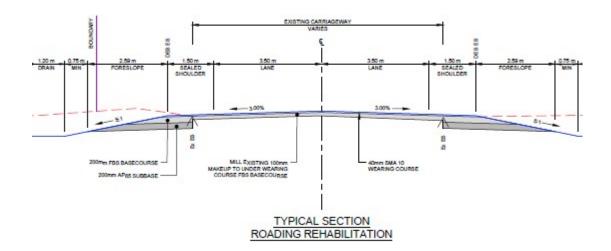

- 3. Council would expect an independent road safety design audit of the scheme to be provided, plus heavy vehicle tracking curves etc to demonstrate heavy vehicles can safely enter/exit the site from both the highway and North Rakaia Rd as part of the engineering approval process.
- 4. From that indicated you are seeking to include a 95m section of North Rakaia Rd to be included in your designation as below. On that basis, in particular from a maintenance and operational perspective it would then be appropriate that Waka Kotahi are responsible for the ongoing maintenance of this section of North Rakaia Rd as really the predominate use is related to state highway purposes for vehicles access the station. This can be recorded in the State Highway Maintenance Agreement that Council has with Waka Kotahi which details the demarcation between the two road controlling authorities across the district.



Otherwise generally OK with it overall – unless Charlotte has some red flags I am not aware of.

Thanks for your patience.

Andrew Mazey
Asset Manager Transportation

From: Andrew Mazey

Sent: Thursday, 24 February 2022 5:33 PM **To:** 'Nelles, Cindy' < Cindy. Nelles@wsp.com>

Cc: Charlotte Scotchbrook < Charlotte. Scotchbrook@selwyn.govt.nz>

Subject: RE: North Rakaia Road Design for Waka Kotahi Weigh Right Programme

Hi Cindy – thanks for the further info. Hope to get back to you in the next few days once I get my head around it and any relevant discussion with Charlotte.

Thanks

Andrew Mazey
Asset Manager Transportation

From: Nelles, Cindy [mailto:Cindy.Nelles@wsp.com]

Sent: Thursday, 10 February 2022 4:22 PM

To: Andrew Mazey < <u>Andrew.Mazey@selwyn.govt.nz</u>>; Graham Huggins < <u>Graham.Huggins@selwyn.govt.nz</u>> **Cc:** Hayden Muir < Hayden.Muir@selwyn.govt.nz>; McLeod, Jason < <u>Jason.McLeod2@wsp.com</u>>; Hammond, Sam

<<u>Samuel.Hammond@wsp.com</u>>; Charlotte Scotchbrook <<u>Charlotte.Scotchbrook@selwyn.govt.nz</u>>

Subject: RE: North Rakaia Road Design for Waka Kotahi Weigh Right Programme

Hi Andrew,

Looking to follow up with this and see where it is at. Please give me a call or let me know at your earliest convenience.

Kind Regards, Cindy



Cindy Nelles Civil Engineer She/Her

T: +64 3 431 1057 M: +64 27 252 1581 Cindy.Nelles@wsp.com

wsp.com/nz

From: Nelles, Cindy

Sent: Friday, 28 January 2022 1:29 PM

To: Andrew Mazey < Andrew.Mazey@selwyn.govt.nz >; Graham Huggins < Graham.Huggins@selwyn.govt.nz > Cc: Hayden Muir < Hayden.Muir@selwyn.govt.nz >; McLeod, Jason < Jason.McLeod2@wsp.com >; Hammond, Sam

<<u>Samuel.Hammond@wsp.com</u>>; <u>charlotte.scotchbrook@selwyn.govt.nz</u>

Subject: RE: North Rakaia Road Design for Waka Kotahi Weigh Right Programme

Hi Andrew,

Thanks for that. I have attached two additional showing the site overview that relate to the road and the CVSC station. This is that same project that WK started about 2 years ago, however there have been some changes to the concept. For example we are no longer doing any works in the State highway at the intersection.

I am also aware that there are some planning requirements to achieve this. Might be worthwhile to have a chat with Charlotte Scotchbrook (I think I managed to CC her in this email) as I believe she has been liaising with us on this topic. Below is a message from our Planner Sam Hammond.

WSP on behalf of Waka Kotahi will lodge a Notice of Requirement and Outline Plan Application providing for the construction, operation, and maintenance of a CVSC within Designation TR7 (OSDP) / NZTA-7 (PSDP). These works include the construction of:

- A weight bridge
- Tier 1.5 Compliance Building
- Bypass land
- Inspection bays
- Staff and visitor parking
- Lighting
- Onsite greywater and wastewater disposal
- Onsite stormwater disposal
- Site fencing

As part of this application, the proposed activity (CVSC) must comply with the conditions of Designation TR7. Specifically:

Designation TR7:

Prior to construction works being undertaken, engineering plans and specifications relating to the upgrade of the local road to be reviewed and approved by Council's Asset Manager, Transportation

The purpose of this email is to obtain written approval for the works occurring to North Rakaia Road located within the boundary of Designation TR7 / NZTA-7. Approval from SDC is required for the following reasons:

- 1. SDC is the landowner/operator of North Rakaia Road. Written approval <u>may</u> be required to fulfill the NOR consultation requirements.
- 2. To meet the condition of Designation TR7

WSP Planner, Samuel Hammond has been in contact with SDC Planner, Charlotte Scotchbrook. Both parties agreed that the following forms will be sufficient in providing written approval of the works proposed to North Rakaia Road within the boundary of Designation TR7:

- A. SDC's standard Form 8A signed by SDC Asset Manager Transportation.
- B. Plans showing the proposed works to North Rakaia Road within the boundary of Designation TR7 signed by SDC Asset Manager -Transporation.

Note: The signed Form 8A and accompanying plans do not negate the need for a Notice of Requirement and Outline Plan application to be lodged with SDC. The signed Form 8A and accompanying plans will be included within the Notice of Requirement and Outline Application.

Please let me know if you require any more information. I have attached the form and the designation plan for your approval.

Cheers, Cindy



Cindy Nelles Civil Engineer She/Her T: +64 3 431 1057 M: +64 27 252 1581 Cindy.Nelles@wsp.com

wsp.com/nz

From: Andrew Mazey < Andrew. Mazey@selwyn.govt.nz >

Sent: Tuesday, 25 January 2022 5:47 PM

To: Nelles, Cindy <Cindy.Nelles@wsp.com>; Graham Huggins <Graham.Huggins@selwyn.govt.nz>

Cc: Hayden Muir < Hayden.Muir@selwyn.govt.nz >

Subject: FW: North Rakaia Road Design for Waka Kotahi Weigh Right Programme

Hi Cindy, I presume from what you have provided that Waka Kotahi are continuing with the original plan to provide a SH1 Weigh Right Station just north of the Rakaia Bridge – that seemed to be put on hold from 1-2 years ago due to some difficulties/objections at the time.

It was Councils requirement at the time that North Rakaia Rd be upgraded as part of this for the short section involved relating to providing sealed access to the Station – and details for Councils prior approval would be provided.

If this is indeed the case relating to the original Station proposal and required access to North Rakaia Rd, Graham can check those proposed construction details for you and advise accordingly. An overall station layout plan would be helpful for context.

Thanks in advance

Andrew Mazey
Asset Manager Transportation

From: Hayden Muir

Sent: Friday, 14 January 2022 2:31 PM

To: Andrew Mazey < Andrew. Mazey@selwyn.govt.nz >

Cc: Graham Huggins < <u>Graham.Huggins@selwyn.govt.nz</u>>; Murray Washington

<Murray.Washington@selwyn.govt.nz>

Subject: FW: North Rakaia Road Design for Waka Kotahi Weigh Right Programme

Hi Andrew,

Not sure if you have knowledge of this Waka Kotahi project but are you able to follow up with Cindy on what the process would be for consenting this?

Thanks Hayden

From: Nelles, Cindy [mailto:Cindy.Nelles@wsp.com]

Sent: Friday, 14 January 2022 1:53 pm

To: Hayden Muir < Hayden. Muir@selwyn.govt.nz >

Subject: North Rakaia Road Design for Waka Kotahi Weigh Right Programme

Hello Hayden,

I was speaking to Simon O'Dea in our office here at WSP and he said you might be able to help me with this.

I am working on the weight Right Programme for Waka Kotahi and our current design involves upgrading north Rakaia Road (the gravel road immediately north of the Rakaia Bridge). Here is a plan of what we are proposing. I know that Jacobs had previously shown that they would be upgrading this road when they were doing the design however I presume Jacobs has not spoke to you about their design so this will be brand new information so please give me a call if you would like to discuss.

Please let me know what your requirements are for this work to proceed and what needs to happen to get this across the line.

Thank You, Cindy



Cindy NellesCivil Engineer
She/Her

T: +64 3 431 1057 M: +64 27 252 1581 Cindy.Nelles@wsp.com

wsp.com/nz

NOTICE: This communication and any attachments ("this message") may contain information which is privileged, confidential, proprietary or otherwise subject to restricted disclosure under applicable law. This message is for the sole use of the intended recipient(s). Any unauthorized use, disclosure, viewing, copying, alteration, dissemination or distribution of, or reliance on, this message is strictly prohibited. If you have received this message in error, or you are not an authorized or intended recipient, please notify the sender immediately by replying to this message, delete this message and all copies from your e-mail system and destroy any printed copies.

-I AFmHhHzd.IzBITWfa4Hgs7pbKI



2 Norman Kirk Drive, Rolleston 7614 PO Box 90, Rolleston 7643 Phone: 0800 SELWYN (735 996) Fax: (03) 347-2799 www.selwyn.govt.nz | www.selwynlibrarie

www.selwyn.govt.nz | www.selwynlibraries.co.nz www.selwyn.getsready.net



2 Norman Kirk Drive, Rolleston 7614 PO Box 90, Rolleston 7643 Phone: 0800 SELWYN (735 996) Fax: (03) 347-2799 www.selwyn.govt.nz | www.selwynlibraries.co.nz www.selwyn.getsready.net



2 Norman Kirk Drive, Rolleston 7614 PO Box 90, Rolleston 7643 Phone: 0800 SELWYN (735 996) Fax: (03) 347-2799

www.selwyn.govt.nz | www.selwynlibraries.co.nz www.selwyn.getsready.net




2 Norman Kirk Drive, Rolleston 7614 PO Box 90, Rolleston 7643 Phone: 0800 SELWYN (735 996)

Fax: (03) 347-2799

www.selwyn.govt.nz | www.selwynlibraries.co.nz

www.selwyn.getsready.net

Appendix H

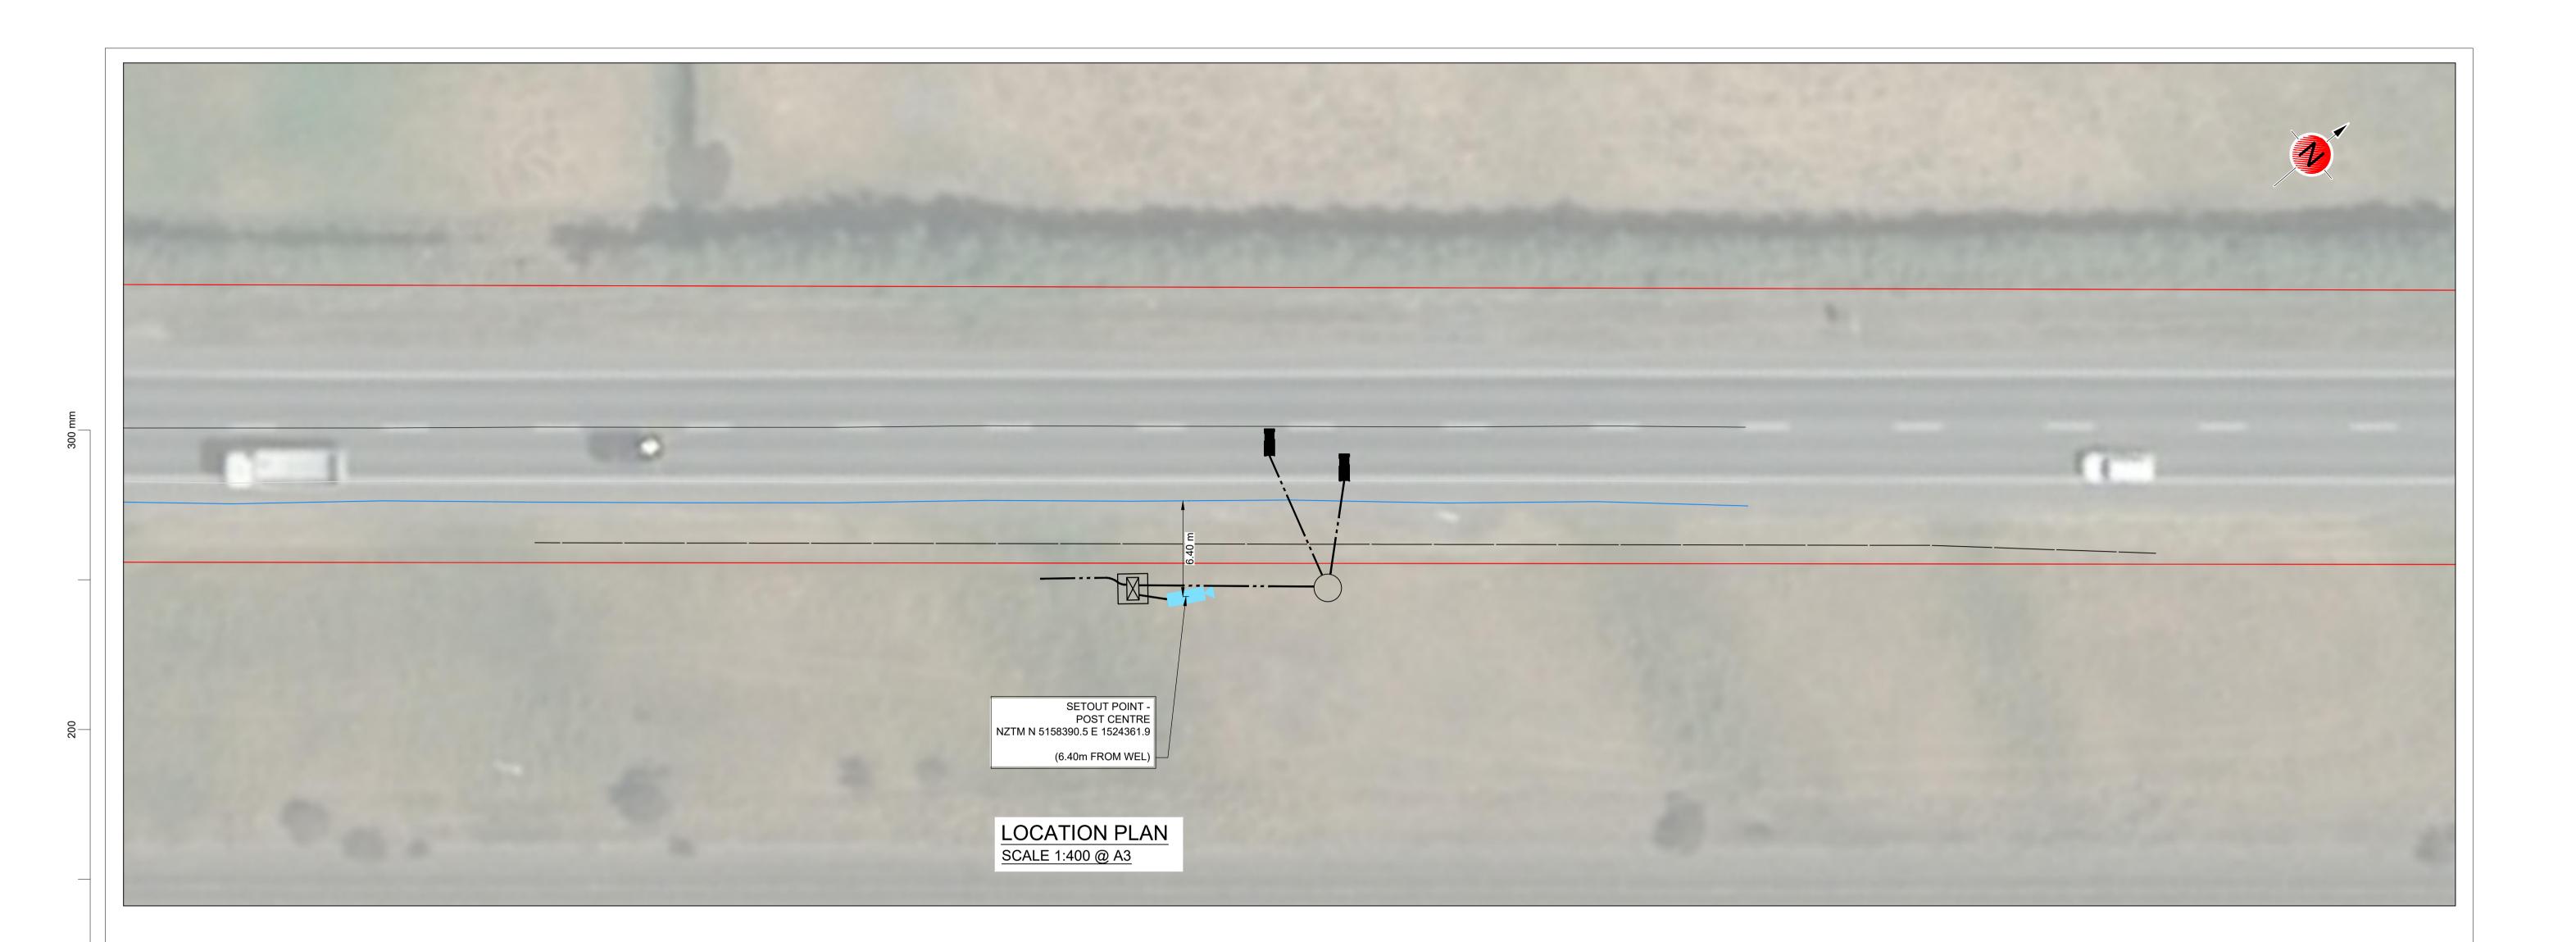

PRELIMINARY FOR INFORMATION ONLY

5-C4353.09





PO Box 1482 Christchurch 8140 New Zealand

CIVIL

AS SHOWN

DRAWN

DESIGNED

APPROVED

DRAWING VERIFIED

CONCEPT DESIGN

SCALES

ORIGINAL SIZE
A1

WAKA KOTAHI NZ TRANSPORT AGENCY
SH1 - RAKAIA
WEIGH RIGHT PROGRAMME

TITLE
SOUTH BOUND APPROACH WIM & ANPR SCREENING
GENERAL LAYOUT

WSP PROJECT NO. (SUB-PROJECT)
SHEET NO. REVISION

03 RAK ITS

